

WALL LEGEND

Symbol	Description	Thickness	Material	Notes
---	1/2" CMU	1/2"	Concrete Masonry Unit	
---	1/2" CMU with GFI	1/2"	Concrete Masonry Unit with GFI	
---	1/2" CMU with GFI and Insulation	1/2"	Concrete Masonry Unit with GFI and Insulation	
---	1/2" CMU with GFI and Insulation and Membrane	1/2"	Concrete Masonry Unit with GFI and Insulation and Membrane	
---	1/2" CMU with GFI and Insulation and Membrane and Sealant	1/2"	Concrete Masonry Unit with GFI and Insulation and Membrane and Sealant	
---	1/2" CMU with GFI and Insulation and Membrane and Sealant and Finish	1/2"	Concrete Masonry Unit with GFI and Insulation and Membrane and Sealant and Finish	

1. All walls shall be finished with the material shown in the column adjacent to the wall.
 2. The wall shall be finished with the material shown in the column adjacent to the wall.
 3. The wall shall be finished with the material shown in the column adjacent to the wall.
 4. The wall shall be finished with the material shown in the column adjacent to the wall.
 5. The wall shall be finished with the material shown in the column adjacent to the wall.


Plumbing Fixture Requirements

Room	Area (S.F.)	Ratio Requirement (Occupant / S.F.)	Occupant Load (Area x Ratio)
Lounge / Clubroom (A3)	1,200	0.01	12
Conference Room (A2)	1,200	0.01	12
Male Occupants (Total / 2)			64
Female Occupants (Total / 2)			64


Fixture	Ratio Requirement (Occupant / S.F.)	Calculations	Number of Required Fixtures
Male Water Closet	1 per 25	64 / 25 = 2.56	3
Male Urinal	1 per 15	64 / 15 = 4.27	5
Female Water Closet	1 per 25	64 / 25 = 2.56	3
Female Urinal	1 per 15	64 / 15 = 4.27	5
Male Lavatories	1 per 25	64 / 25 = 2.56	3
Female Lavatories	1 per 25	64 / 25 = 2.56	3
Male Showers	1 per 25	64 / 25 = 2.56	3
Female Showers	1 per 25	64 / 25 = 2.56	3
Drinking Fountains	1 per 25	64 / 25 = 2.56	3
Service Sinks	1		1

Summary Calculation / Determination of Design Values

Fixture Type	Design Value
Male Water Closet	3
Male Urinal	5
Female Water Closet	3
Female Urinal	5
Male Lavatories	3
Female Lavatories	3
Male Showers	3
Female Showers	3
Drinking Fountains	3
Service Sinks	1

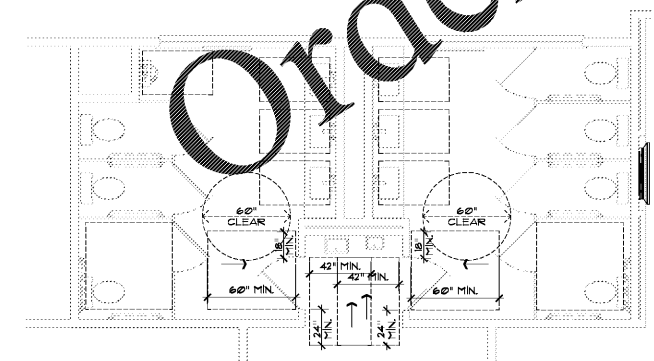

2 Fitness - Bathrooms Mobility Diagram
Scale: 1/4" = 1'-0"

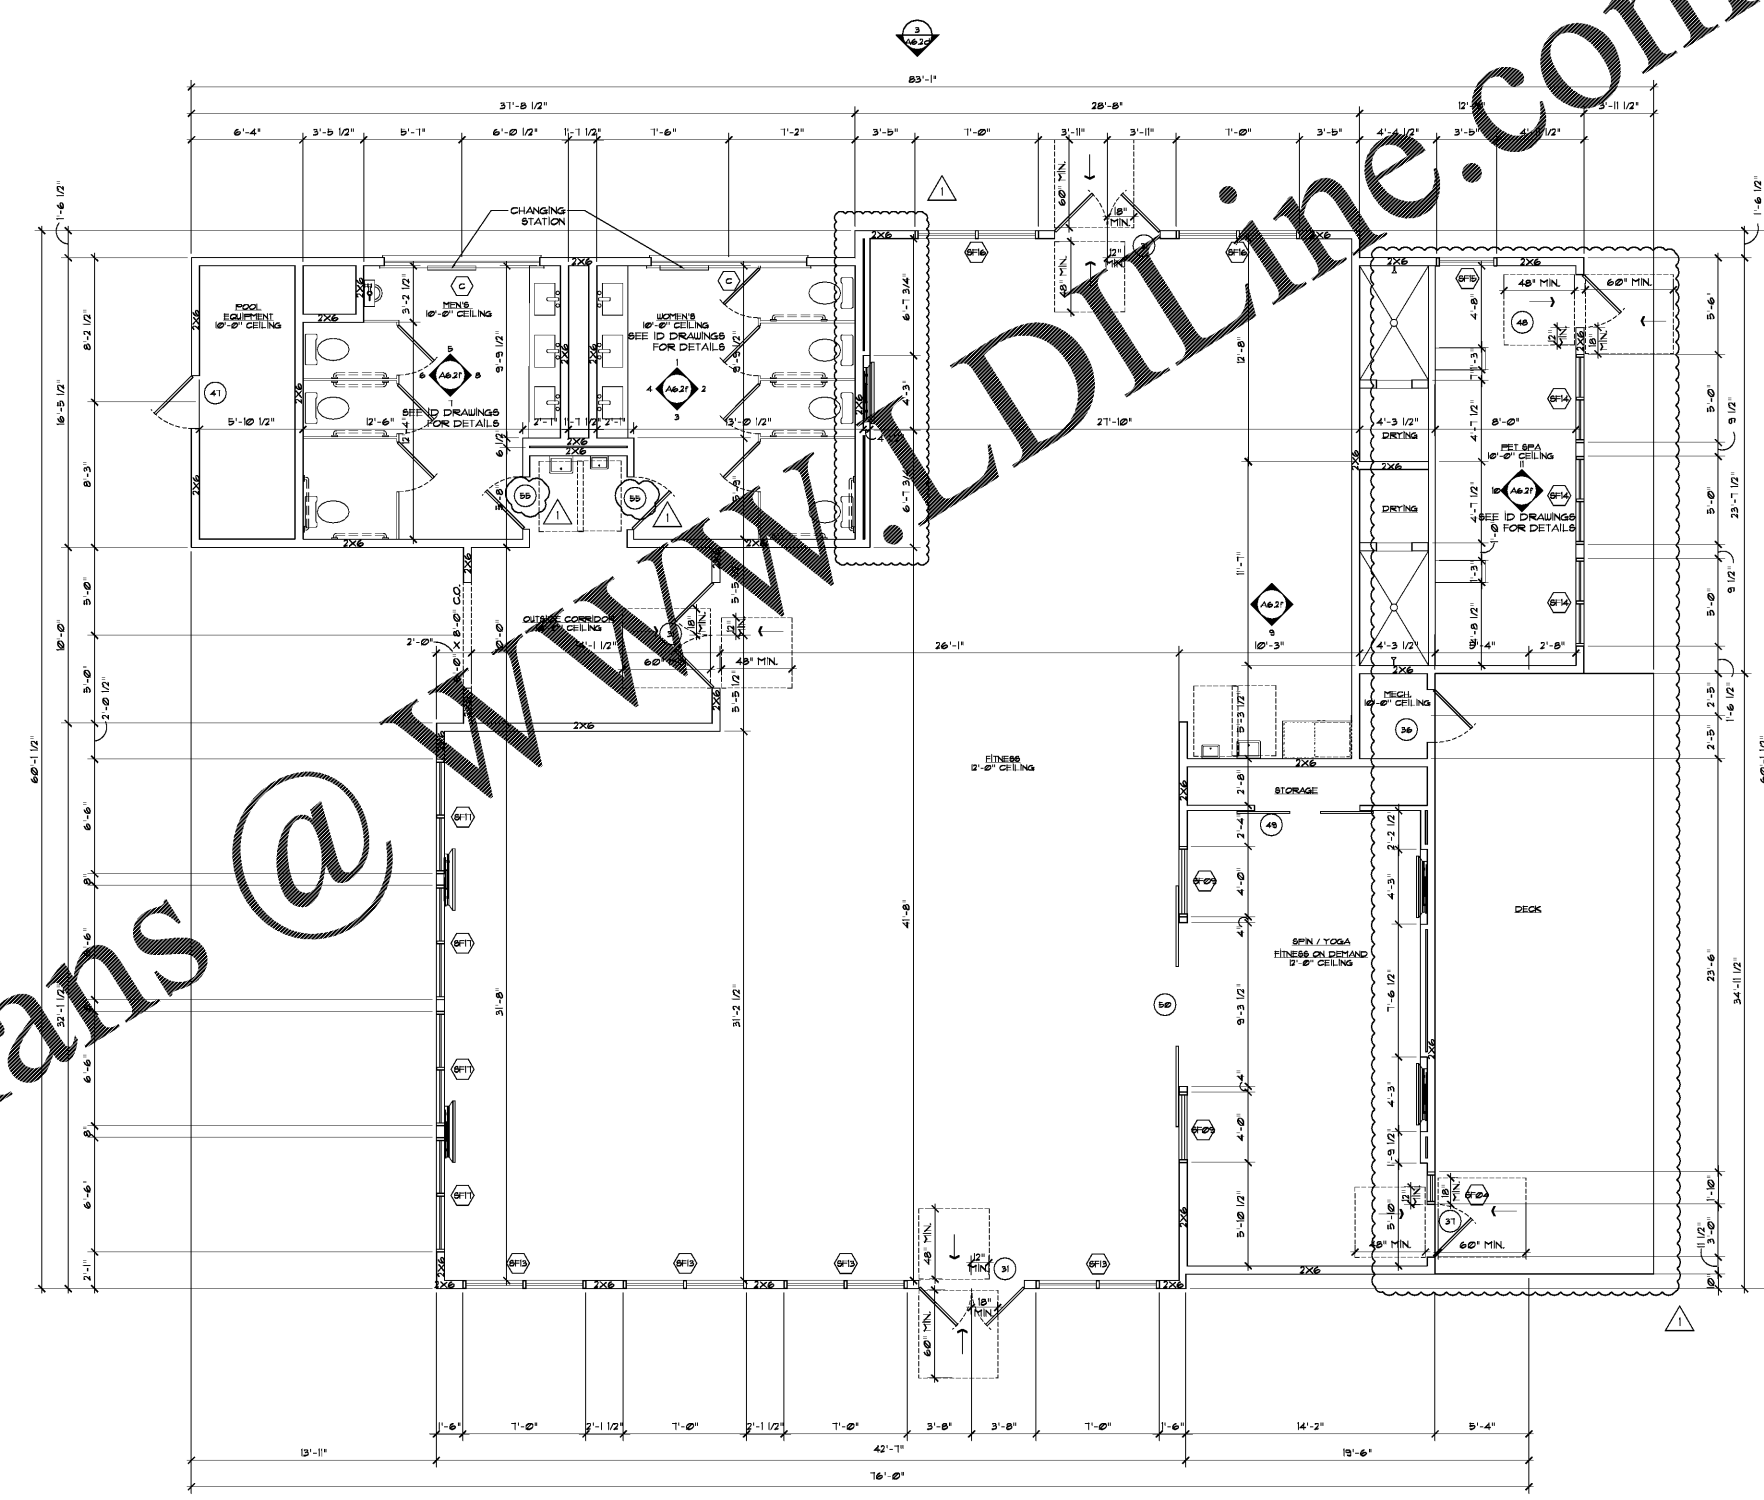

2 Fitness - Building Plan
Scale: 1/4" = 1'-0"

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Seal

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Project: 1928.00
 CADD File: MSAM
 Drawn By: NVK
 Checked By: SGS

Permit Release:
 May 15, 2020
 Construction Release Set:
 May 15, 2020

Revisions

No.	Date	Description
1	03/19/21	Owner Comments

ASI / RFI Revisions

No.	Date	Description
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Borough 33
 an Apartment Community by
 33 Broad MF, LLC
 in Chattanooga, Tennessee

Drawing Title:
 Fitness
 Building Plan

A6.2b

ISSUED FOR CONSTRUCTION