


- GENERAL NOTES**
1. THESE DRAWINGS ARE DIAGRAMMATIC ONLY AND ARE NOT TO BE SCALED. FIELD VERIFY ALL DIMENSIONS, PIPE SIZES, AND INVERTS REFER TO ARCHITECTURAL SHEETS FOR DIMENSIONS AND LOCATIONS OF ALL PLUMBING FIXTURES AND EQUIPMENT.
  2. ALL DOMESTIC COLD WATER SUPPLY PIPING, DOMESTIC HOT WATER SUPPLY PIPING, DOMESTIC HOT WATER RETURN PIPING, ROOF DRAIN BODIES, OVERFLOW ROOF DRAIN BODIES, 1" OF VERTICAL RAIN LEADER PIPING FROM DRAINS, AND ALL HORIZONTAL STORM WATER PIPING MUST BE INSULATED AND IDENTIFIED PER SPECIFICATIONS.
  3. PROVIDE SLEEVES AND FIRE RATED ASSEMBLIES FOR ALL PENETRATIONS OF FIRE RATED FLOORS AND WALLS. REFER TO ARCHITECTURAL SHEETS FOR FIRE RATED ASSEMBLY DETAILS AND FIRE RATED FLOOR AND WALL DESIGNATIONS.

City of Asheville/ Parks & Recreation  
**DR. WESLEY GRANT  
 CENTER EXPANSION**  
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DESIGNER  
**CLARK NEXSEN**  
 333 FAYETTEVILLE STREET, SUITE 1000  
 RALEIGH, NORTH CAROLINA 27601  
 919-828-1876  
 CLARK NEXSEN LICENSE NUMBER: C-1028

- KEY NOTES**
1. INSTALL RD-1 AND OD-1 IN LOW POINTS OF ROOF. LOCK ALL DRAINS IN PLACE WITH UNDERDECK CLAMP. COORDINATE DRAIN LOCATIONS WITH ROOFING CONTRACTOR AND STRUCTURAL CONTRACTOR. SEE PLUMBING SPECIALTIES SCHEDULE.
  2. INSTALL WCO AT THE BASE OF STORM DRAIN RISER PIPING. SEE WALL CLEANOUT DETAIL AND PLUMBING SPECIALTIES SCHEDULE.
  3. INSTALL DSN-1 AT OVERFLOW DRAIN PIPING OUTLET. INSTALL AT 12" ABOVE FINISHED GRADE. PROVIDE HINGED GRATED COVER. SEE DOWNSPUT NOZZLE PIPING DETAIL AND PLUMBING SPECIALTIES SCHEDULE.
  4. INSTALL GCO ON ALL EXTERIOR CLEANOUT RISERS. INSTALL FLUSH WITH FINISHED SURFACE. COORDINATE WITH OUTSIDE FINISH CONCRETE CONTRACTOR FOR FINAL ELEVATIONS. SEE 2 WAY GRADE CLEANOUT DETAIL AND PLUMBING SPECIALTIES SCHEDULE.
  5. INSTALL END OF LINE CO FOR STORM DRAIN PIPING.

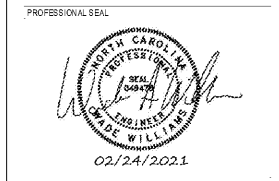

SUBMITTAL  
 03.12.2021  
**CONSTRUCTION DOCUMENTS**

REVISIONS


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KEY PLAN


SHEET  
**FIRST FLOOR PLAN - STORM  
 PIPING**

**PL103**

DESIGN: DKB  
 DRAWN: DLR  
 REVIEW: WAW  
 CN 7904-A

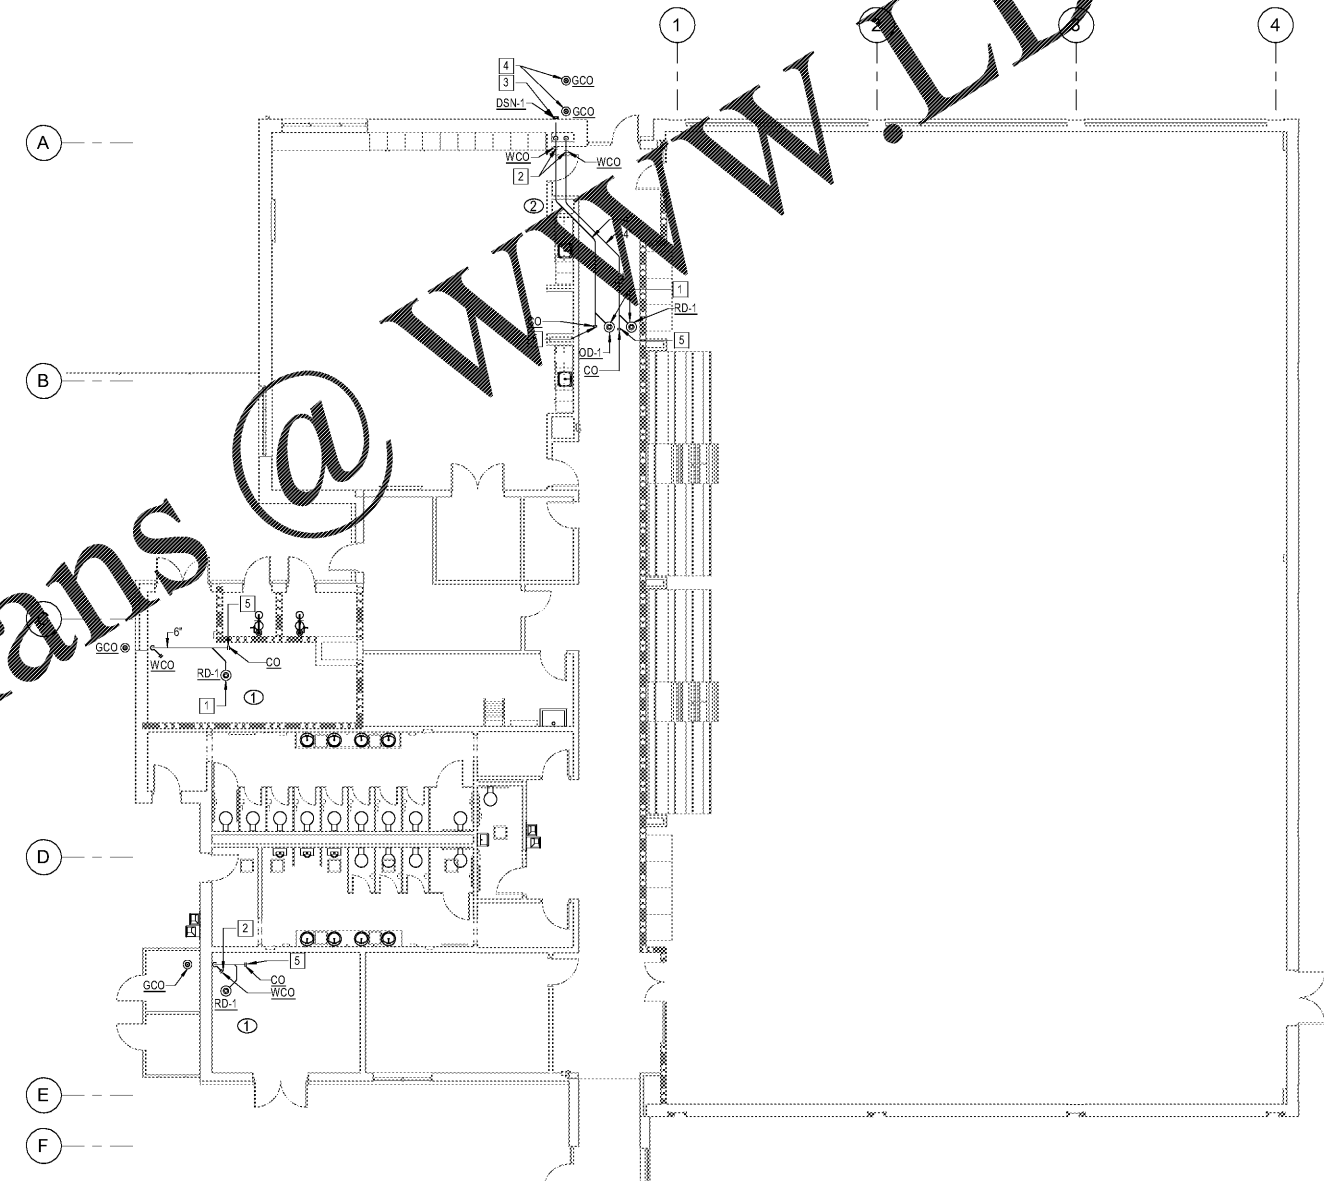

**FIRST FLOOR PLAN - STORM PIPING**  
 1/8" = 1'-0"

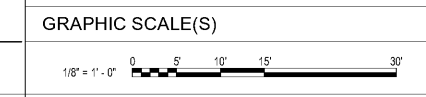

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