



Lancaster County, South Carolina
Heath Springs Soccer Complex
Lancaster County Parks & Recreation Soccer Complexes

200 Boyd Falls Road
Heath Springs, SC 29058



Revisions:

1	County Permit Review 1	11/20/20
---	------------------------	----------


Project No: 080703
Date: 10/09/2020

Sheet Name:
FOUNDATION AND ROOF FRAMING PLAN

S-101

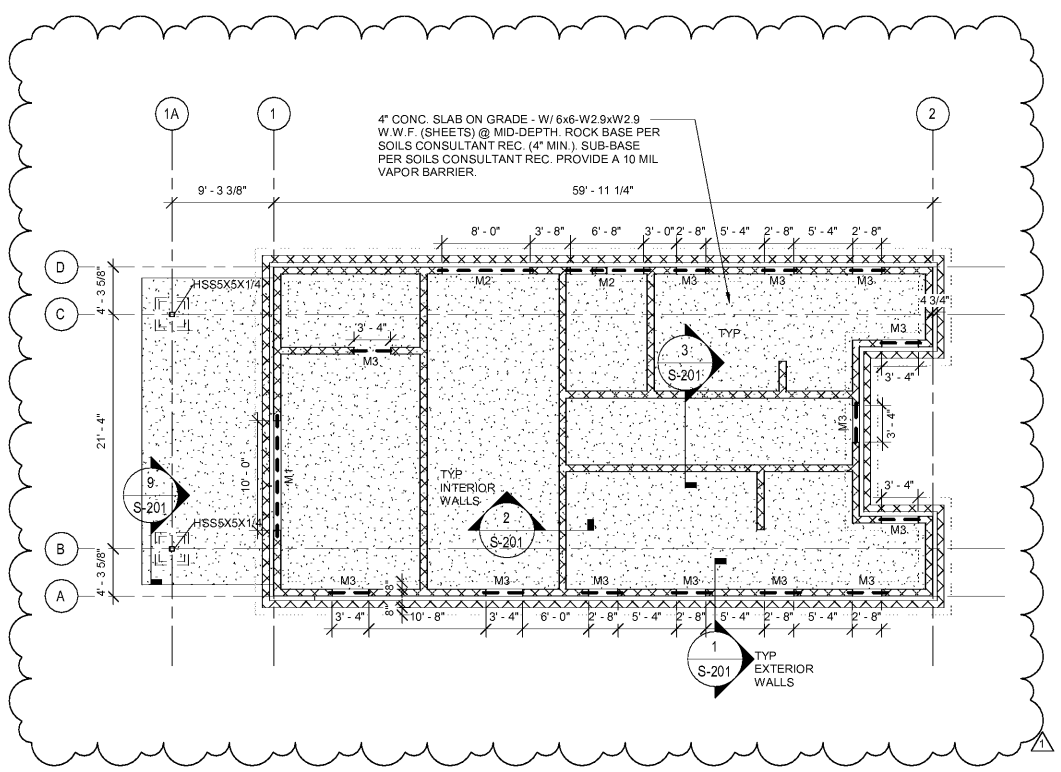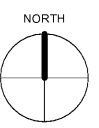


FOUNDATION PLAN
SCALE: 1/8" = 1'-0"

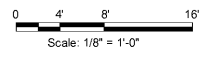


FOUNDATION PLAN NOTES:

- REFERENCE FINISH FLOOR ELEVATION = 0'-0". SEE CIVIL DRAWINGS FOR ACTUAL FINISH FLOOR ELEVATION RELATIVE TO EXTERIOR RADES.
- SEE SECTION CUTS FOR TOP OF FOOTING ELEVATIONS AND DIMENSIONS.
- ALL LAP SPLICES OF THE CONTINUOUS REINFORCING SHALL BE A MINIMUM OF 3'-0". LAP SPLICE SCHEDULE ON SHEET S-002.
- EXTEND ALL CONTINUOUS FOOTING REINFORCING THROUGH SPREAD FOOTINGS. CENTER FOOTING ON COLUMNS AND WALLS UNLESS OTHERWISE NOTED.
- TOP OF FOOTING ELEVATIONS SHALL BE VERIFIED AND COORDINATED WITH THE CIVIL SITE DRAWINGS. ADVISE THE STRUCTURAL ENGINEER OF ANY DISCREPANCIES BEFORE PROCEEDING.
- SEE ARCHITECTURAL AND CIVIL DRAWINGS FOR ALL EXTERIOR CONCRETE FLATWORK REQUIRED.
- REFERENCE ARCHITECTURAL DRAWINGS FOR DRAINS, SLOPES AND OTHER FLOOR DEPRESSIONS NOT SHOWN.
- CONTRACTOR TO VERIFY ALL DIMENSIONS WITH ARCHITECTURAL DRAWINGS. NOTIFY ENGINEER IMMEDIATELY OF ANY DISCREPANCIES PRIOR TO FABRICATION. VERIFY ALL WINDOW AND DOOR OPENINGS WITH ARCHITECTURAL.

MASONRY UNIT SCHEDULE			
MARK	SIZE	REINFORCEMENT	BRG. END
M1	8"X16"	(2) #5 BOT	8"
M2	8"X16"	(1) #5 BOT	8"
M3	8"X8"	(1) #5 BOT	8"

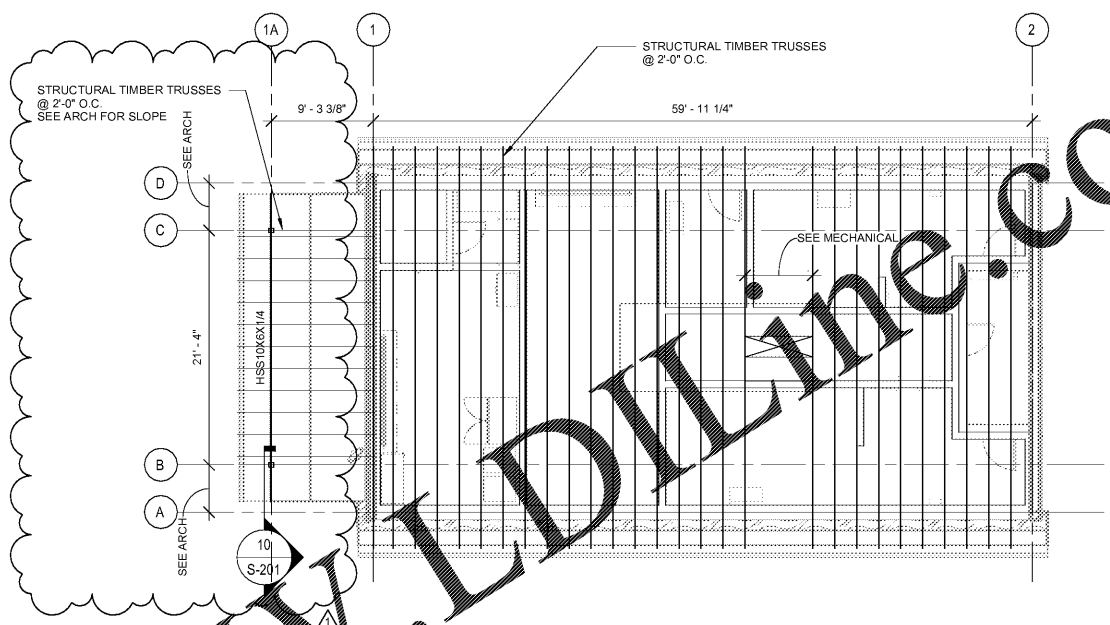

ROOF FRAMING PLAN
SCALE: 1/8" = 1'-0"

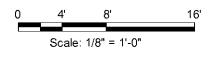

ROOF FRAMING NOTES:

- ROOF CONSTRUCTION: 15/32" APA RATED SHEATHING, SPAN RATING 48/24. EXPOSURE 1, NAILED TO FRAMING. PANEL EDGES SHALL BE SUPPORTED BY TWO PANEL EDGE CLIPS PER SPAN OR PROVIDE TONGUE AND GROOVE EDGES (U.O.N.). THE MINIMUM AREA OF EACH SHEET SHALL BE 8 SQUARE FEET. ATTACH ALL PANEL EDGES TO SUPPORTS, EDGE MEMBERS AND BLOCKING WITH 10d RINK-SHANK NAILS AT 6" O.C. AND 12" O.C. IN FIELD, UNLESS OTHERWISE NOTED ON FRAMING PLANS. AT ROOF EDGE AND CORNER ZONES, SEE SHEET S-001. INCREASE PANEL EDGE NAILING TO 3" AND 4" O.C. IN FIELD.
- SEE ARCHITECTURAL DRAWINGS FOR EDGE OF ROOF DIMENSIONS
- SEE ARCHITECTURAL DRAWINGS FOR ROOF SLOPES.
- LOCATION OF ALL OPENINGS, ROOF PENETRATIONS, AND THEIR CORRESPONDING STRUCTURAL FRAMING SHALL BE COORDINATED BY THE CONTRACTOR WITH ARCHITECTURAL, MECHANICAL, ELECTRICAL, PLUMBING AND FIRE PROTECTION DRAWINGS PRIOR TO FABRICATION AND INSTALLATION.
- CONTRACTOR SHALL VERIFY ALL DIMENSIONS WITH ARCHITECTURAL DRAWINGS AND NOTIFY ENGINEER IMMEDIATELY OF ANY DISCREPANCIES PRIOR TO FABRICATION AND INSTALLATION.
- ALL ROOF SHEATHING SHALL BE INSTALLED WITH FACE GRAIN PERPENDICULAR TO SUPPORTS
- WOOD TRUSSES AND WOOD SHEATHING TO BE FIRE-RETARDANT TREATED.

Order Plans @ WWW.LDILINE.COM