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STAMPS



9/30/20

MIDSOUTH  
CARPENTER'S  
TRAINING  
TRUST

LA VERGNE, TN

PROJECT NUMBER 18101  
ISSUE DATE  
For Permit 09.30.20

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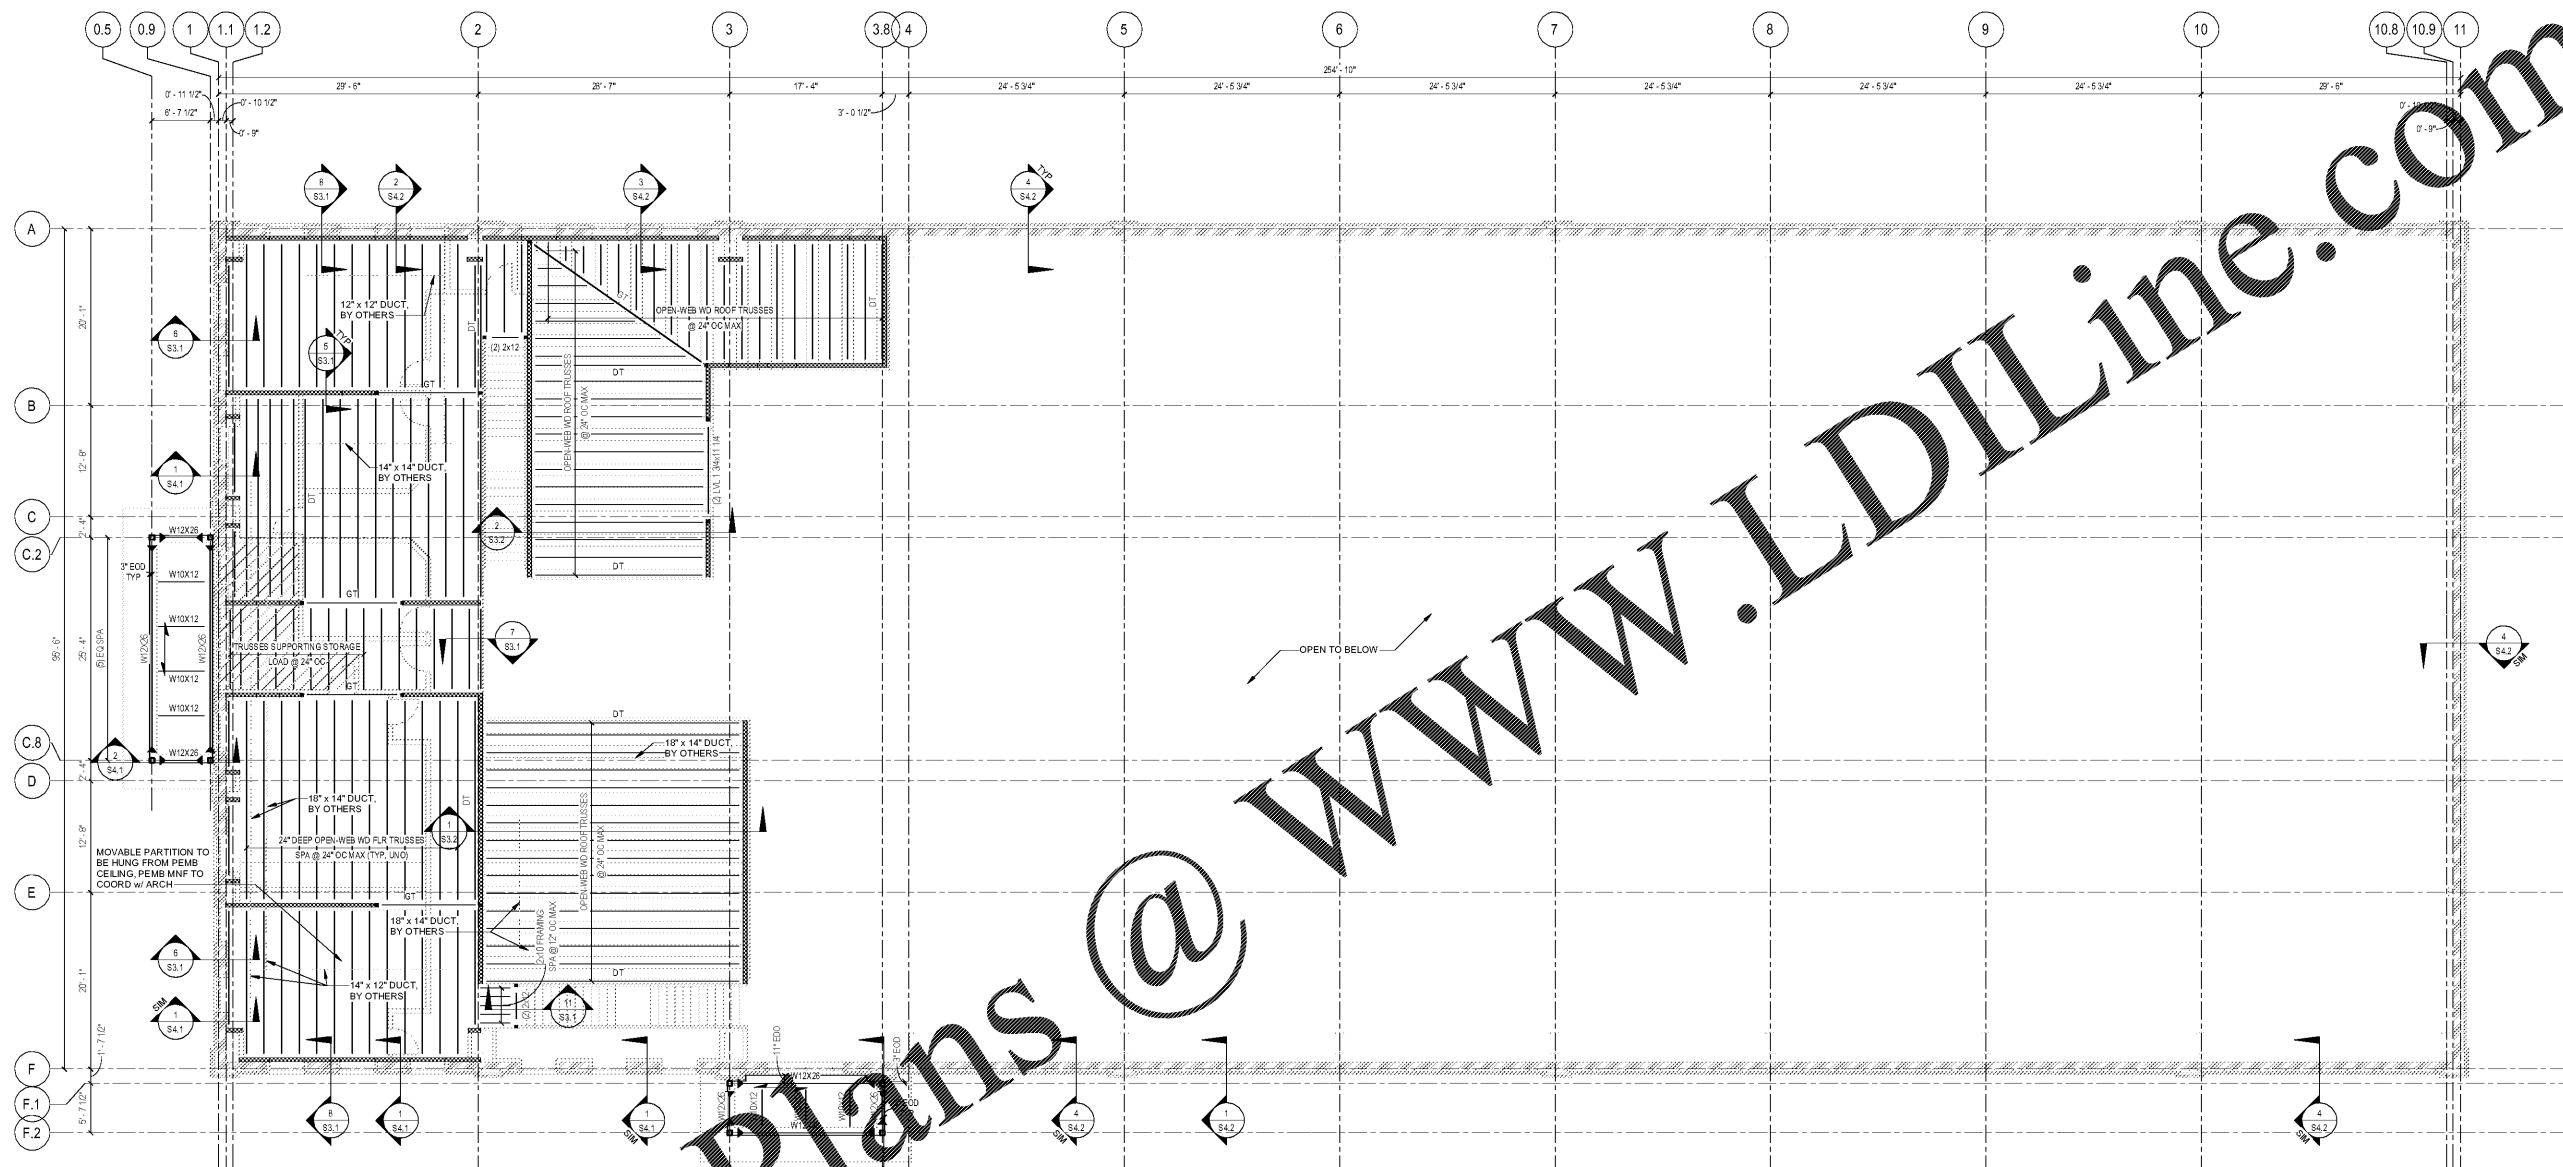
SHEET TITLE

MEZZANINE  
FRAMING  
PLAN

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SHEET NUMBER

S1.2



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SCALE: 1/8" = 1'-0" 1 S1.2

- MEZZANINE FRAMING PLAN NOTES:**
1. FINISH FLOOR ELEVATION = +14'-0" UNO, RELATIVE TO T/SLAB +10'-0"
  2. MEZZANINE FLOOR CONSTRUCTION TO BE 1" THICK SCHONIX JFF SYNTHETIC GYPSUM BASED TOPPING SLAB OVER 3/4" PERFORMANCE CATEGORY (2332" ACTUAL THICKNESS) APA RATED EXPOSURE 1 48/24 SPAN PLYWOOD SHEATHING OVER 24" DEEP OPEN-WEB WOOD TRUSSES.
  3. SEE ARCHITECTURAL DRAWINGS FOR DIMENSIONS AND ELEVATIONS NOT SHOWN ON STRUCTURAL PLAN. COORDINATE DIMENSIONS WITH LATEST ARCHITECTURAL DRAWINGS PRIOR TO CONSTRUCTION.
  4. INDICATES CANTEILER MOMENT CONNECTION PER DETAIL 9/52.0
  5. "DT" DENOTES PRE ENGINEERED WOOD FLOOR DRAG TRUSS. SEE DETAIL 4/S3.1 FOR DRAG TRUSS REQUIREMENTS AND CONNECTION TO SHEAR WALL.
  6. ALL LOAD BEARING WALLS SHOWN ON PLAN TO BE 2x6 SOUTHERN PINE NO 2 GRADE SPACED AT MAX 16" OC. SEE SHEET S0.2 FOR WOOD HEADER SCHEDULE.
  7. INDICATES STORAGE AREA, REDUCE MAX TRUSS SPACING TO 16" ON CENTER FOR ALL WOOD FLOOR TRUSSES SUPPORTING AREA. UNO
  8. "G1" DENOTES PRE ENGINEERED WOOD FLOOR GRIER TRUSS BY TRUSS DESIGNER.
  9. INDICATES SPAN OF 1-1/2" x 20 GA WIDE RIB METAL ROOF DECK. FASTEN DECK TO SUPPORTS w/ #12 TEK SCREWS IN A 3x4 FASTENER PATTERN w/ (3) SIDE LAPS BETWEEN SUPPORTS (12" OC MAX).
  10. SEE ARCHITECT PLANS FOR DECK BEARING ELEVATIONS OF INTERIOR ROOFS ON WOOD ROOF TRUSS FRAMING.
  11. DUCT SHOWN FOR REFERENCE ONLY. REFER TO MECHANICAL DRAWINGS FOR DUCT LOCATIONS AND FOR ALL DUCT SMALLER THAN 14".