


SYMBOL LEGEND

	2' X 2' X 3/4" SUSPENDED ACOUSTICAL TILE ARMSTRONG "ULTIMA" BEVELED TEGULAR TILE WITH 9/16" SUPRAFNE XL EXPOSED TEE GRID - COLOR TO BE WHITE - SEE RCP FOR HEIGHTS A.F.F.	A		EXTERIOR WALL SCONCE FIXTURE TYPE A - SEE SECTION FOR MOUNTING HEIGHT TO CENTER OF FIXTURE - SEE ELECTRICAL	H		CONFERENCE ROOM PENDANT FIXTURE TYPE H - SEE PLAN FOR MOUNTING HEIGHT TO BOTTOM OF FIXTURE - SEE ELECTRICAL		EXIT SIGN - SEE ELECTRICAL
	PAINTED GYPSUM CEILING - SEE RCP FOR HEIGHTS A.F.F. - FINISH AS SCHEDULED	B		EXTERIOR EGRESS EMERGENCY LIGHT FIXTURE TYPE B - SEE PLAN FOR MOUNTING HEIGHT TO CENTER OF FIXTURE - SEE ELECTRICAL	I		BREAK ROOM PENDANT FIXTURE TYPE I - SEE PLAN FOR MOUNTING HEIGHT TO BOTTOM OF FIXTURE - SEE ELECTRICAL		RETURN AIR GRILLE - SEE MECHANICAL
	ARMSTRONG "ULTIMA" 2' X 2' X 3/4" BEVELED TEGULAR ITEM #1912 TO BE INSTALLED ON 9/16" SUPRAFNE XL TEE-BAR SUSPENSION SYSTEM WITH ANOM 19" CLASSIC EXTRUDED ALUMINUM PERIMETER TRIM - COLOR TO BE WHITE - PROVIDE THREAD ROD FOR MOUNTING - SEE RCP FOR SIZE AND MOUNTING HEIGHT TO BOTTOM OF FIXTURE	C		EXTERIOR WALL PACK FIXTURE TYPE C - SEE PLAN FOR MOUNTING HEIGHT TO CENTER OF FIXTURE - SEE ELECTRICAL	J		RESTROOM WALL SCONCE FIXTURE TYPE J - SEE PLAN FOR MOUNTING HEIGHT TO CENTER OF FIXTURE - SEE ELECTRICAL		SUPPLY AIR DIFFUSER - SEE MECHANICAL
	ARMSTRONG "ULTIMA" 2' X 2' X 3/4" BEVELED TEGULAR ITEM #1912 TO BE INSTALLED ON 9/16" SUPRAFNE XL TEE-BAR SUSPENSION SYSTEM WITH ANOM 19" CLASSIC EXTRUDED ALUMINUM PERIMETER TRIM - COLOR TO BE WHITE - PROVIDE THREAD ROD FOR MOUNTING - SEE RCP FOR SIZE AND MOUNTING HEIGHT TO BOTTOM OF FIXTURE	D		RECESSED CANOPY LIGHT FIXTURE TYPE D - SEE PLAN FOR MOUNTING HEIGHT TO BOTTOM OF FIXTURE - SEE ELECTRICAL	K		CUSTOM STRIP LIGHT FIXTURE TYPE K - SEE 1/AS 6 - SEE ELECTRICAL		RECESSED EXHAUST FAN - SEE MECHANICAL
		DE		EMERGENCY RECESSED CANOPY LIGHT FIXTURE TYPE DE - SEE PLAN FOR MOUNTING HEIGHT TO BOTTOM OF FIXTURE - SEE ELECTRICAL	L		2' X 4' LAY-IN LED LIGHT FIXTURE TYPE L - SEE ELECTRICAL		ELECTRIC UNIT HEATER - SEE MECHANICAL
		E		RECESSED CAN LIGHT FIXTURE TYPE E - SEE PLAN FOR MOUNTING HEIGHT TO BOTTOM OF FIXTURE - SEE ELECTRICAL	M		SERVICE AREA LINEAR LIGHT FIXTURE TYPE M - SEE PLAN FOR MOUNTING HEIGHT TO BOTTOM OF FIXTURE - SEE ELECTRICAL		CEILING FAN - SEE ELECTRICAL
		F		CORRIDOR PENDANT FIXTURE TYPE F - SEE PLAN FOR MOUNTING HEIGHT TO BOTTOM OF FIXTURE - SEE ELECTRICAL	N		2' X 4' HIGH BAY LINEAR LIGHT FIXTURE TYPE N - SEE PLAN FOR MOUNTING HEIGHT TO BOTTOM OF FIXTURE - GC TO COORDINATE FINAL MOUNTING HEIGHT WITH OWNER - SEE ELECTRICAL		WALL PACK LIGHT FIXTURE, MOUNT AT 13'-0" A.F.F. - SEE ELECTRICAL
		G		DOMO PENDANT FIXTURE TYPE G - SEE PLAN FOR MOUNTING HEIGHT TO BOTTOM OF FIXTURE - SEE ELECTRICAL	NE		2' X 4' HIGH BAY LINEAR LIGHT FIXTURE TYPE N - SEE PLAN FOR MOUNTING HEIGHT TO BOTTOM OF FIXTURE - GC TO COORDINATE FINAL MOUNTING HEIGHT WITH OWNER - SEE ELECTRICAL		


R.C.P. NOTES

- COORDINATE WITH ARCHITECT AND ELECTRICAL ENGINEER FOR COLOR TEMP REQUIREMENTS FOR ALL LIGHTING
- COORDINATE WITH GENERAL NOTES AND ELECTRICAL / MECHANICAL DRAWINGS
- ALL FINISHES FOR LIGHTS, MECHANICAL SUPPLIES AND DIFFUSERS, AND EXIT SIGNS TO BE SELECTED AND APPROVED BY ARCHITECT PRIOR TO BIDDING AND PURCHASE
- CEILING TILE GRIDS SHALL BE CENTERED IN ROOMS UNLESS OTHERWISE NOTED. 4" MINIMUM TILE SHALL BE USED AT ALL AREAS WHERE CEILING GRID TERMINATES. IF LESS THAN 4", GC SHALL CUT A 2X4 OR 2X2 TILE RESPECTIVELY TO THE REQUIRED LENGTH.
- ALL EXPOSED STRUCTURE, CONDUIT, UNISTRUT, BRACING, SPRINKLER PIPES, AND MECHANICAL TO BE PAINTED IN OPEN-1 CEILING AREAS. REFER TO A.7.1 FOR SCHEDULE.

NOTES

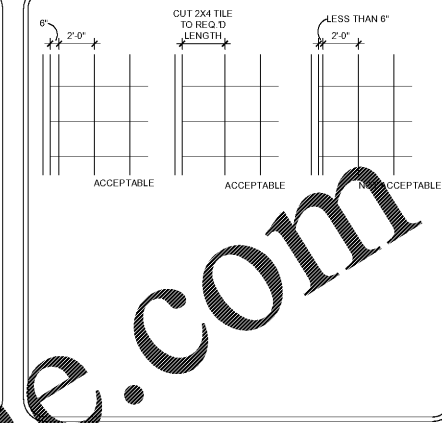

ROBERT JOHNSON
architects
1808 West Morehead St.
Charlotte, NC 28208
T 704 / 342.1058
F 704 / 342.3043

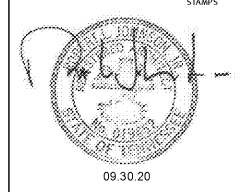

09.30.20

CONSULTANT

MIDSOUTH CARPENTER'S TRAINING TRUST
LA VERGNE, TN


PROJECT NUMBER 1982
ISSUE DATE
FOR PERMIT 09.30.20

DRAWING DATA
DRAWN BY: BM/LM
CHECKED BY: TH
SHEET TITLE
ENLARGED REFLECTED CEILING PLANS


This drawing is the property of ROBERT JOHNSON ARCHITECTS, Inc. and is not to be reproduced or copied in whole or in part. It is only to be used for the project and for specifically intended herein and is not to be used on any other project. It is to be returned upon request.

SHEET NUMBER


A-2.3

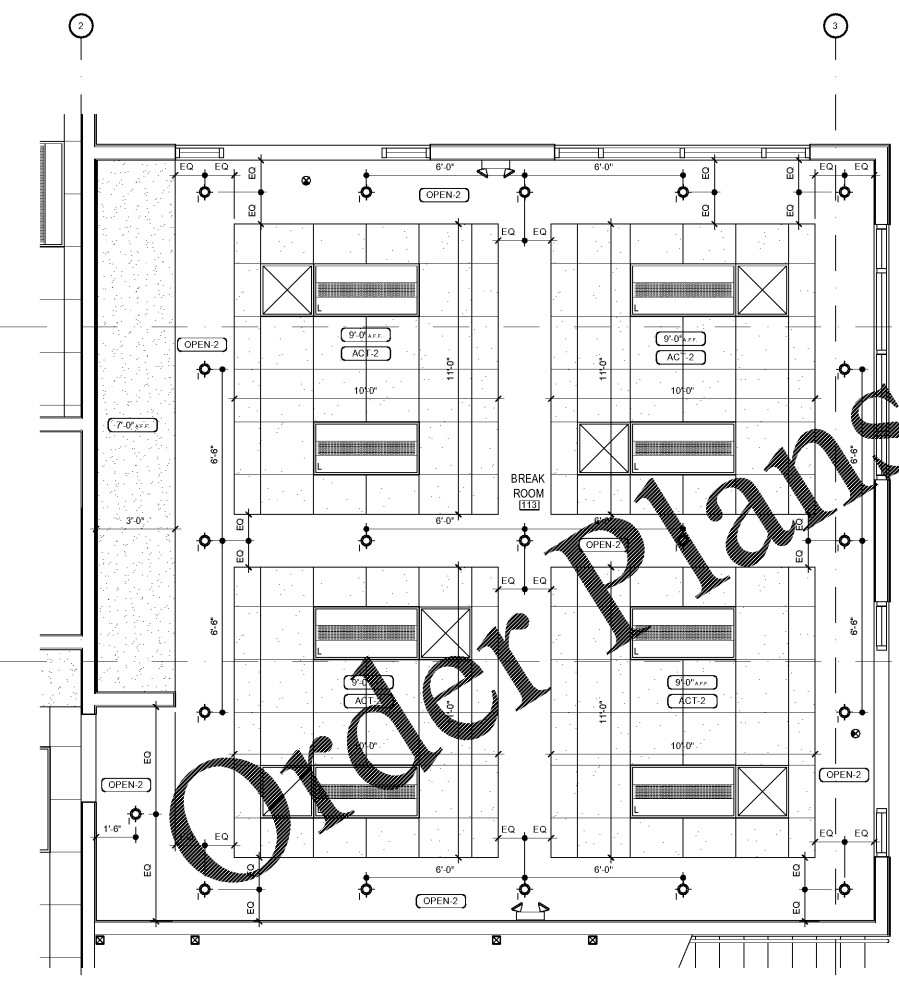

1 ENLARGED GROUND FLOOR REFLECTED CEILING PLAN
SCALE: 3/8" = 1'-0"
BREAK ROOM 113

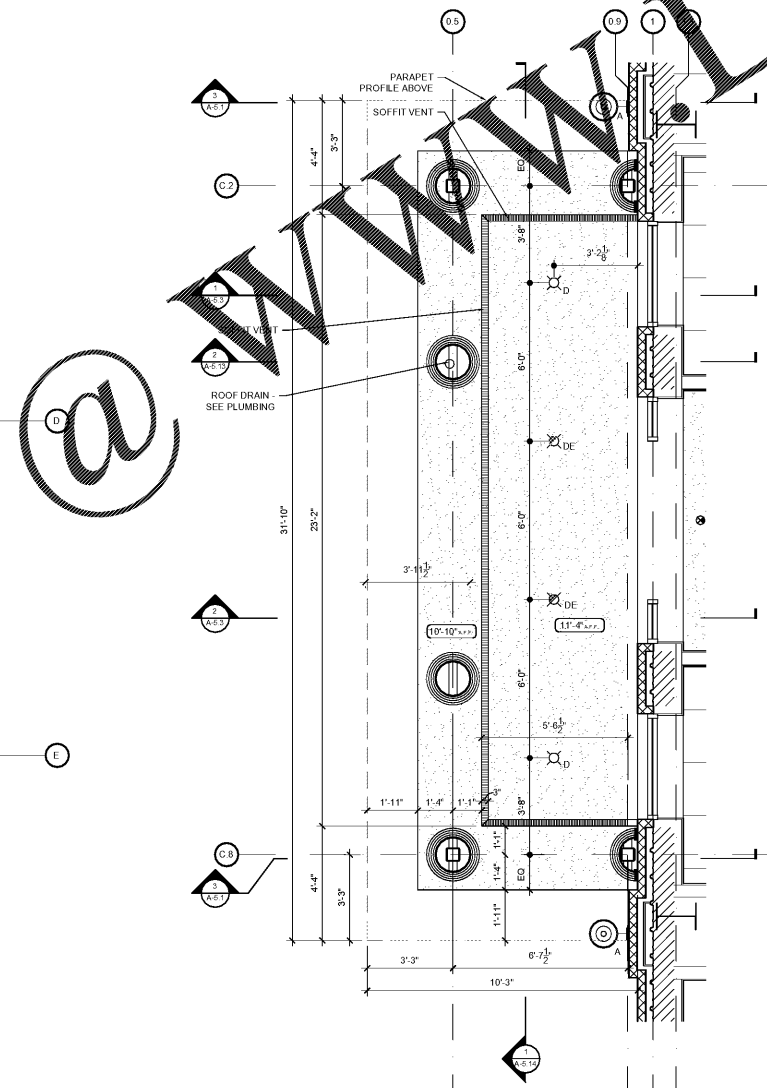

2 ENLARGED CANOPY REFLECTED CEILING PLAN
SCALE: 3/8" = 1'-0"

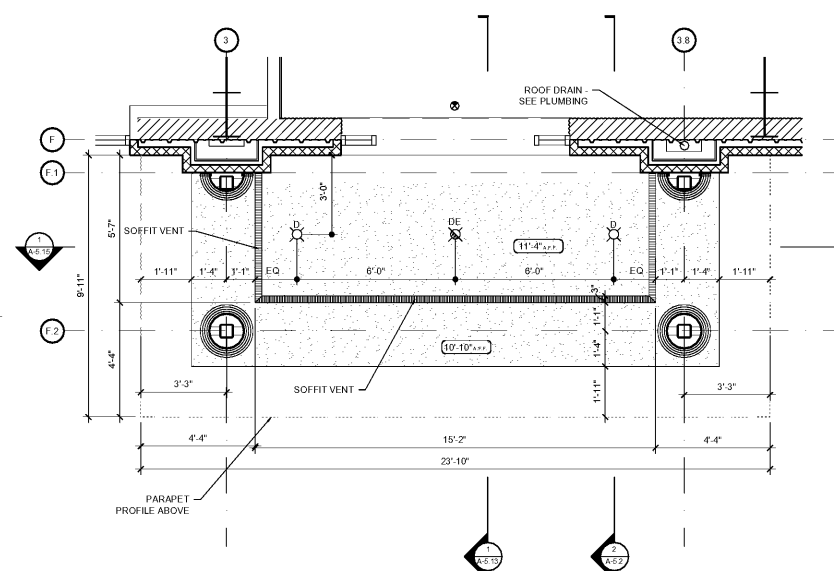

3 ENLARGED CANOPY REFLECTED CEILING PLAN
SCALE: 3/8" = 1'-0"