


2 ENLARGED MECHANICAL PLAN
A-0.1 SCALE: 1/4" = 1'-0"


- GENERAL NOTES**
- GC TO COORDINATE WITH CIVIL PLANS FOR ALL DIMENSIONS AND ELEVATIONS.
 - GC TO COORDINATE WITH CIVIL FOR PROPER SUBGRADE AND DESIGN OF ALL EXTERIOR SURFACES INCLUDING CONCRETE AND ASPHALT.
 - CONCRETE SIDEWALKS SHALL BE DIVIDED IN SECTIONS BY MEANS OF 1" DEEP SAWCUT CONTROL JOINTS. CONTROL JOINTS SHALL BE LOCATED NOT LESS THAN 3' NOR MORE THAN 10' IN ANY DIRECTION.
 - CONCRETE SIDEWALKS SHALL BE DIVIDED FROM OTHER ELEMENTS (INCLUDING BUILDING ELEMENTS, CURBS, ASPHALT, ETC) BY MEANS OF 1/2" EXPANSION JOINTS WITH SEALANT.

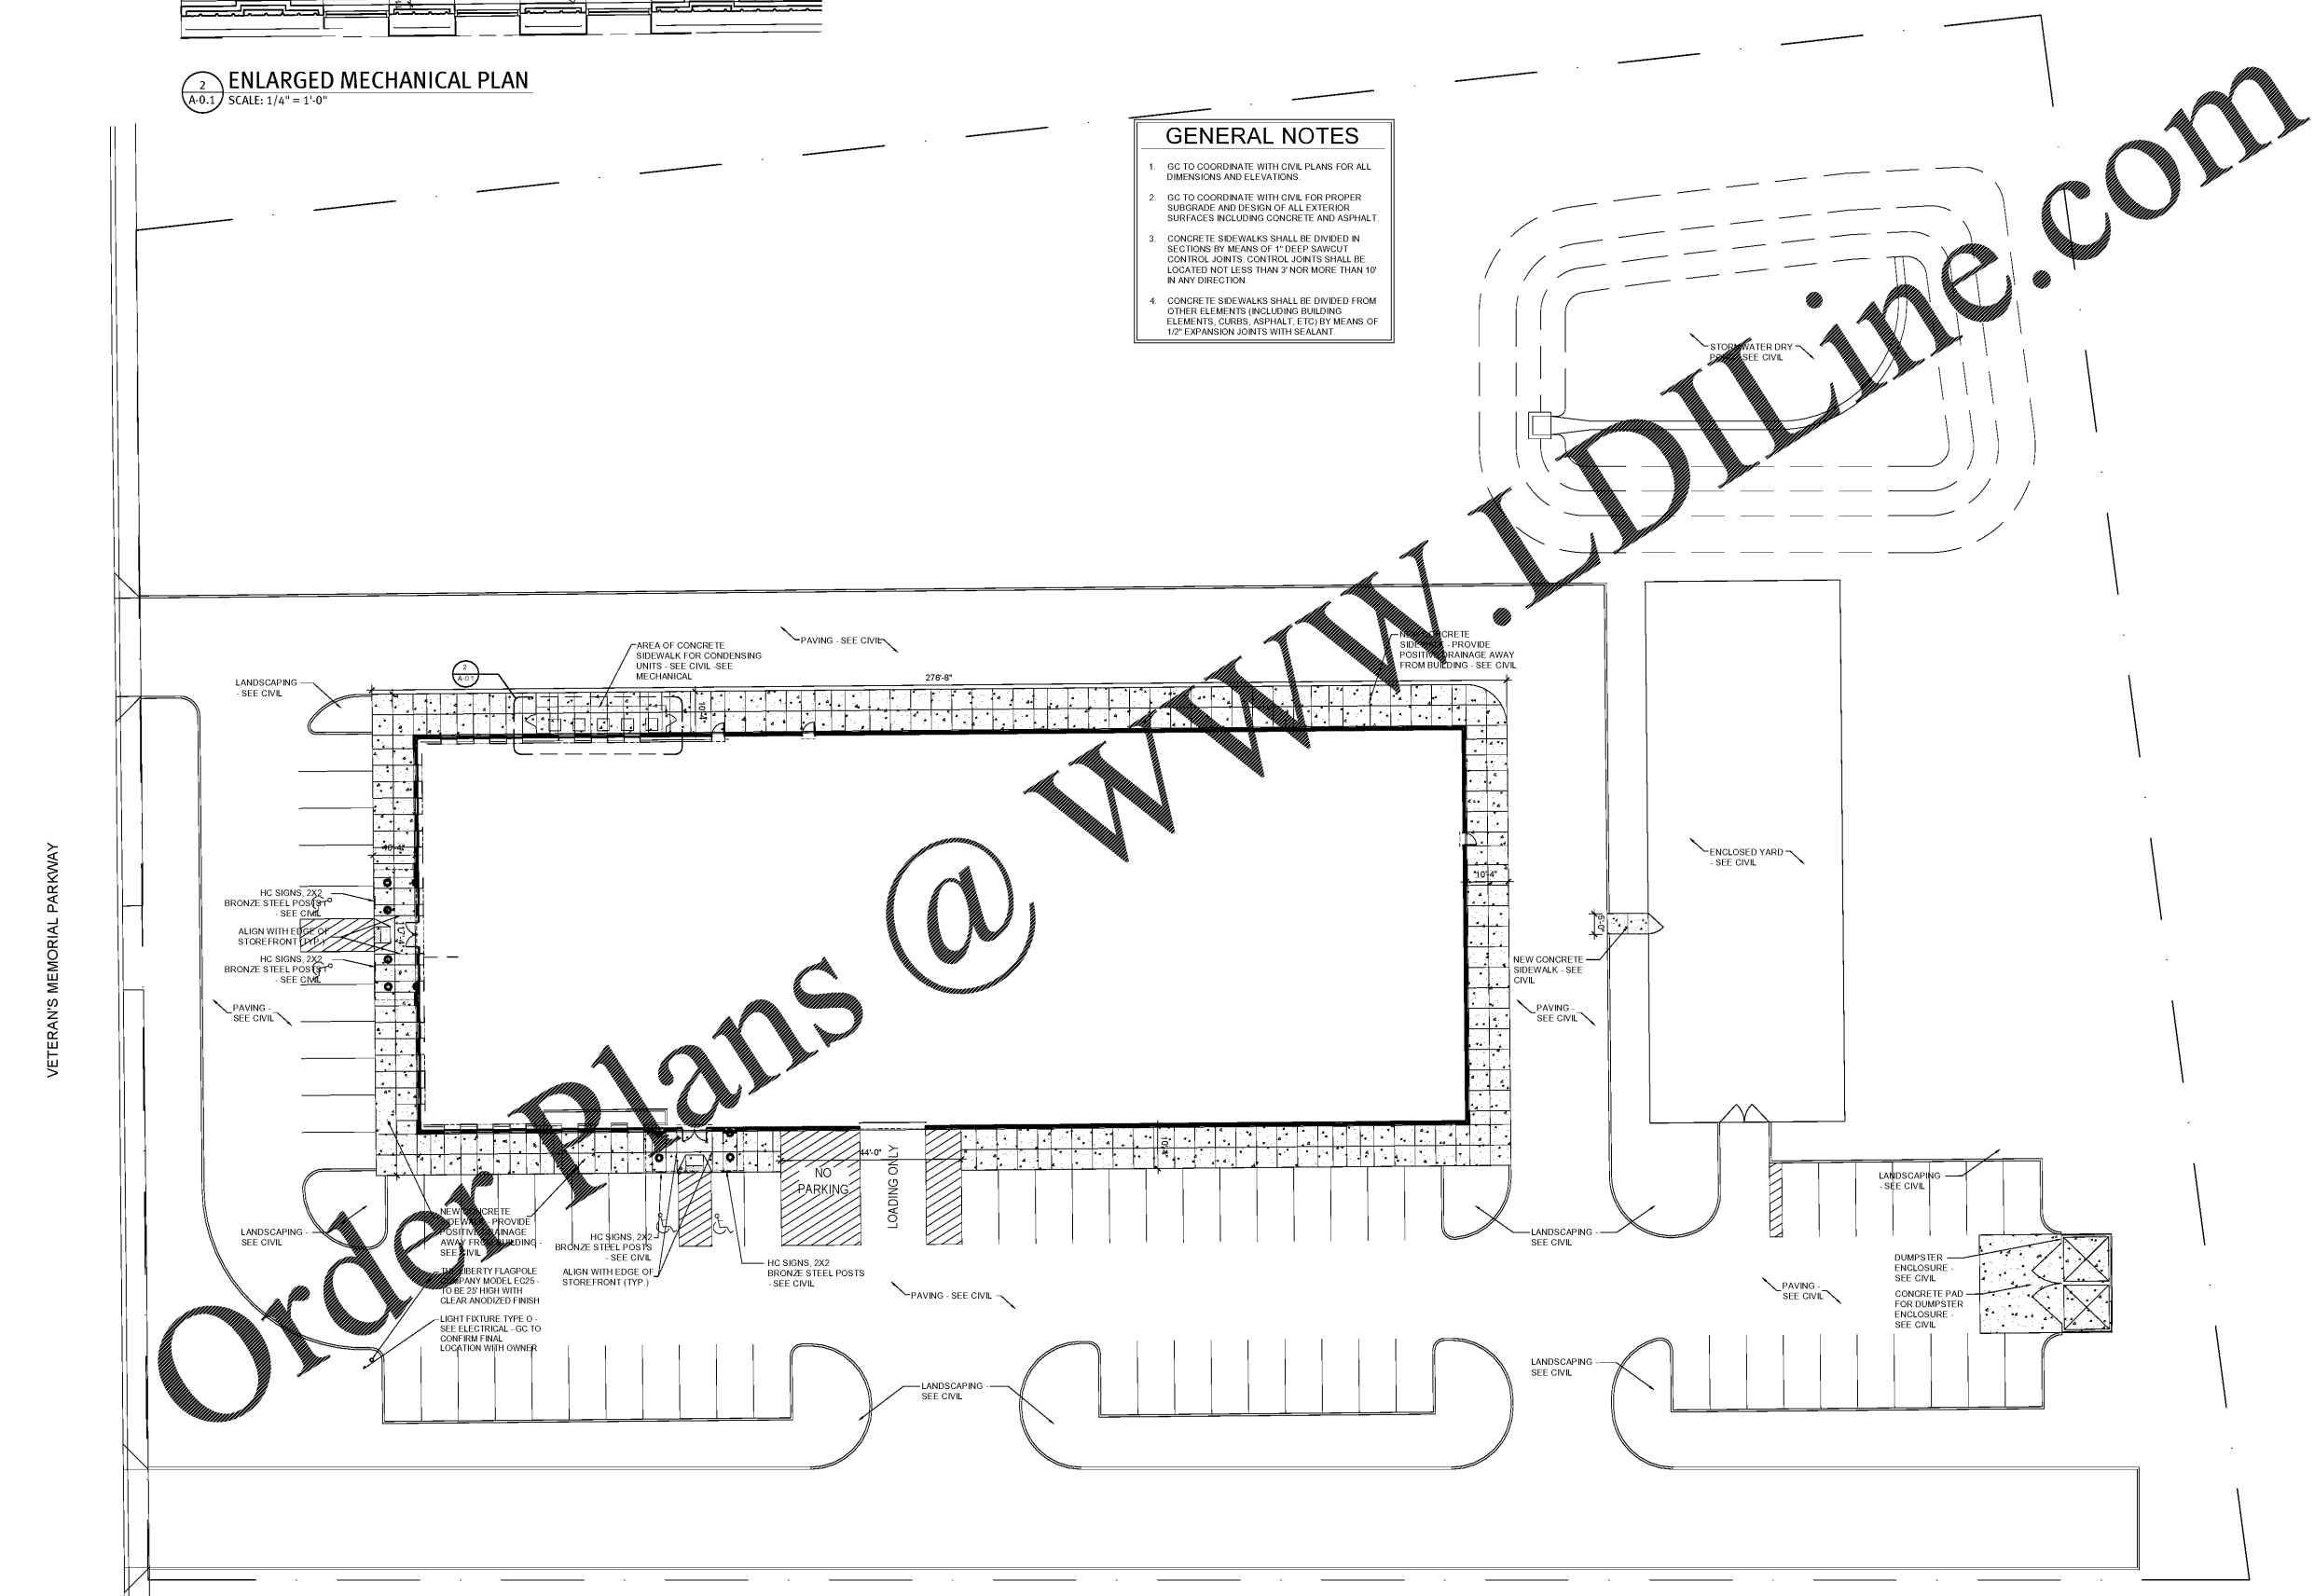

1 SIDEWALK PLAN
A-0.1 SCALE: 1/16" = 1'-0"



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09.30.20

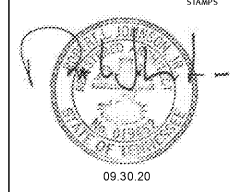CONSULTANT

MIDSOUTH
CARPENTER'S
TRAINING
TRUST
LA VERGNE, TN

PROJECT NUMBER 1982
ISSUE DATE
FOR PERMIT 09.30.20

DRAWING DATA
DRAWN BY: BM/LM
CHECKED BY: TH

SHEET TITLE
SIDEWALK
PLAN

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SHEET NUMBER
A-0.1