



PIT FLOOR PLAN MECHANICAL
NORTH
0 1 2 3 4 8
SCALE: 1/4" = 1'-0"

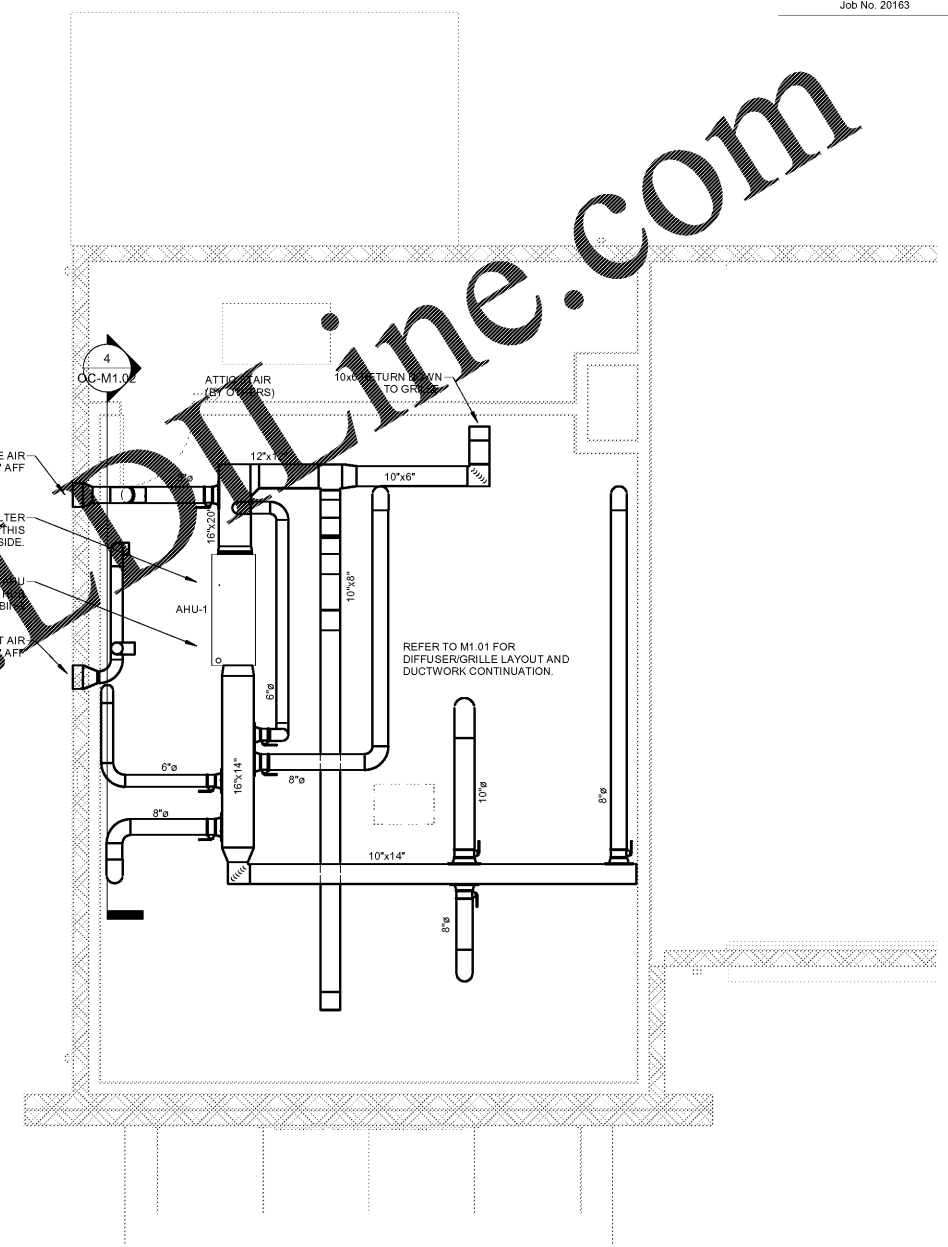


EQUIPMENT PLATFORM MECHANICAL
NORTH
0 1 2 3 4 8
SCALE: 1/4" = 1'-0"


- GENERAL NOTES:**
- VERIFY EXISTING CONDITIONS IN FIELD PRIOR TO BEGINNING WORK.
 - SPACE ABOVE CEILING IS LIMITED. CAREFUL COORDINATION WITH LIGHTING, ELECTRICAL, PLUMBING, STRUCTURAL, AND ARCHITECTURAL WORK IS CRITICAL TO DUCTWORK INSTALLATION.
 - PROVIDE NECESSARY OFFSETS IN PIPING, ELECTRICAL CONDUIT, AND DUCTWORK AS REQUIRED TO ACCOMMODATE NEW WORK. DRAWINGS ARE DIAGRAMMATIC AND DO NOT SHOW ALL DETAILS NOR CHANGES IN DUCTWORK ELEVATIONS NECESSARY FOR COMPLETE INSTALLATION.
 - COORDINATE CEILING AIR DEVICE LOCATIONS WITH LIGHTING PLAN AND ARCHITECT'S REFLECTED CEILING PLAN.
 - DUCTWORK SHALL BE RUN TIGHT TO STRUCTURE. AVOID CROSSING OVER LIGHTS AND OTHER DUCTS DUE TO TIGHT CLEARANCES.
 - LOUVERS SHALL BE RUSKING ELF8375D OR APPROVED EQUAL. PROVIDE UNIT WITH BIRDSCREEN AND MILL ALUMINUM FINISH. COORDINATE EXACT HEIGHT AND COLOR OF LOUVER WITH ARCHITECT PRIOR TO ORDERING.
 - MOUNT TEMPERATURE CONTROLS 48" ABOVE FINISHED FLOOR. COORDINATE EXACT LOCATION WITH ARCHITECT.
 - SPILL CONDENSATE FROM AHUS INTO NEAREST FLOOR DRAIN.
 - PROVIDE ENGRAVED PLASTIC LABEL AT TERMINATION OF EACH AUXILIARY CONDENSATE DRAIN LINE READING AS FOLLOWS:
"AHU-### AUXILIARY DRAIN LINE."
"NOTIFY MAINTENANCE PERSONNEL WHEN WATER IS FLOWING"
 - CONNECT CONDENSATE DRAIN PIPING TO AHU IN ACCORDANCE WITH DETAILS.

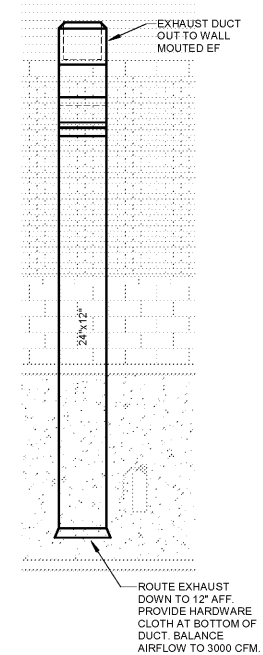

6 Section 12
OC-M1.02 1/4" = 1'-0"

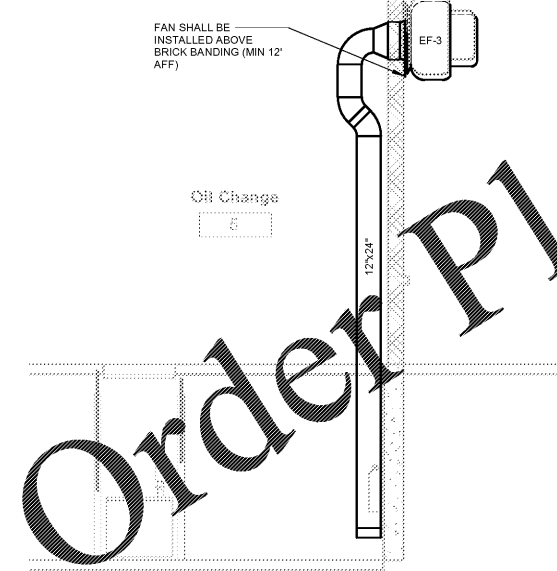

3 Section Through Pit Exhaust
OC-M1.02 1/4" = 1'-0"

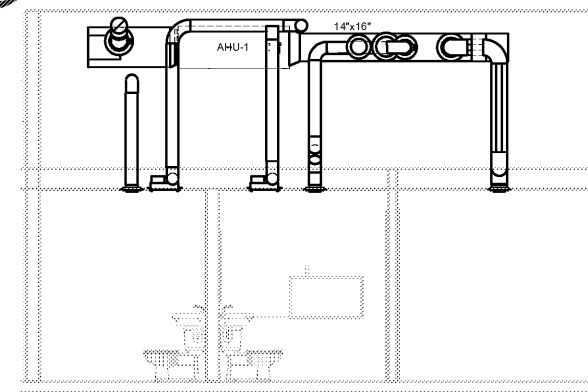

4 AHU Section
OC-M1.02 1/4" = 1'-0"

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FINAL

| No. | Description | Date |
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Partial Mechanical Floor Plans - Pit and Platform

| | |
|----------------|------------|
| Project number | 20025 |
| Date | 08/27/2020 |
| Drawn by | CA |
| Checked by | JB |

OC-M1.02
Scale As indicated