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Consultants :



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NC CDSP. LICENSE #6-1881
WAVE PROJECT #20193

Permit - Seal :

PRELIMINARY
NOT FOR CONSTRUCTION
OR PRICING

10/20/2020

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CONSTRUCTION

Issued / Revisions : Appd. Date

Client :



Project :
Storage Facility
Country Club Rd.
Winston-Salem, NC

Title :


THIRD FLOOR LIGHTING PLAN

Date :

Project No. : Drawn by :

Sheet :

E-103

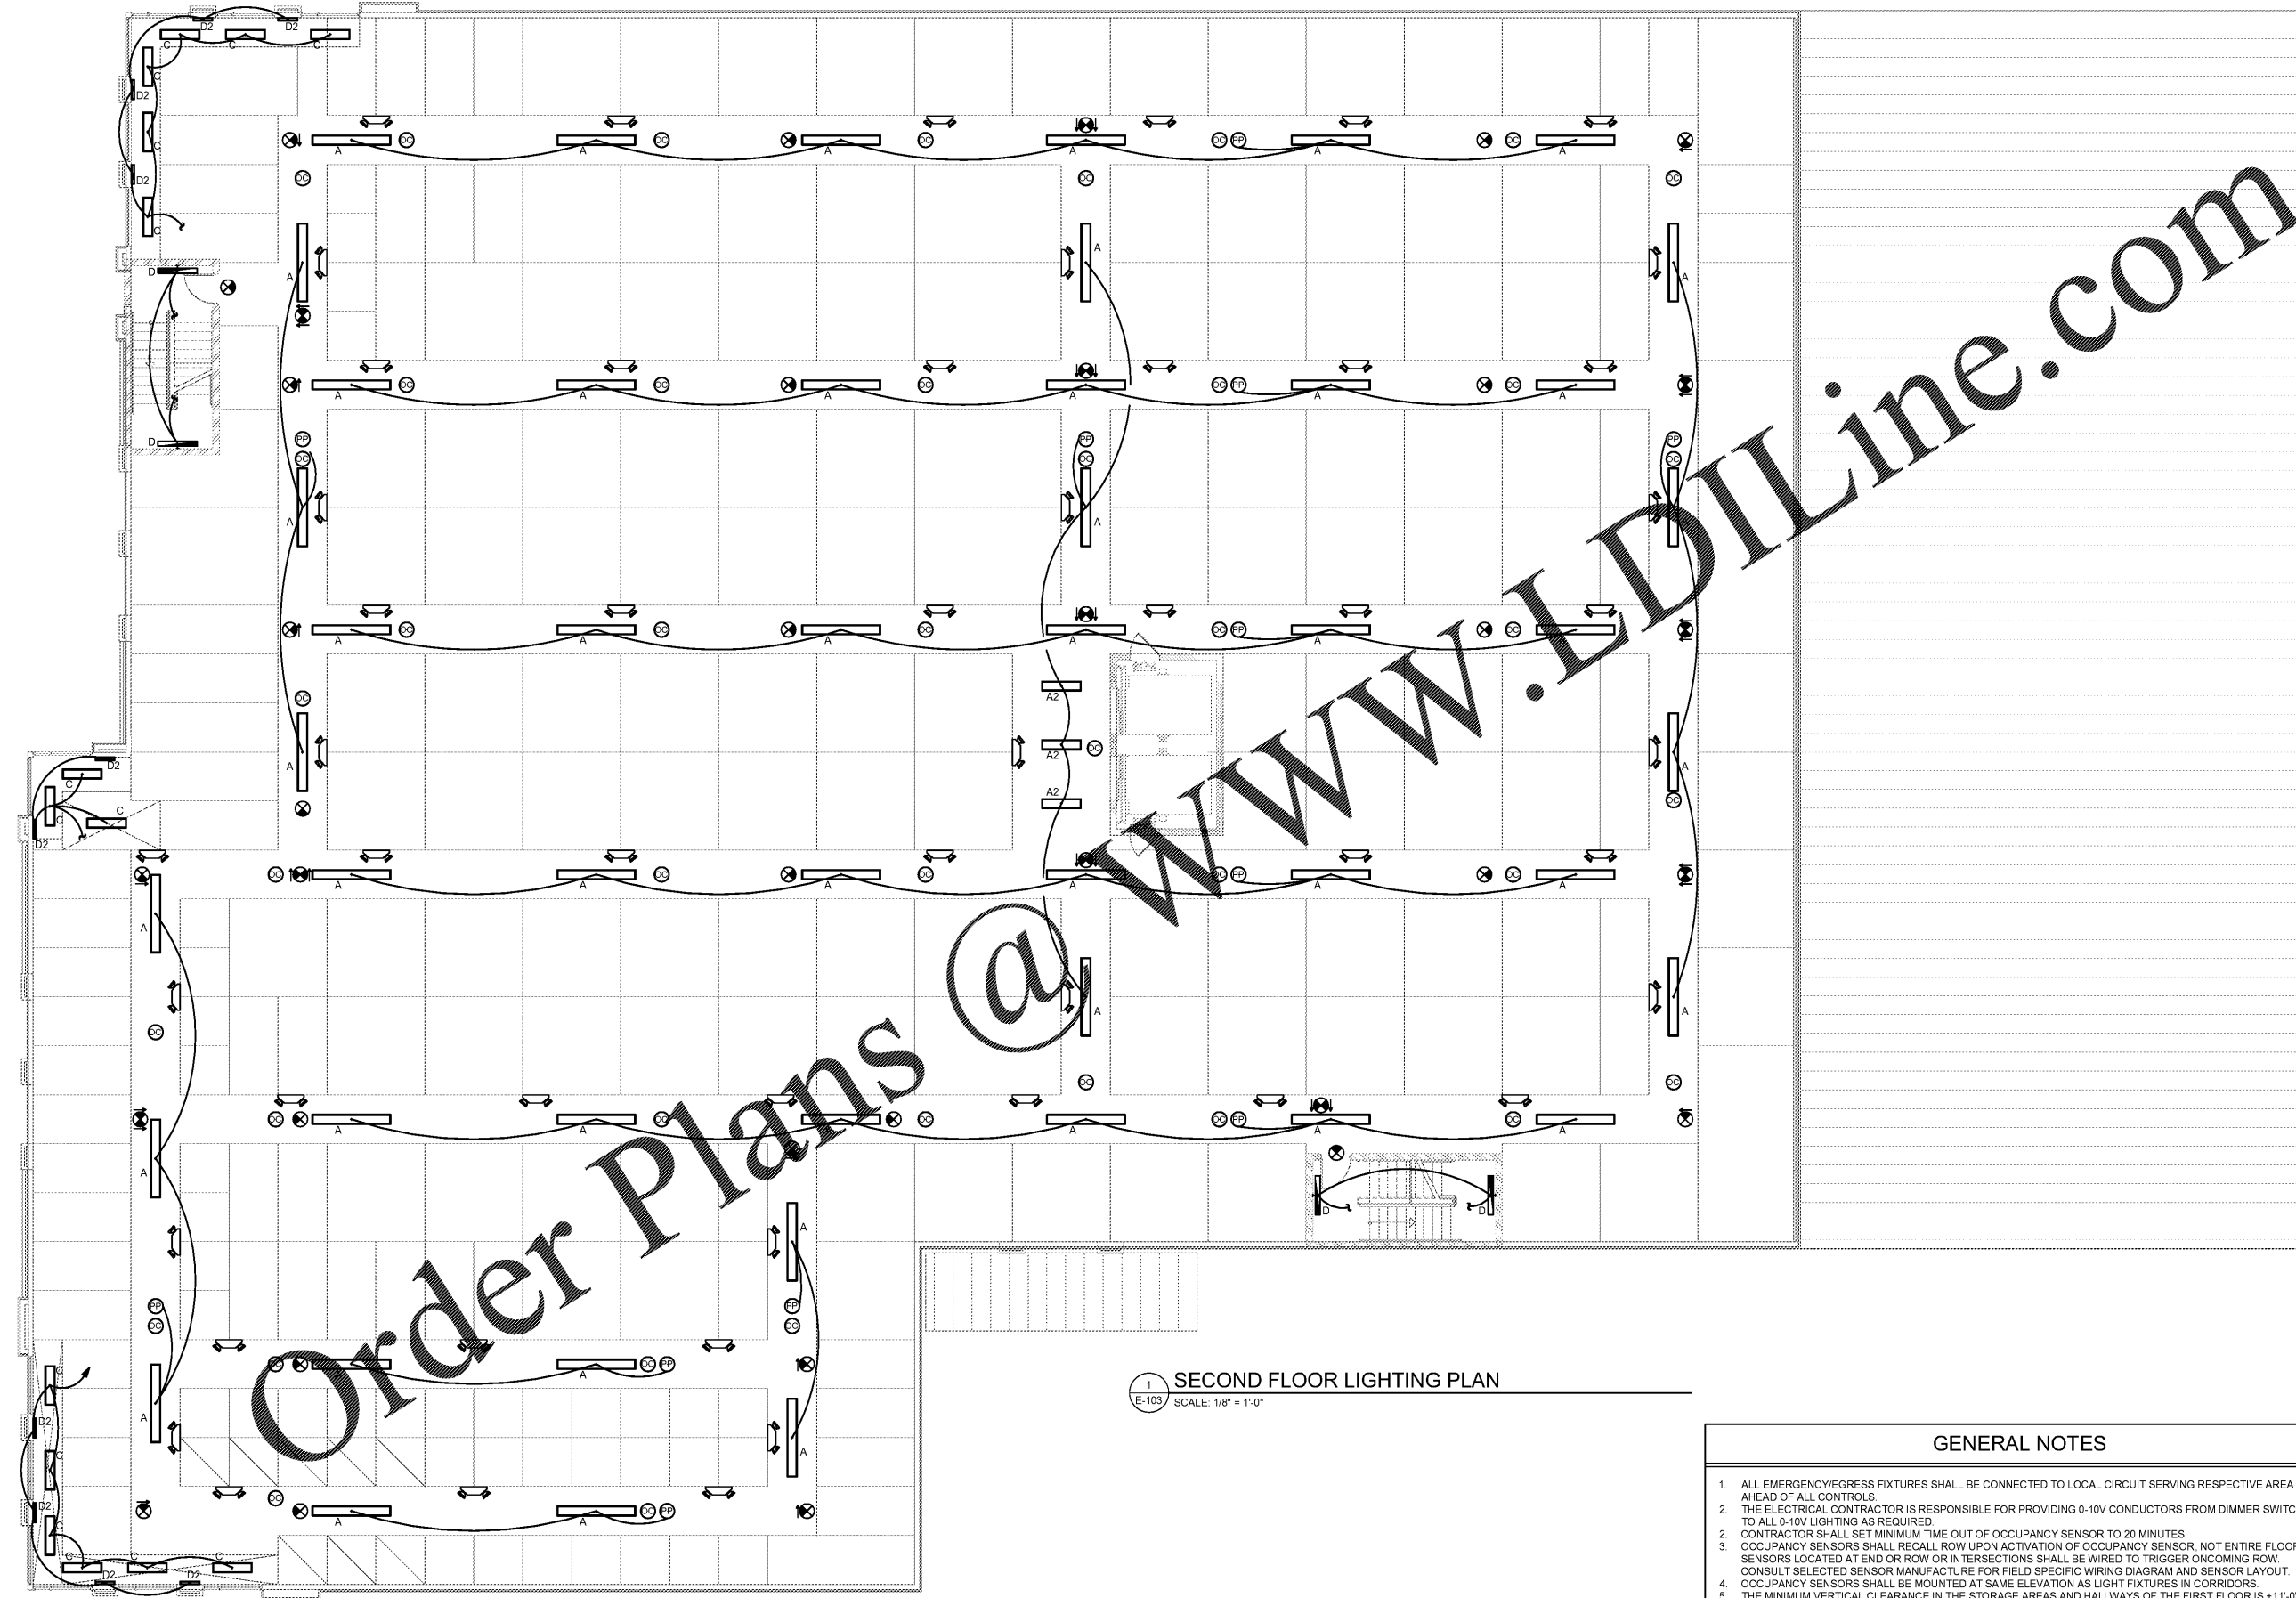

1 SECOND FLOOR LIGHTING PLAN
E-103 SCALE: 1/8" = 1'-0"

GENERAL NOTES

1. ALL EMERGENCY/EGRESS FIXTURES SHALL BE CONNECTED TO LOCAL CIRCUIT SERVING RESPECTIVE AREA AND AHEAD OF ALL CONTROLS.
2. THE ELECTRICAL CONTRACTOR IS RESPONSIBLE FOR PROVIDING 0-10V CONDUCTORS FROM DIMMER SWITCHES TO ALL 0-10V LIGHTING AS REQUIRED.
3. CONTRACTOR SHALL SET MINIMUM TIME OUT OF OCCUPANCY SENSOR TO 20 MINUTES.
4. OCCUPANCY SENSORS SHALL RECALL ROW UPON ACTIVATION OF OCCUPANCY SENSOR. NOT ENTIRE FLOOR. SENSORS LOCATED AT END OR ROW OR INTERSECTIONS SHALL BE WIRED TO TRIGGER ONCOMING ROW. CONSULT SELECTED SENSOR MANUFACTURE FOR FIELD SPECIFIC WIRING DIAGRAM AND SENSOR LAYOUT.
5. OCCUPANCY SENSORS SHALL BE MOUNTED AT SAME ELEVATION AS LIGHT FIXTURES IN CORRIDORS.
6. THE MINIMUM VERTICAL CLEARANCE IN THE STORAGE AREAS AND HALLWAYS OF THE FIRST FLOOR IS +11'-0" AFF. AND OF THE SECOND AND THIRD IS +11'-0" AFF. PRIOR TO COMMENCING CONSTRUCTION SO THAT ANY CONFLICTS CAN BE IDENTIFIED, RESOLVED AND MANAGED WITHOUT DELAY OR COSTS TO THE OWNER. THE GC AND THE GC'S MEP & FP SUBS SHALL FULLY COORDINATE THE LAYOUT OF ALL WORK, SYSTEMS, STRUCTURAL MEMBERS AND COMPONENTS, EQUIPMENT, FIXTURES, DUCTWORK, PLUMBING AND FIRE PROTECTION LINES, SPRINKLER HEADS, ETC. LOCATED IN THE AREA BETWEEN +7'-10" AFF AND THE UNDERSIDE OF THE FLOOR OR ROOF DECK ABOVE.

Order Plans @