



Looney Ricks Kiss

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Issues and Revisions

| Date      | Issued / Revised  |
|-----------|-------------------|
| 3/16/2020 | 50% C.D.          |
| 5/15/2020 | 80% C.D.          |
| 7/13/2020 | Permit Submission |

BUILDING ADDRESSES

|           |                                  |
|-----------|----------------------------------|
| TYPE G.B. | 442, 444, 446, 448 BATHURST LANE |
| TYPE H.A. | 324, 226, 228, 330 ISHMAEL PLACE |
| TYPE L.C. | 315, 364 FOOT LANE               |
| TYPE L.E. | 333 S DANNY THOMAS BLVD          |
| TYPE L.F. | 365, 431 VANCE AVE               |
| TYPE L.G. | 315 ISHMAEL PLACE                |
| TYPE L.H. | 327 ISHMAEL PLACE                |
| TYPE L.I. | 420, 555 FOOT LANE               |
| TYPE L.J. | 340 S DANNY THOMAS BLVD          |
| TYPE L.K. | 402, 426 FOOT LANE               |

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Seal



LRK Project Number: 01.15100.43

Project Name:  
**South City CNI  
Phase 4**


Memphis, TN

Drawing Name:  
**SECOND FLOOR  
FRAMING PLAN**

Drawn By: MAC

Checked By: KEM

**HA-S102**

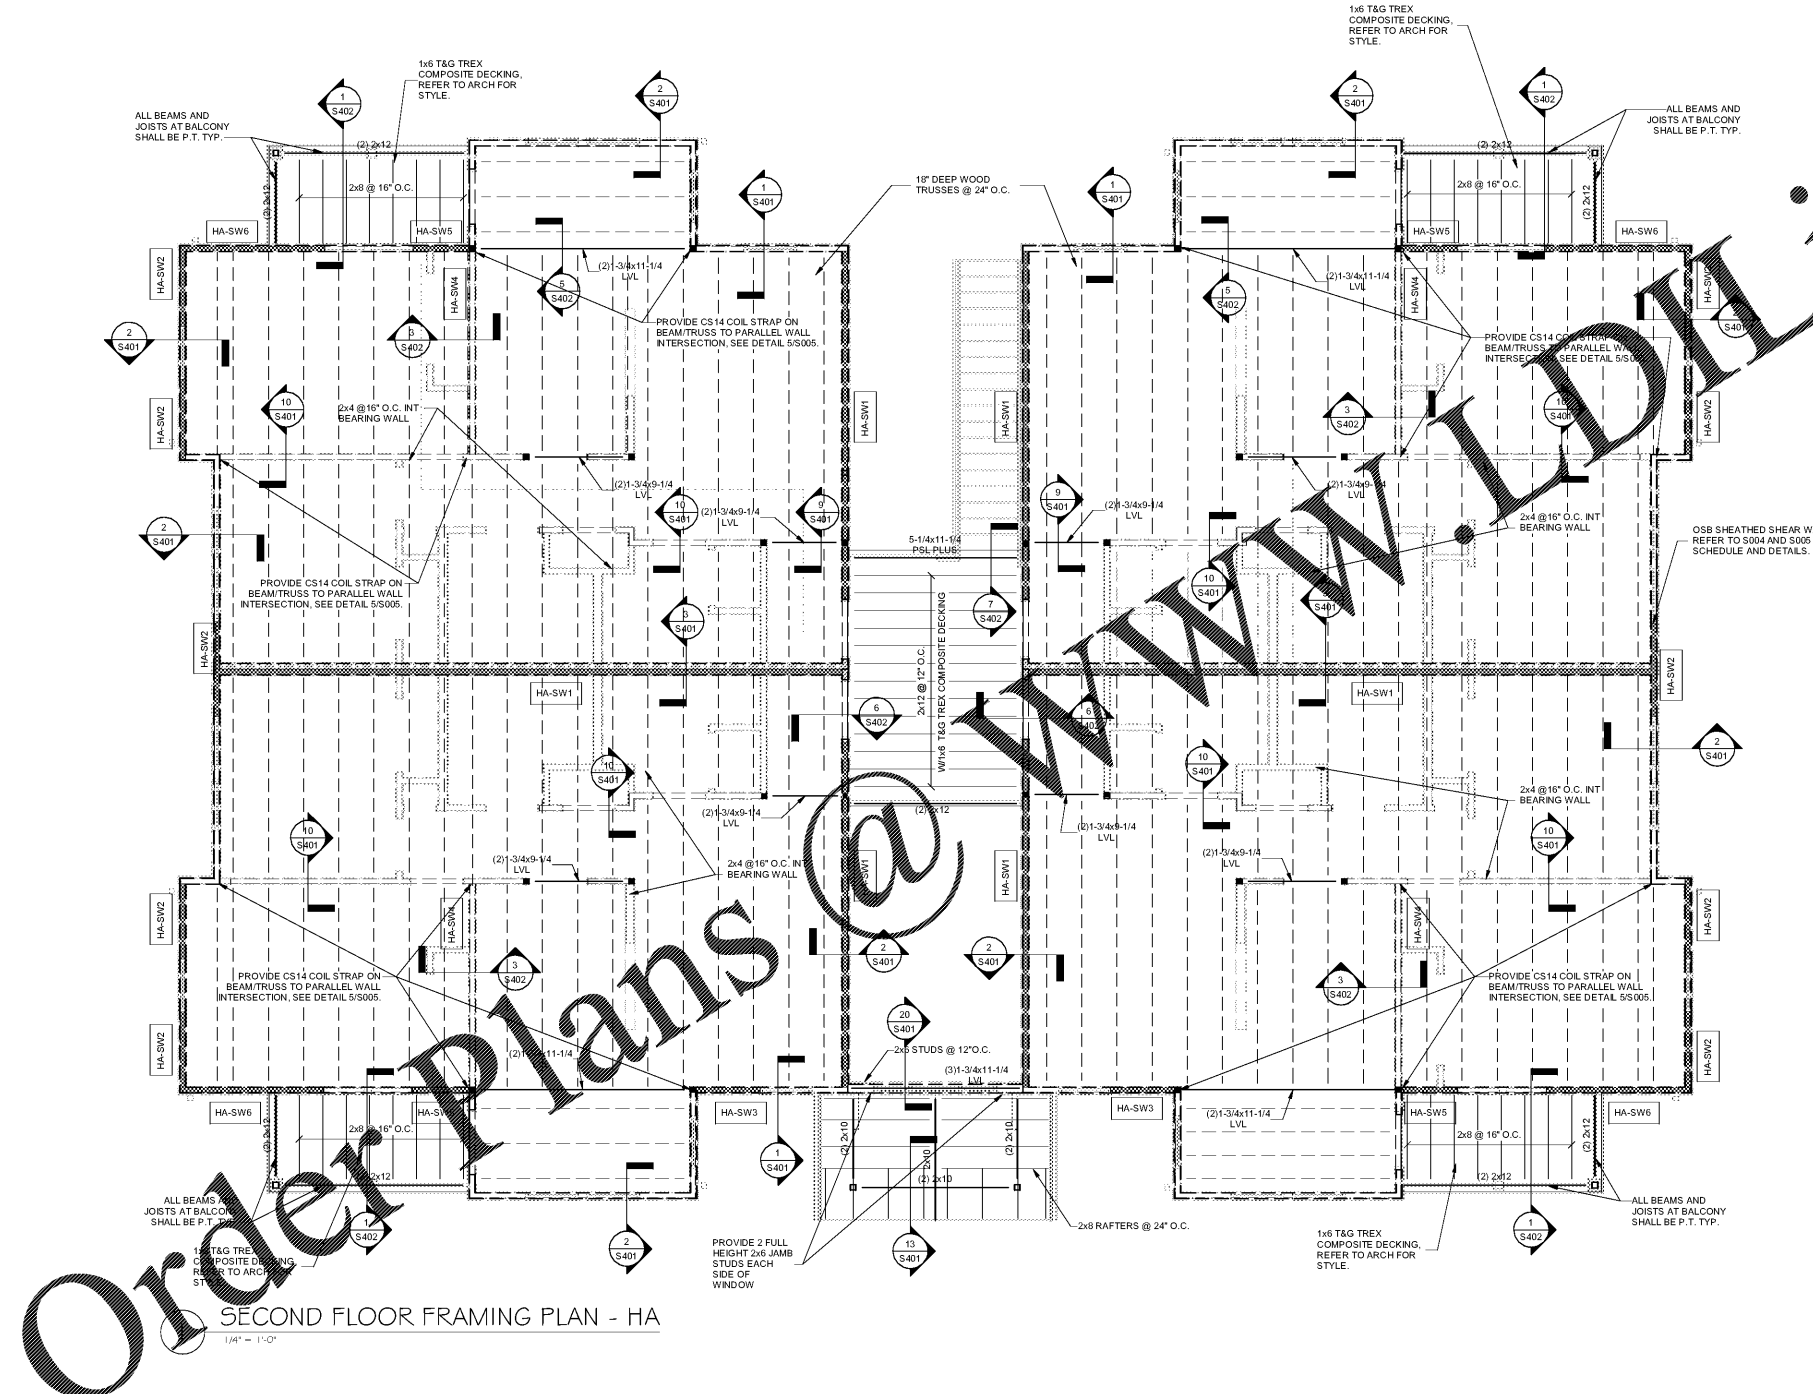

**Order Plans @**

**SECOND FLOOR FRAMING PLAN - HA**  
1/4" = 1'-0"

- NOTES:
- 1) ALL WALLS THIS FLOOR, INTERIOR AND EXTERIOR, SHALL BE 2x4'S @ 16" O.C.
  - 2) FLOOR SHEATHING SHALL BE 1/2" 4824 TONGUE AND GROOVE SHEATHING ENTIRE FLOOR. SEE DETAIL 55003 FOR SHEATHING CONNECTION AND FRAMING DETAILS.
  - 3) REFER TO HEADER SCHEDULE 4IS003 FOR OPENING AND FRAMING DETAILS FOR ALL DOORS AND WINDOWS.
  - 4) HA-SW# INDICATES SHEAR WALLS. SEE SHEETS S004 AND S005 FOR SHEAR WALL SCHEDULE AND CONSTRUCTION DETAILS.
  - 5) REFER TO 105-802 FOR ALL LVL BEAM TO PSL COLUMN CONNECTION DETAILS AS WELL AS ALL CANOPY & BALCONY BEAM TO COLUMN CONNECTION DETAILS.
  - 6) TRUSS LAYOUT SHOWN IS DIAGRAMMATIC. CONTRACTOR SHALL LAYOUT TRUSSES AND COORDINATE LOCATION WITH OTHER TRADES, PRIMARILY PLUMBING TOILETS, BATHTUBS, SHOWER DRAINS, AND MECHANICAL FAN COIL UNITS. FINAL COORDINATION AND PLACEMENT IS RESPONSIBILITY OF TRUSS MANUFACTURER AND CONTRACTOR.