


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ISSUE RECORD

DATE	REV.	DESCRIPTION
12/08/2017		PERMIT SUBMISSION SET

BUILDING FINISHED FLOOR EL. =	XXX.XX' (SEE CIVIL)
BUILDING TOP OF FOOTING (TIFTG) EL. =	XXX.XX' (TYPICAL)
CANOPY TOP OF FOOTING (TIFTG) EL. =	XXX.XX' (TYPICAL)

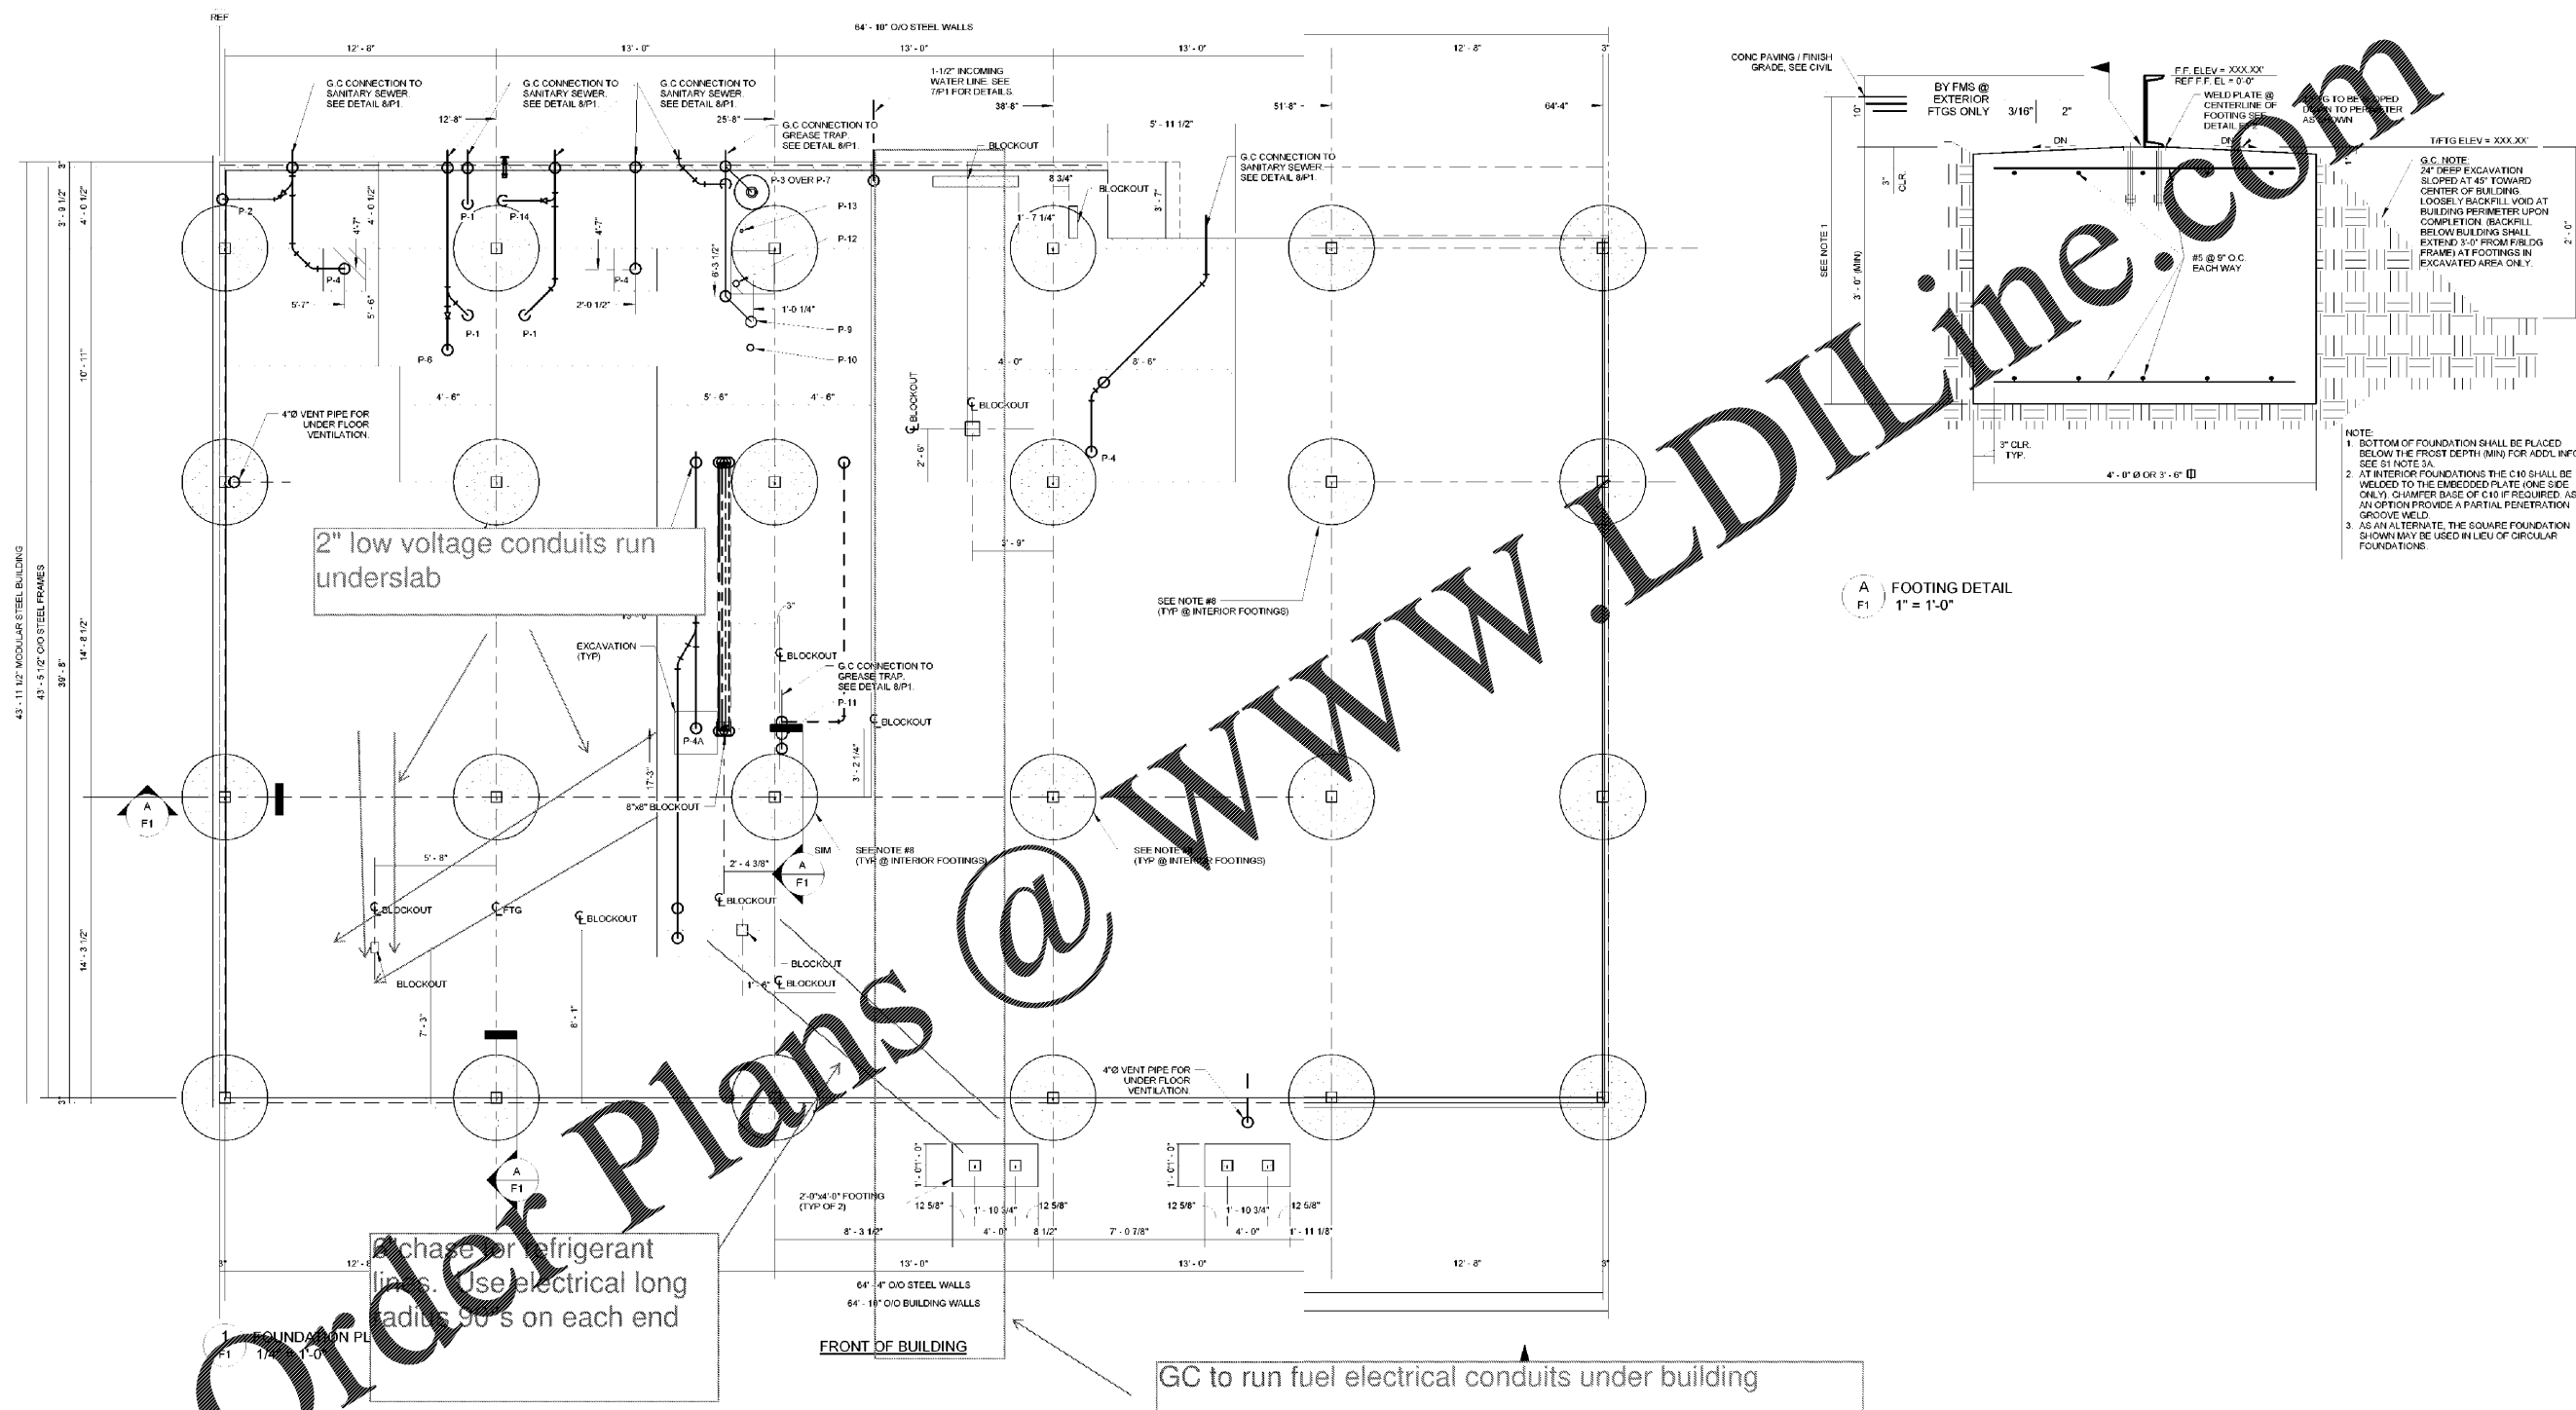

- NOTE:**
- BOTTOM OF FOUNDATION SHALL BE PLACED BELOW THE FROST DEPTH (MIN) FOR ADDL INFO SEE S1 NOTE 3A.
 - AT INTERIOR FOUNDATIONS THE C10 SHALL BE WELDED TO THE EMBEDDED PLATE (ONE SIDE ONLY). CHAMFER BASE OF C10 IF REQUIRED, AS AN OPTION PROVIDE A PARTIAL PENETRATION GROOVE WELD.
 - AS AN ALTERNATE, THE SQUARE FOUNDATION SHOWN MAY BE USED IN LIEU OF CIRCULAR FOUNDATIONS.

A FOOTING DETAIL
1" = 1'-0"

NOTE: ALL PULL DIMENSIONS ARE FROM FACE OF BLDG FRAME

- FOUNDATION PLAN NOTES:**
- SEE SHEET S1 FOR STRUCTURAL GENERAL NOTES FOR GEOTECHNICAL REPORT AND REQUIREMENTS SEE SHEET S1 SECTION 3.B
 - ALL ELEVATIONS REFERENCED FROM FINISH FLOOR ELEVATION OF 0'-0" FOR REFERENCE ONLY. SEE SITE PLAN FOR ACTUAL FINISH FLOOR ELEVATION.
 - TOP OF FOOTING ELEVATION = (+)0'-10" UNLESS NOTED OTHERWISE, TIF = TOP OF FOOTING.
 - SEE ARCH DWGS FOR ALL DIMENSIONS NOT SHOWN.
 - CONTRACTOR TO PREPARE SUBGRADE FOR BUILDING PAD AND PAVING AREAS PER GEOTECHNICAL ENGINEER'S REPORT AND RECOMMENDATIONS.
 - G.C. SHALL COORDINATE ALL PLUMBING DIMENSIONS AND INFORMATION WITH DRAWING "P1".
 - THE CONTRACTOR SHALL BE SOLELY RESPONSIBLE FOR SOIL CONDITIONS & SUBGRADE PREPARATION PER THE GEOTECHNICAL REPORT.
 - INTERIOR FOOTINGS DO NOT REQUIRE C10 TO BE WELDED TO BEARING PLATE.
 - BACKFILL EXCAVATION TO 6" BELOW BOTTOM OF STEEL FLOOR FRAMING, UNLESS DESIGNATED WITH EXCAVATION HATCH.

NOTE:
BUILDING FINISH FLOOR ELEVATION = SEE CIVIL, REF ELEVATION = 0'-0"
TOP OF ALL BUILDING FOOTING EL. = (+)0'-10"

DO NOT USE THIS DRAWING FOR CONSTRUCTION UNLESS APPROVED BY BIA IN THE SPACE BELOW.

DATE: _____
NAME: _____
SIGNED: _____

BAKER, INGRAM, & ASSOCIATES
STRUCTURAL ENGINEERS

TWO WHITE HORSE PIKE HADDON HEIGHTS, NJ 08035
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PROFESSIONAL SEAL

PROFESSIONAL IN CHARGE
P.L.C.
PROJECT MANAGER
M YOUNG
QUALITY CONTROL
B McGLADE
DRAWN BY
D MAHONEY

PROJECT NAME

MURPHY OIL CONVENIENCE STORE

PROJECT ADDRESS

PROJECT ADDRESS 2

FREY MOSS STRUCTURE

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FMS JOB NUMBER
G18MU
FMS MODEL NUMBER
XXXXXX

PROJECT NUMBER
20140922.5

SHEET TITLE

FOUNDATION PLAN

SHEET NUMBER

F1

ROAD NAME

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