




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CEILING NOTES	
AFF = ABOVE FINISH FLOOR	
ALL CEILING HEIGHTS ARE FROM ADJACENT FINISHED FLOOR	
CEILING HEIGHTS INDICATED ARE MINIMUM HEIGHTS. COORDINATE WITH PLUMBING, MECHANICAL, AND ELECTRICAL TO INSTALL CEILING AS HIGH AS POSSIBLE.	
ALL CEILING GRIDS ARE TO BE CENTERED IN ROOM UNLESS SHOWN OR NOTED OTHERWISE.	
USE 2x4 LAY-IN CEILING TILES CUT TO FIT AT ALL LOCATIONS LESS THAN 12" AT PERIMETER OF ROOM WHERE 2x4 TILES OCCUR. THEY SHALL MATCH SPECIFIED TILE AS INDICATED FOR EACH ROOM.	
COORDINATE WITH PLUMBING, MECHANICAL AND PLUMBING DRAWINGS AND PROVIDE FRAMING AS REQUIRED TO ACCOMMODATE MECHANICAL AND PLUMBING SYSTEMS	
1" REVEAL SHALL BE REQUIRED AT ALL AREAS WHERE GYPSUM INTERSECTS CIVIL	
COORDINATE MECHANICAL/ELECTRICAL FIXTURES LOCATED IN HIGH CEILING. ALL EQUIPMENT LOCATED SHALL MATCH COLOR OF CEILING GRID/CEILING TILE	

LIGHTING/ELECTRICAL NOTES	
COORDINATE LIGHTING LAYOUTS WITH ELECTRICAL DRAWINGS. CONTACT ARCHITECT WITH ANY DISCREPANCIES	


CEILING LEGEND	
FIXTURE TYPES - SEE ELECTRICAL	
CEILING TYPE	CEILING HEIGHTS
NC - NO CEILING (EXPOSED ROOF INSULATION SYSTEM)	90 = 9'-0" A.F.F.
GB - GYPSUM BOARD	90 = 9'-0" A.F.F.
L1 - 2x2 LAY-IN ACOUSTIC CEILING TILE AS SPECIFIED	90 = 9'-0" A.F.F.
L2 - 608 LAY-IN METAL CEILING TILE AS SPECIFIED	108 = 10'-0" A.F.F.
M - 2x2 MOISTURE RESISTANT LAY-IN CEILING TILE	90 = 9'-0" A.F.F.
REFER TO FINISH SYMBOLS ON PLAN FOR MATERIALS AND CEILING HEIGHTS	
CEILING TYPE	GB-90

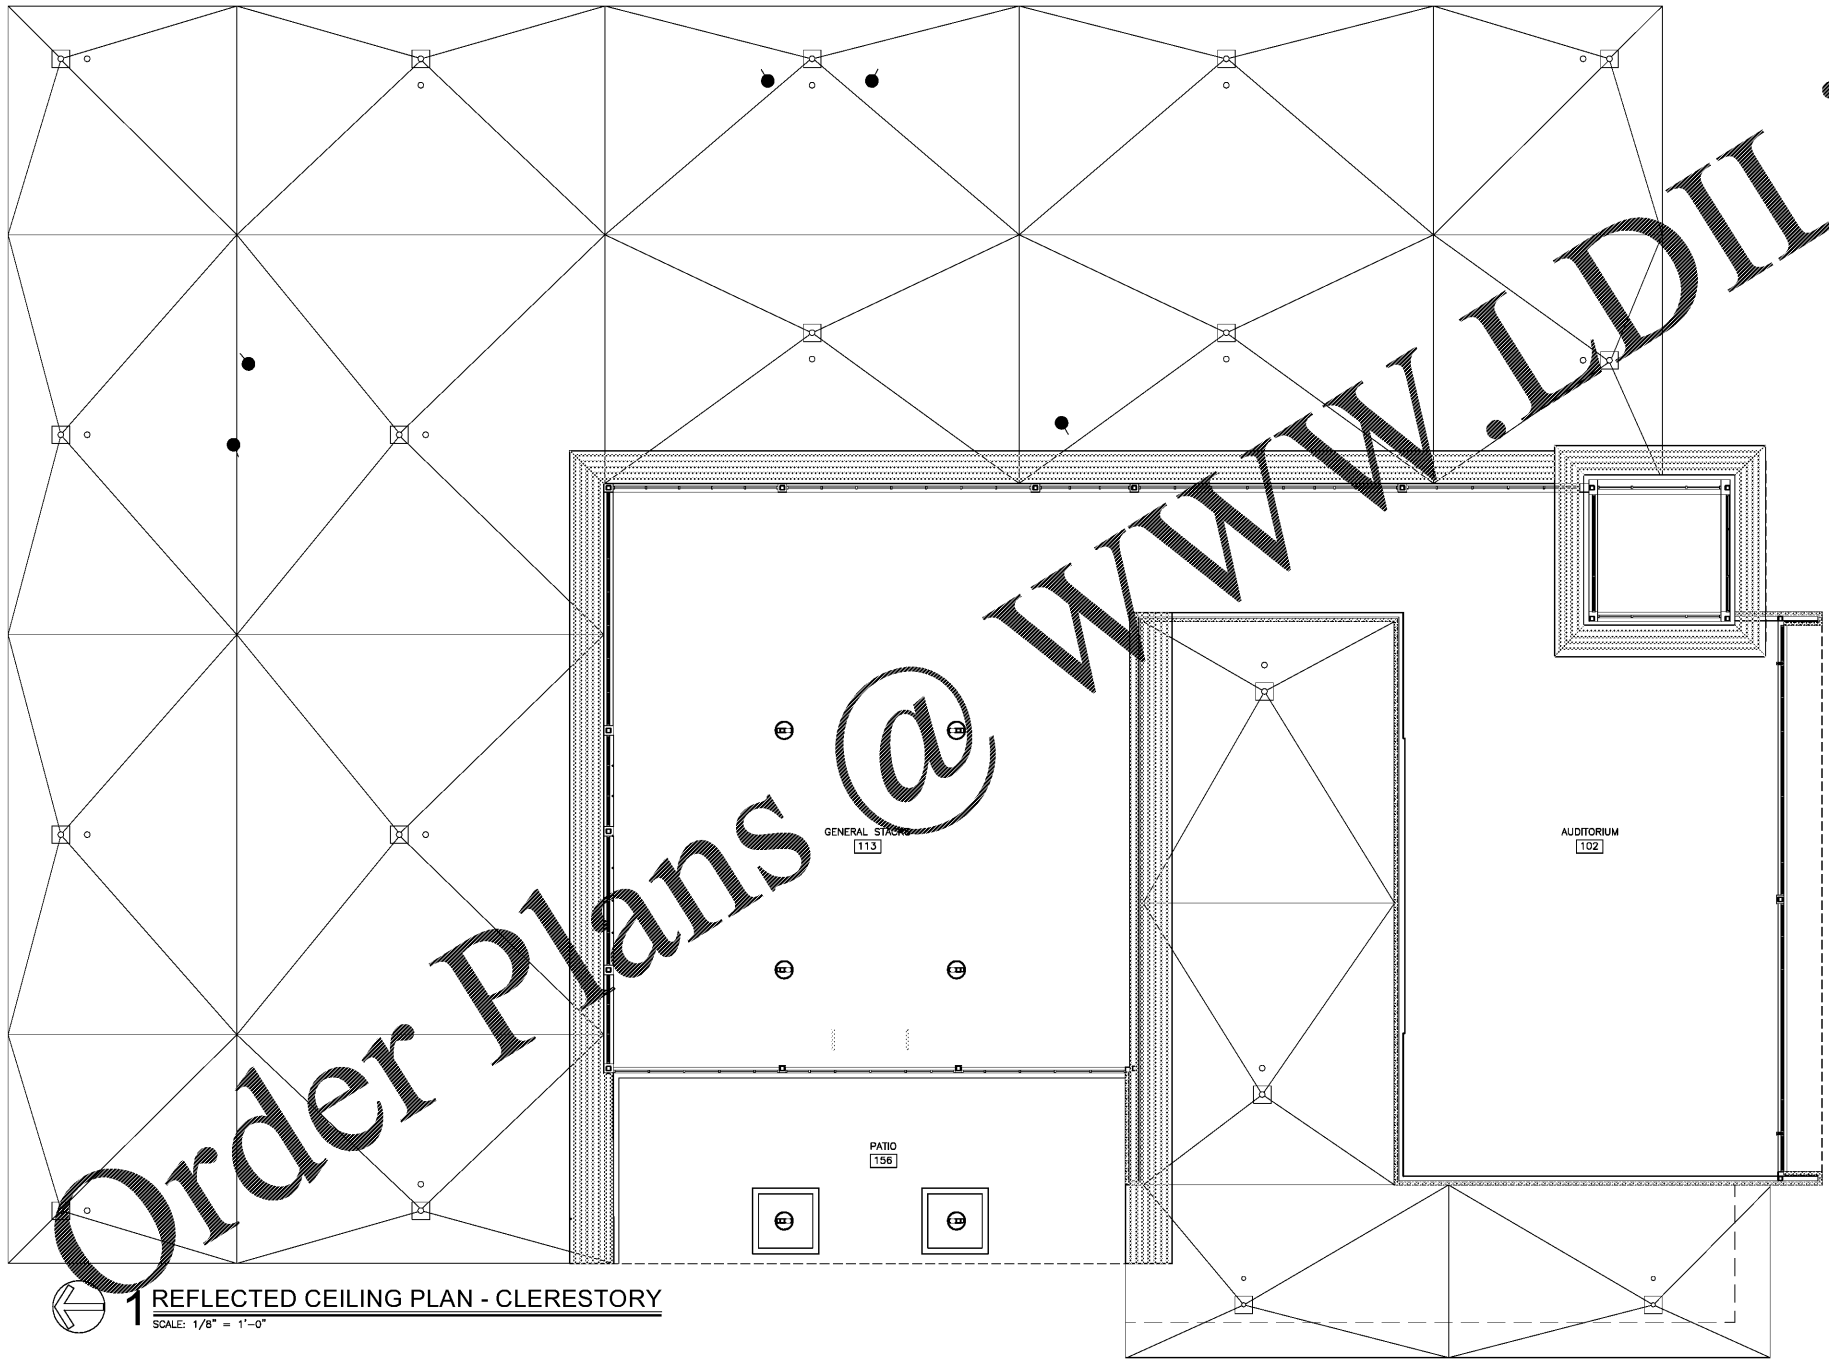

1 REFLECTED CEILING PLAN - CLERESTORY
SCALE: 1/8" = 1'-0"

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FOR THE CITY OF OPELIKA
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OPELIKA, ALABAMA 36801

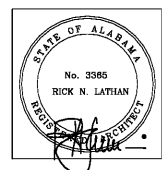

SHEET TITLE:
REFLECTED CEILING
PLAN-CLERESTORY

PROJ. MGR.: S. CALMA
DRAWN: BL
DATE: JUNE 01, 2020
CHECKED BY:
REVISIONS:

JOB NO. 19-32
SHEET NO.
A6.3
36 OF 37
SEQUENCE NO:
47 / 90

