



A X-BRACING DETAIL
SCALE: NONE

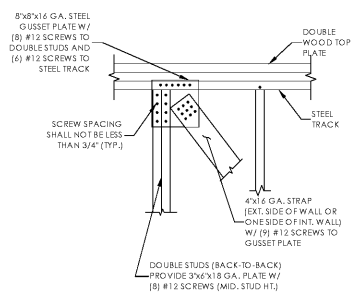

B X-BRACING DETAIL
SCALE: NONE

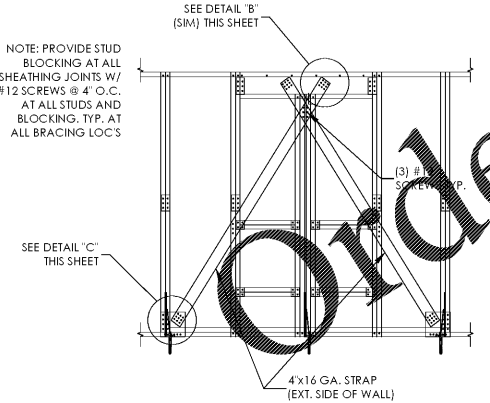


C V-BRACING DETAIL
SCALE: NONE


- NOTES:**
1. PROVIDE 4" CONCRETE SLAB ON GRADE REINFORCED W/ WWF 6x6-W1.4xW1.4 OVER 10 ML POLY VAPOR BARRIER OVER 4" POROUS BASE.
 2. VERIFY DIMENSIONS PRIOR TO CONSTRUCTION.
 3. TOP OF EXTERIOR FIG. VARIES
 4. SEE ARCH. DWGS. FOR DIMENSIONS NOT SHOWN.
 5. SEE DETAIL S/53 FOR RECESSED SLAB DETAIL. RECESS BATHROOM SLAB 2".
 6. SEE DETAIL 1/53 FOR SLAB CONTROL JOINTS (C.J.). ALTERNATE LAYOUT PLANS MAY BE SUBMITTED FOR APPROVAL.
 7. SEE ARCH. DWGS. FOR LOCATIONS OF RECESSED AND/OR SLOPED SLAB AREAS. REFER TO ARCHITECTURAL DRAWINGS FOR LOCATIONS. PROVIDE POSITIVE DRAINAGE FROM ALL PERIMETER WALLS TO FLOOR DRAIN. COORDINATE W/ PLUMBING DWGS.
 8. ALL DIMENSIONS ARE TO FACE OF STUD OR TO CENTERLINE.
 9. LOCATE CONTROL JOINTS UNDERNEATH NON-LOAD BEARING WALLS WHERE POSSIBLE.
 10. PROVIDE THREE STUD BEARING (WIN.) AT GIRDER TRUSSES W/ SIMPSON S/HHT14 AT STUD BASE.
 11. REFER TO ARCHITECTURAL DRAWINGS FOR RATED WALL LOCATIONS.
 12. SEE FOOTING SCHEDULE FOR SIZES AND REINFORCING.
 13. (2) #5-0" #5 BARS AT MID HEIGHT OF SLAB AT RE-ENTRANT CORNER.
 14. INTERIOR DIMS ARE TO CENTERLINE OF THICKENED SLABS AND FOOTINGS AND SHOULD NOT BE USED TO LOCATE INTERIOR WALLS. REFER TO ARCH FOR ALL DIMENSIONS NOT SHOWN.

METAL SHEAR WALL SCHEDULE		
LOCATION	EXTERIOR WALLS	CORRIDOR WALLS AND INTERIOR WALLS LABELED "SHEAR WALL"
1ST FLOOR BELOW ROOF	PROVIDE BRACES PER DETAILS ON THIS SHEET	APPLY 5/8" GYP BOARD TO BOTH FACES OF WALL. BLOCK ALL UNSUPPORTED EDGES. SCREW EACH FACE AT 4" O.C. AT ALL STUDS, TOP PLATES, SILL PLATES, AND BLOCKING

1. TIE INTERIOR SHEAR PANEL END STUDS TO EXTERIOR STUD WALL AND CORRIDOR STUD WALL WITH #10 SCREWS AT 6" O.C. WHERE INTERIOR SHEAR WALL END STUDS DO NOT CONNECT TO THE EXTERIOR STUD WALL OR THE CORRIDOR WALL PROVIDE DOUBLE END STUDS WITH (2) C516 STRAPS STUD TO STUD ACROSS FLOOR SYSTEM AND PROVIDE S/HHT14 TIE DOWN TO THE FOUNDATION LEVEL.
2. WHERE ADJACENT SHEATHING EDGES DO NOT FALL ON A COMMON MEMBER, STITCH SCREW ADJACENT FRAMING MEMBERS TOGETHER WITH #10 SCREWS AT 6" O.C. (TYPICAL)
3. EXTERIOR BRACES AND SCREW PATTERN @ INTERIOR SHEARWALLS MUST BE INSPECTED BY SI.

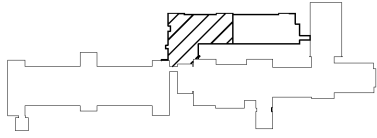

KEY PLAN

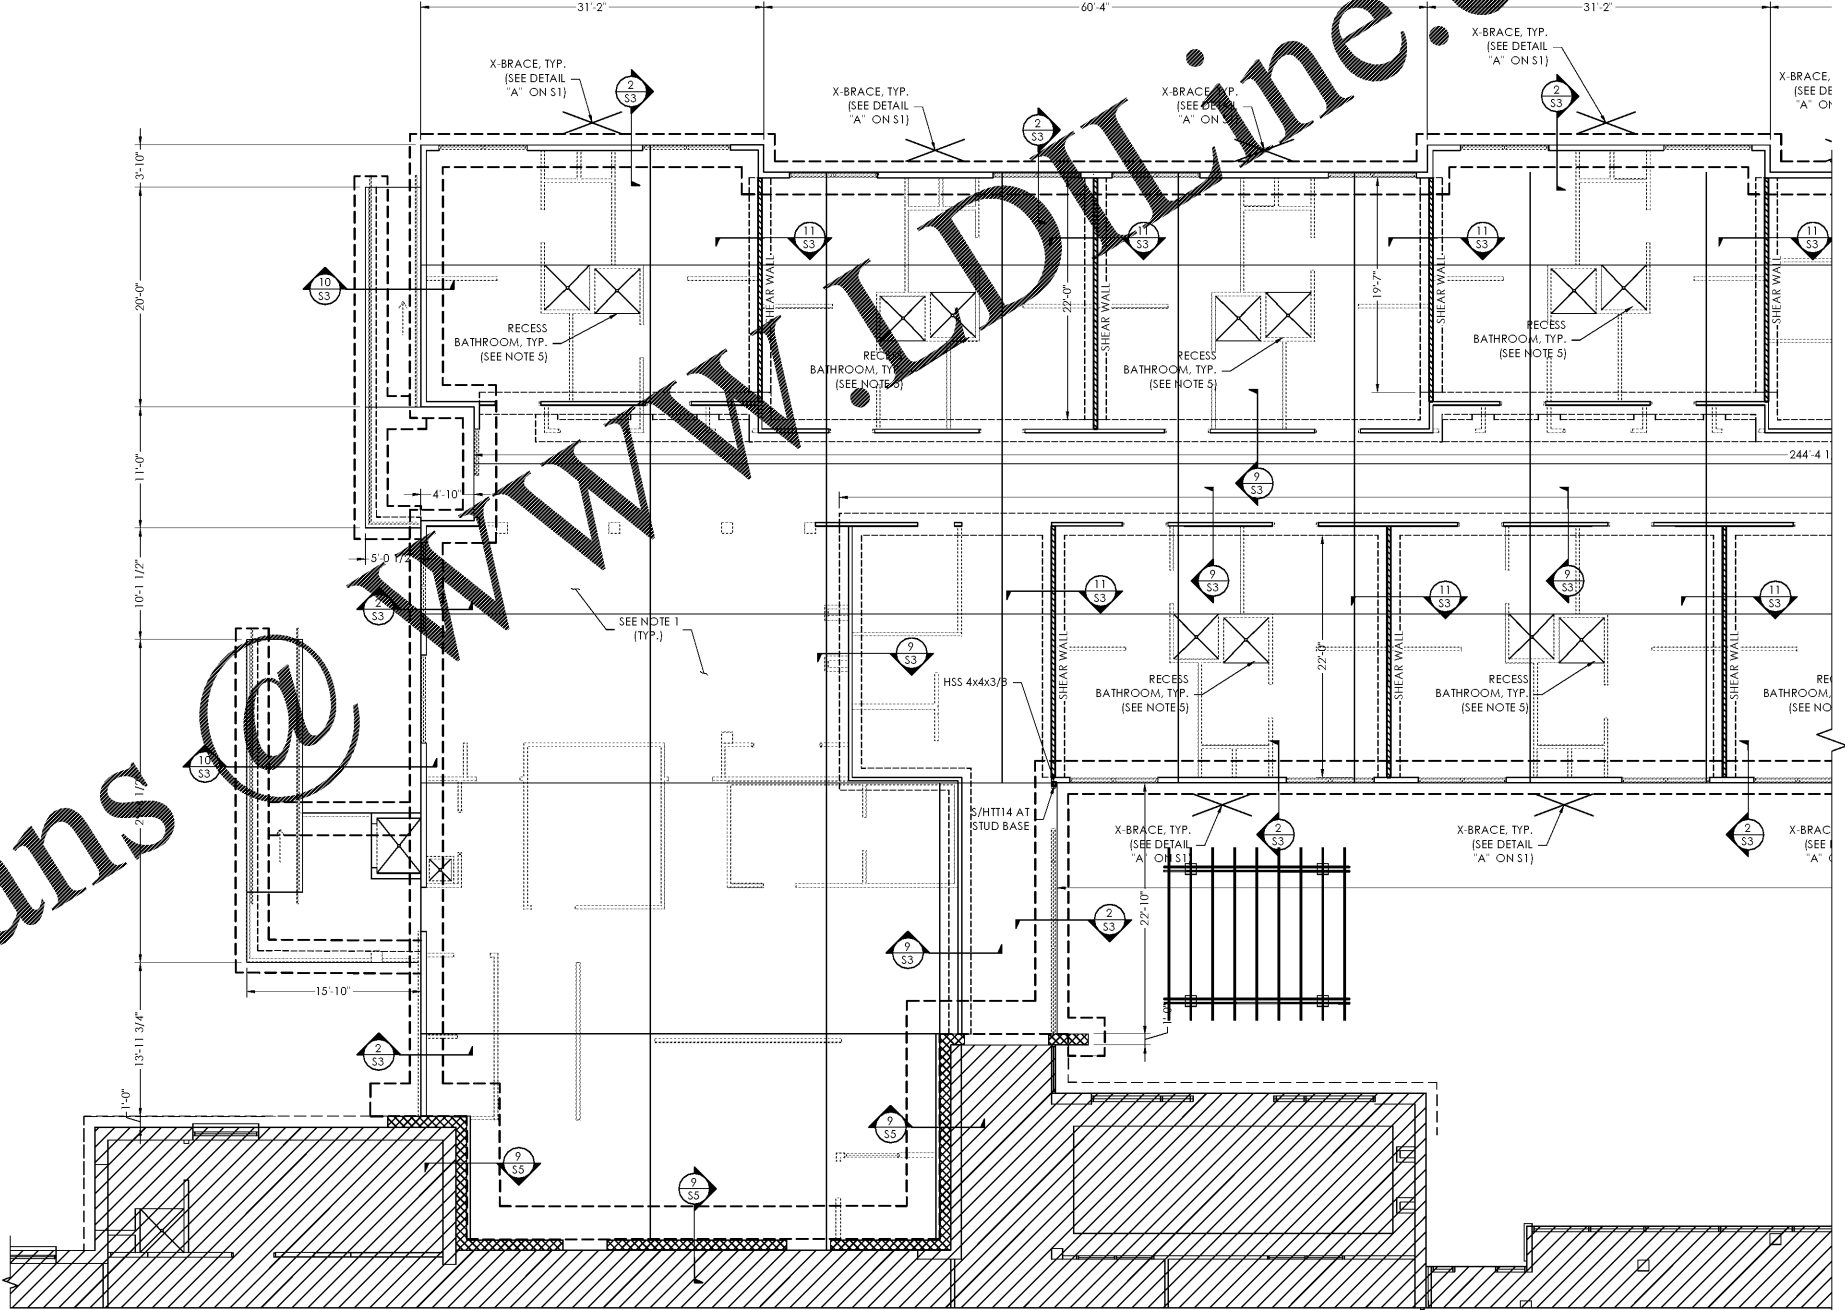

FOUNDATION PLAN
SCALE: 1/8"=1'-0"



ARCHITECT
TIMOTHY KURMASKIE
AIA, NCARB

Building A, Suite 003
1101 HAYNES ST.
Raleigh, NC 27604
Phone: 919-846-1600
Fax: 919-846-9404
TIM@ARCHITECTSKT.COM

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MICHAEL GABRIEL HAUSER, P.E.
GEORGIA LICENSE: PE038446
Hauser-Creech, Inc.
Structural Engineering Consultants

RENOVATION & ADDITION TO:
HERITAGE CARE OF HEALTHCARE OF SAVANNAH
12825 WHITE BLUFF ROAD
SAVANNAH, GA 31419

Project Reference Numbers
HC Project No.: 19-XXX-XXX
Drawn By: RJA

REVISIONS

DATES
PHASE ISSUED
BID SET 04-12-2019

FOUNDATION PLAN
SHEET NUMBER
S1.1
1 OF 8