

EROSION CONTROL STATEMENTS

"THE ESCAPE OF SEDIMENT FROM THE SITE SHALL BE PREVENTED BY THE INSTALLATION OF EROSION AND SEDIMENT CONTROL MEASURES AND PRACTICES PRIOR TO LAND DISTURBING ACTIVITIES."

"EROSION CONTROL MEASURES WILL BE MAINTAINED AT ALL TIMES. IF FULL IMPLEMENTATION OF THE APPROVED PLAN DOES NOT PROVIDE FOR EFFECTIVE EROSION CONTROL, ADDITIONAL EROSION AND SEDIMENT CONTROL MEASURES SHALL BE IMPLEMENTED TO CONTROL OR TREAT THE SEDIMENT SOURCE."

"ANY DISTURBED AREA LEFT EXPOSED FOR A PERIOD GREATER THAN 14 DAYS SHALL BE STABILIZED WITH MULCH OR TEMPORARY SEEDING."

"TEMPORARY EROSION CONTROL MATTING REQUIRED ON ALL 2:1 SLOPES. PERMANENT EROSION CONTROL MATTING REQUIRED IN ALL DITCHES."

CONTACT INFORMATION

PRIMARY PERMITTEE
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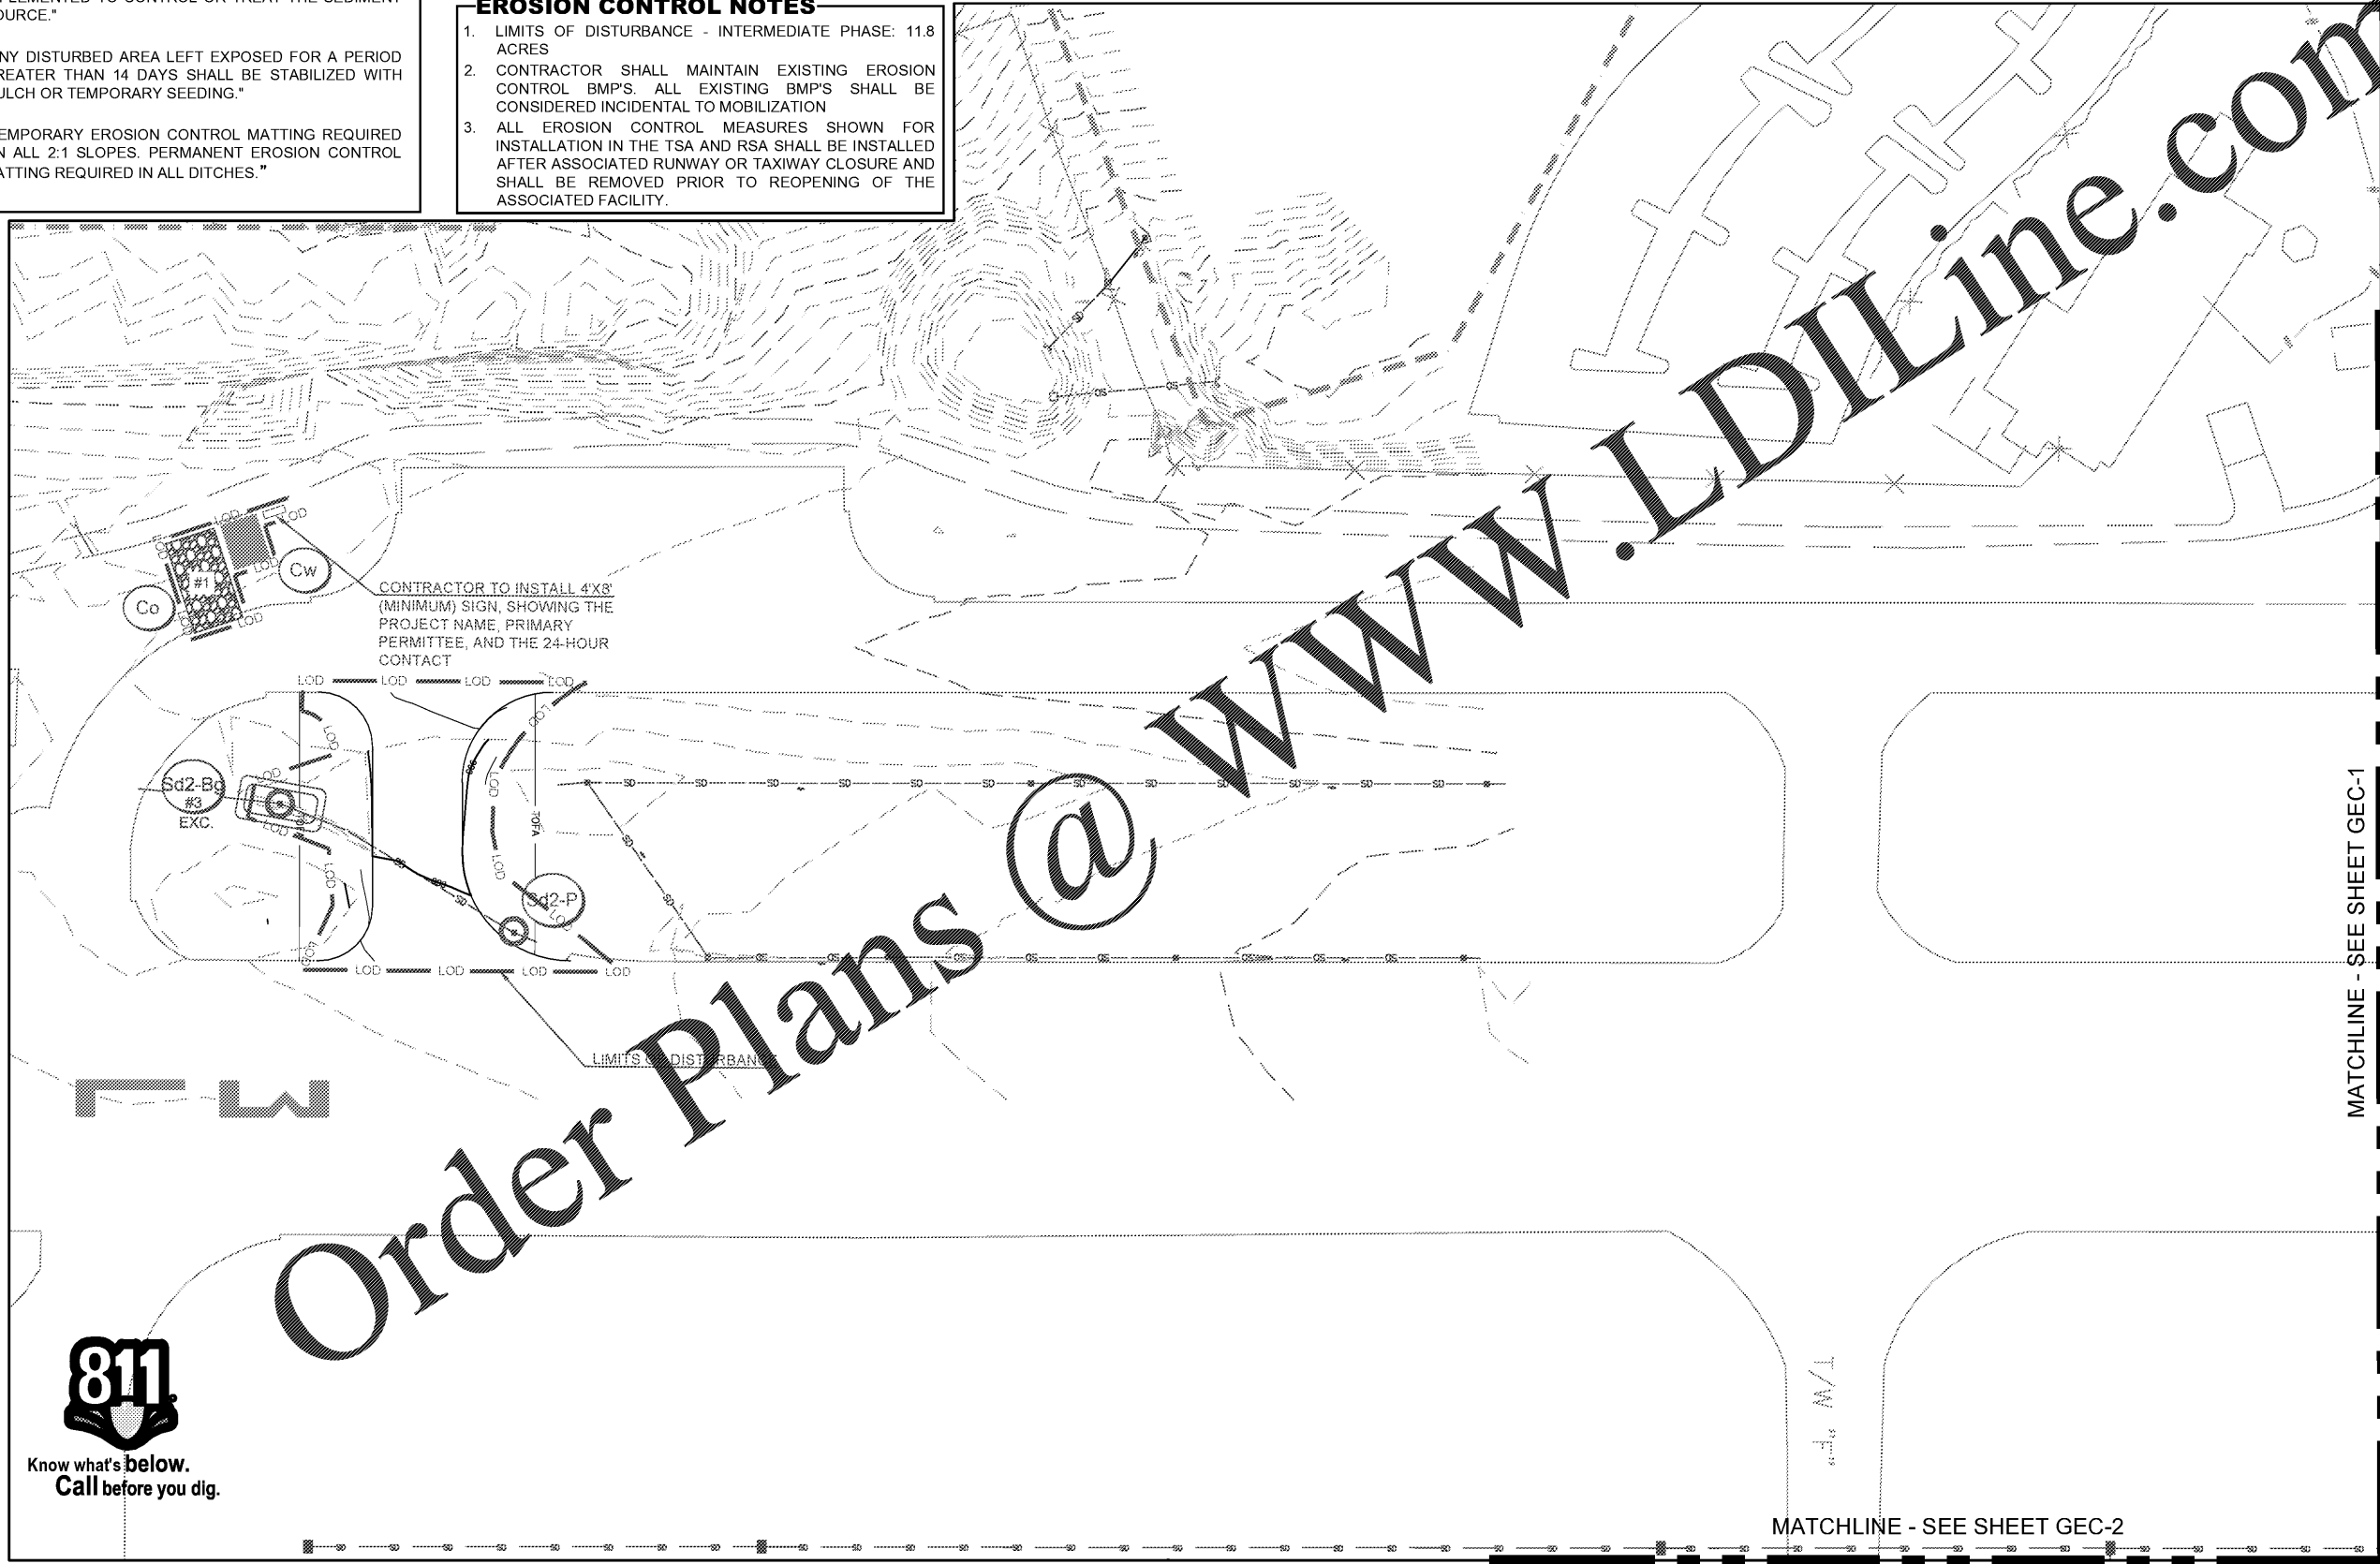
24 HOUR CONTACT
TBD
TBD

EROSION CONTROL NOTES

- LIMITS OF DISTURBANCE - INTERMEDIATE PHASE: 11.8 ACRES
- CONTRACTOR SHALL MAINTAIN EXISTING EROSION CONTROL BMP'S. ALL EXISTING BMP'S SHALL BE CONSIDERED INCIDENTAL TO MOBILIZATION
- ALL EROSION CONTROL MEASURES SHOWN FOR INSTALLATION IN THE TSA AND RSA SHALL BE INSTALLED AFTER ASSOCIATED RUNWAY OR TAXIWAY CLOSURE AND SHALL BE REMOVED PRIOR TO REOPENING OF THE ASSOCIATED FACILITY.

EROSION CONTROL LEGLEGEND

Co	CONSTRUCTION ENTRANCE	PAVEMENT TO BE REMOVED	Du	DUST CONTROL	Ds4	DISTURBED AREA STABILIZATION, SODDING	
Cw	CONCRETE WASHOUT	Sd2-P	INLET SEDIMENT TRAP, PIGS-IN-A-BLANKET OR SILT SOXX	Ds1	DISTURBED AREA STABILIZATION (W/ MULCHING)	Sd1-S	SILT FENCE - TYPE SENSITIVE SINGLE ROW
Sd3	TEMPORARY SEDIMENT BASIN	Sd2-F	INLET SEDIMENT TRAP, FILTER FABRIC	Ds2	DISTURBED AREA STABILIZATION, TEMPORARY SEEDING	Sd1-NS	SILT FENCE - TYPE NON SENSITIVE COMPOST FILTER SOCK
Fr	FILTER RING	Sd2-Bg	INLET SEDIMENT TRAP, BLOCK AND GRAVEL	Ds3	DISTURBED AREA STABILIZATION, PERMANENT SEEDING	CFS	COMPOST FILTER SOCK
LOD	LIMITS OF DISTURBANCE	Sk	SKIMMER	Cd-S	CHECK DAM		



Michael Baker INTERNATIONAL

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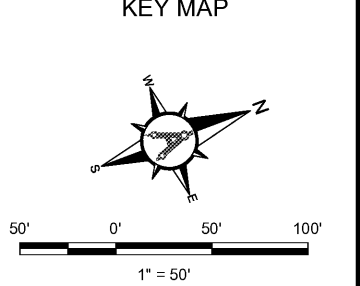
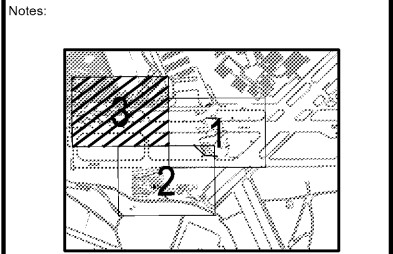
Checked by:
D. SKURKY

Project Number:
174297



GSWCC LEVEL II DESIGN PROF.
#0000072532 EXP. 10/21/2022

AULICK ENGINEERING LLC
HYDRAULICS & HYDROLOGY | EROSION CONTROL
AIRFIELD DESIGN | CONSTRUCTION MANAGEMENT



REVISIONS

No.	Description	Date	By

Project Name:
RUNWAY INCURSION MITIGATION IMPROVEMENTS (PDK 11)

Drawing Name:
ES&PCP INTERMEDIATE PHASE NO. 3

ITB# 20-101257

Date: **FEBRUARY, 2020** Sheet Number: **12** of **24**

Scale: **1" = 50'** Drawing Number: **GEC-3**



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