

REVISIONS

NO.	DESCRIPTION

RENEWED MEDICAL BUILDING
CORE & SHELL ONLY

SOUTH FULTON, GEORGIA
PROJECT #19-2983

03/27/2020



BRIAN J. FAGAN - PROFESSIONAL ENGINEER
GA LICENSE NUM. 32550 - EXP. 12/31/2020

MARCH 27, 2020

PERMIT SET

RELEASE DATE

Power Plan
First Floor

DRAWING TITLE

© COPYRIGHT 2020 JEFFERSON BROWNE GRESHAM ARCHITECTS, INC. THIS DOCUMENT IS AN INSTRUMENT OF SERVICE AND REMAINS THE PROPERTY OF JEFFERSON BROWNE GRESHAM ARCHITECTS AND NO PART THEREOF MAY BE REPRODUCED IN ANY FORM WITHOUT WRITTEN PERMISSION FROM JEFFERSON BROWNE GRESHAM ARCHITECTS.

FES PROJECT: 20007

FES Fagan Engineering Services, LLC
M.E.P. ENGINEERING
327 DAHLONEGA ST. STE 101B
CUMMING, GA 30040
(678) 648-4804

Drawn By:

CH JS

Checked By:

BF


PROJECT #

19-9883

E100

SHEET 3 of 3

ELECTRICAL LEGEND	
⊖	SIMPLEX RECEPTACLE (NEMA 5-15/20R)
⊖	DUPLEX RECEPTACLE (NEMA 5-15/20R)
⊖	COMBO RECEPT. / USB CHARGER MODEL (LAWSON TS832)
⊖	SPECIAL RECEPTACLE. SEE PLAN FOR DETAILS
⊖	208/240V RECEPTACLE (NEMA 6-20R)
⊖	QUAD RECEPTACLE (TWO SIMPLEX (NEMA 5-15/20R))
⊖	JUNCTION BOX
⊖	LOW VOLTAGE BOX, CIRCUIT AND PULL STRING TO WET CEILING FOR USE BY LOW VOLTAGE CONTRACTOR
⊖	LOW VOLTAGE BOX, CIRCUIT AND PULL STRING TO ABOVE CEILING FOR USE BY LOW VOLTAGE CONTRACTOR
⊖	HOMERUN TO PANEL (PANEL "A", CKT "1")
⊖	250V PANELBOARD (120/208V AND 120/240V)
⊖	DISCONNECT SWITCH
⊖	GROUND
A-17	PANEL A, CIRCUIT 17
⊖	SWITCH, SPECIFICATION GRADE
GR	GFCI RECEPTACLE (GROUND-FAULT CIRCUIT-INTERRUPTING)
GB	GFCI BREAKER (GROUND-FAULT CIRCUIT-INTERRUPTING)
WP	WEATHER-PROOF (RECEPTACLES IN WET LOCATIONS SHALL BE NEMA 3R WITH IN-USE COVERS PER NEC 406.9)

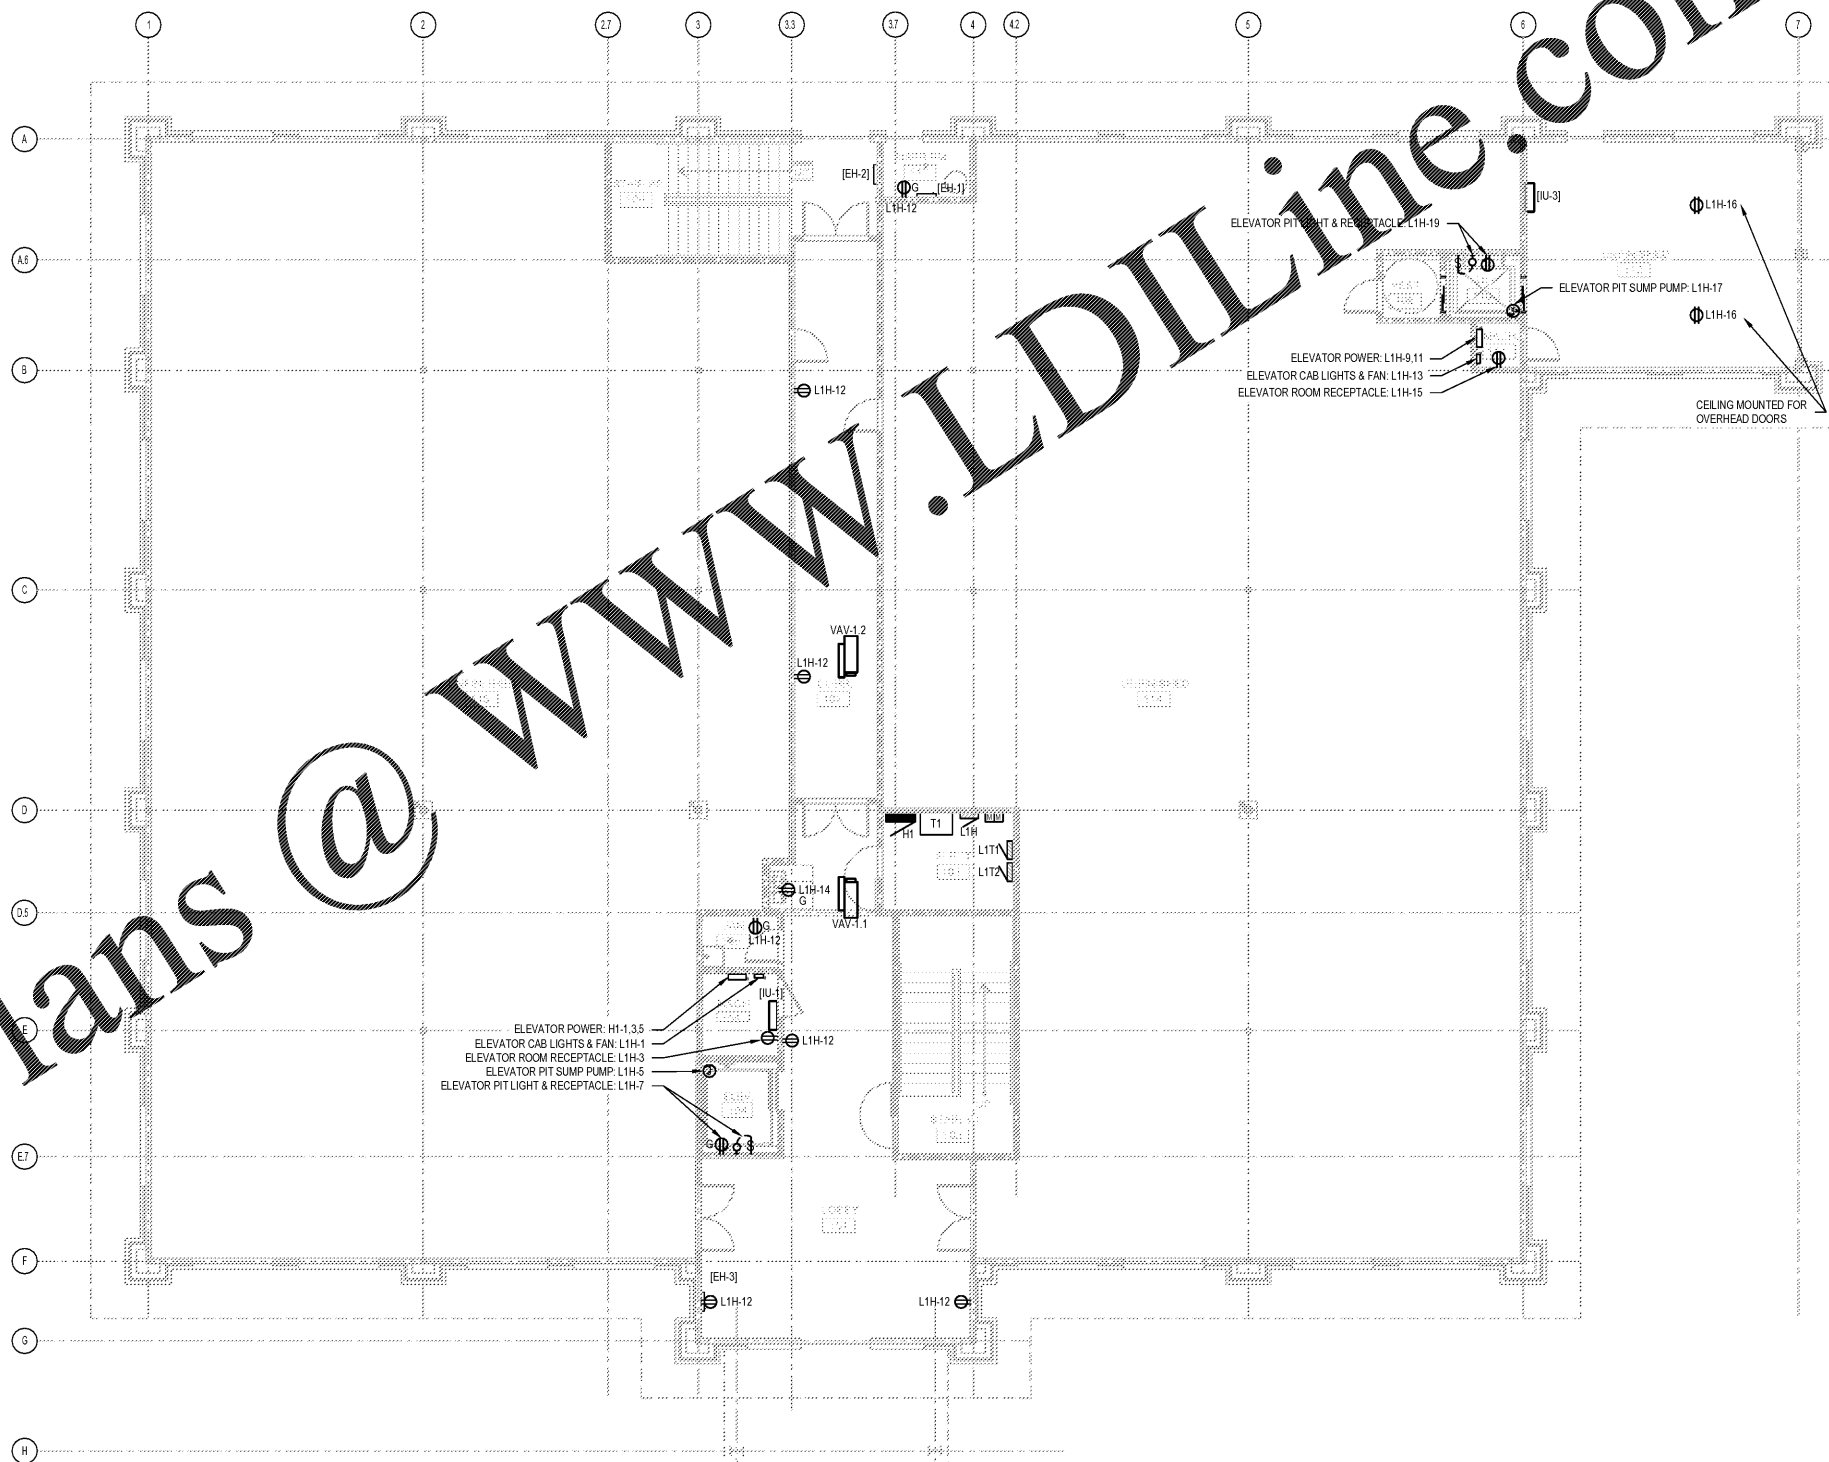

1 ELECTRICAL POWER PLAN - FIRST FLOOR
SCALE: 1/8"=1'-0"

Order Plans @ www.LDILine.com