


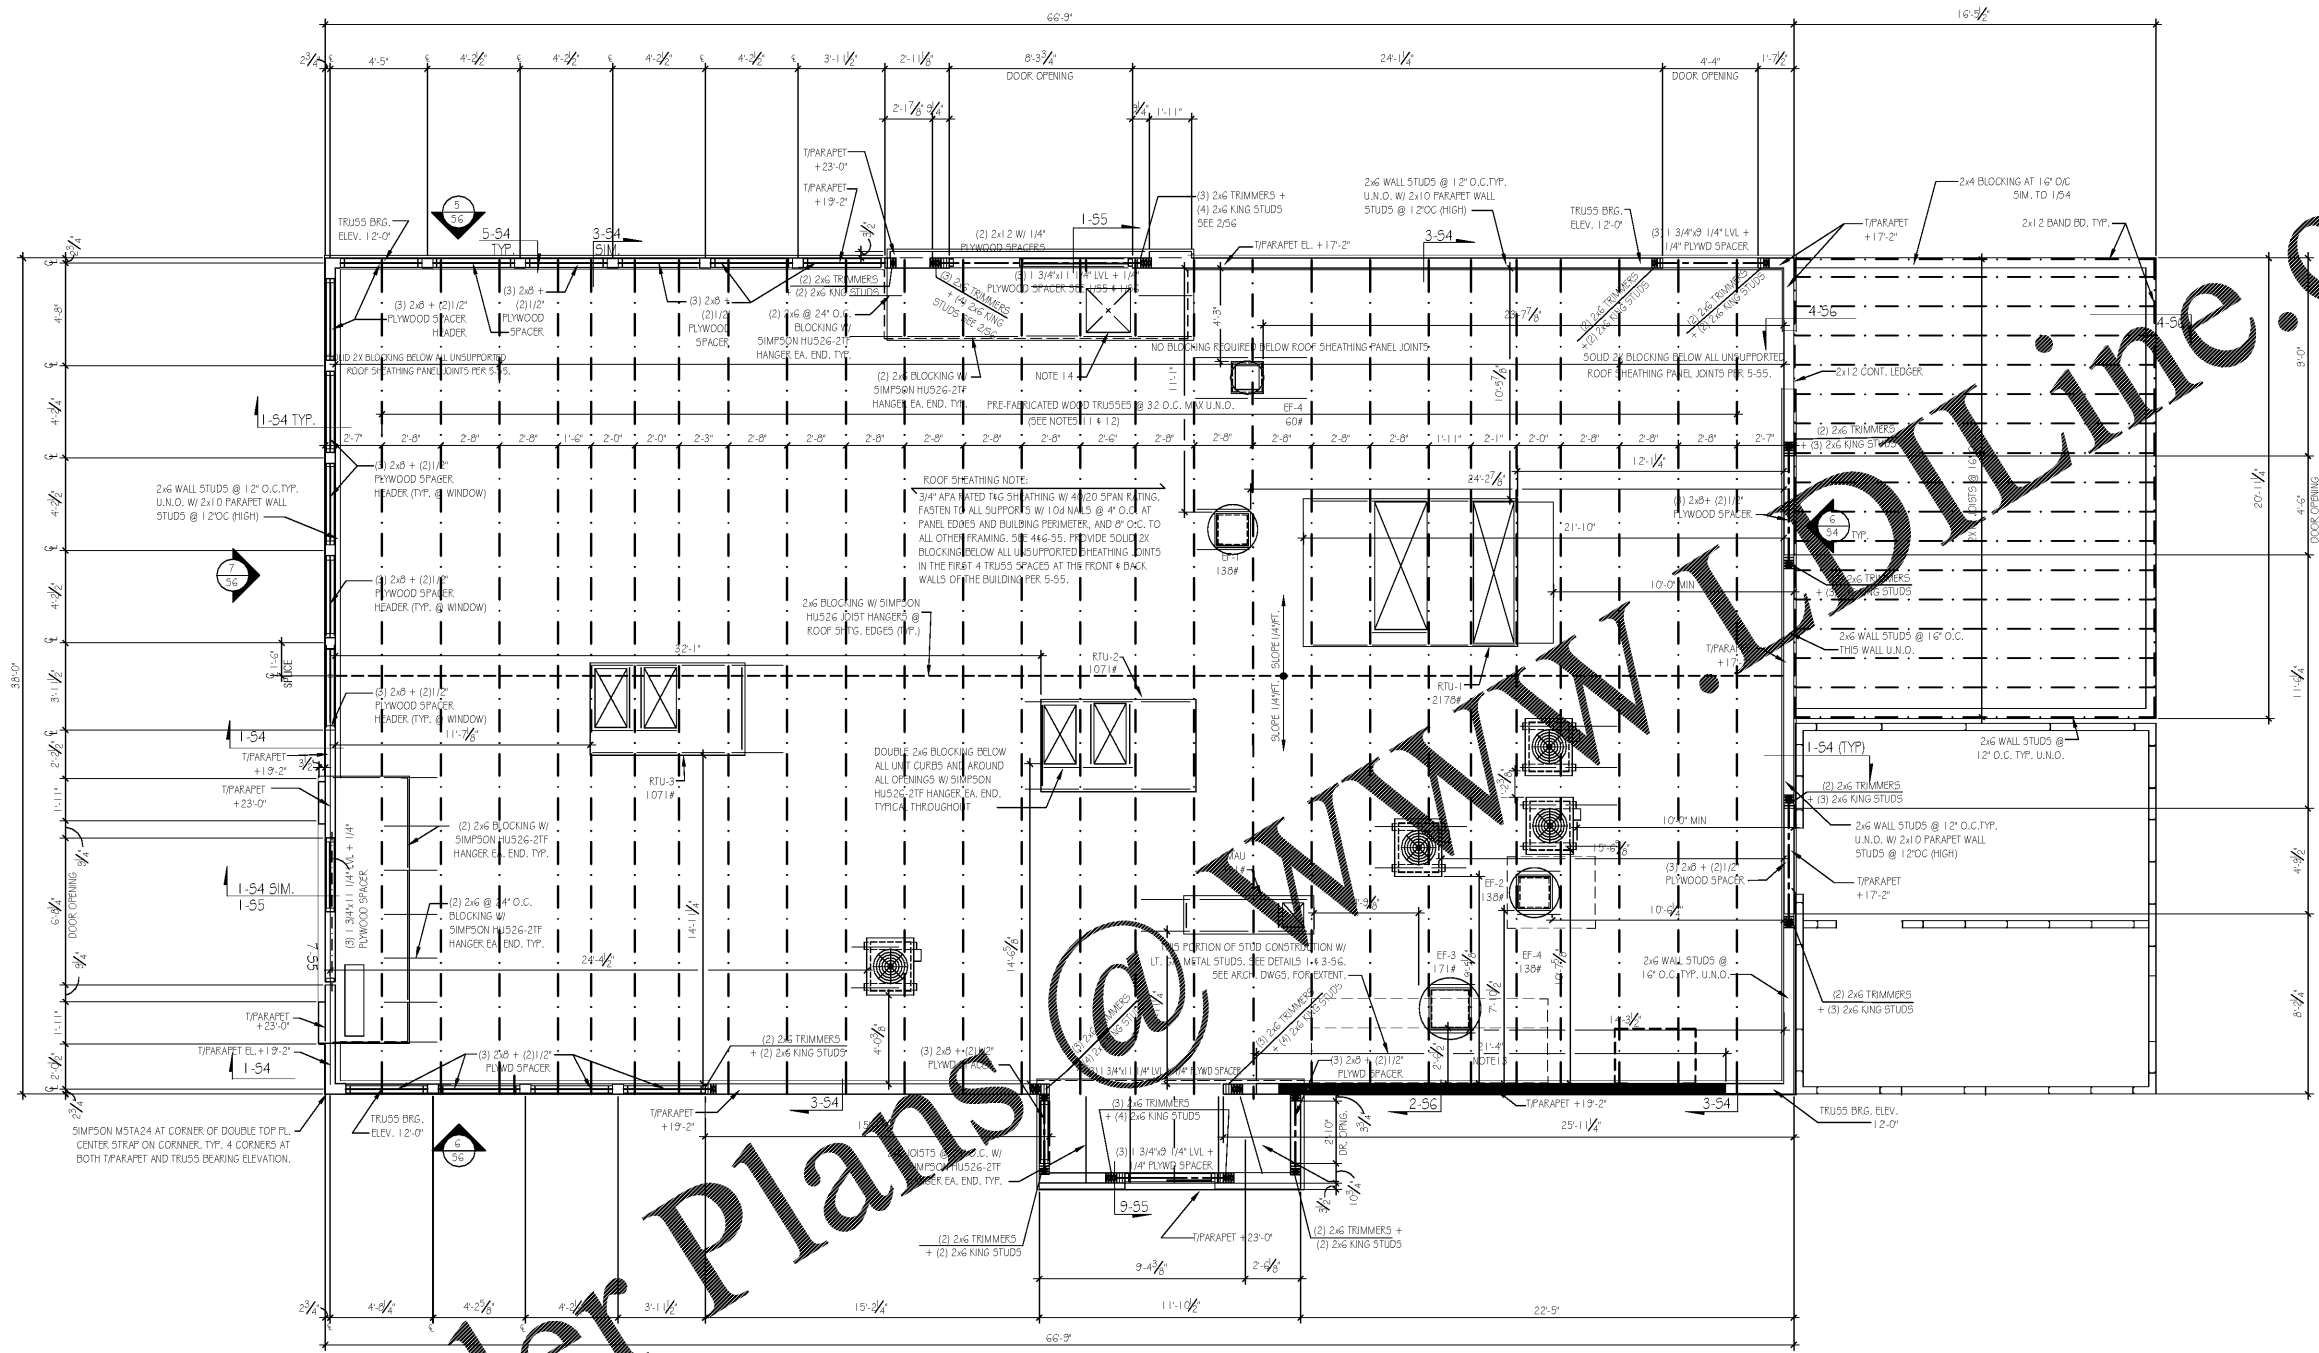

WALL STUD SIZE AND SPACING INDICATED DOES NOT INCLUDE BRICK / MASONRY CLADDING



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ROOF FRAMING PLAN NOTES


1. SEE SHEET 57 FOR GENERAL STRUCTURAL NOTES.
2. DIMENSIONS ARE TO OUTSIDE FACE OF STUD FRAMING (TYP.)
3. SEE FOUNDATION PLAN FOR SHEARWALL LAYOUT AND DIMENSIONS ON 105.
4. WALL SHEATHING TO BE 1/2" SHEATHING W/ 3/216 SPAN NAIL SHEATHING TO ALL FRAMING W/ 10d NAILS @ 6" O.C. U.N.O. IN SHEARWALL NOTES. ALL SHEATHING IN CONTACT WITH THE FOUNDATION WALLS SHALL BE PRESERVATIVE-TREATED MATERIAL (EXTERIOR WALL SHEATHING SHALL BE CONTINUOUS OVER THE WALL FRAMING AT ALL SHEAR WALLS)
5. PROVIDE 2X BLOCKING BEHIND ALL PANEL JOINTS IN SHEARWALLS. U.N.O.
6. REF. 6/54 FOR TYP. FRAMING ELEV. @ EXTERIOR OPENINGS
7. REF. 7 #8/54 FOR TYP. CONN. OF THE INT. NON-LOAD BRG. WALLS TO THE ROOF TRUSSES.
8. REF. 9/54 FOR TYP. WALL TOP PLATE SPLICE
9. REF. 10/54 FOR PARAPET STEP DOWN ELEV.
10. REF. 11/54 FOR TYP. HEADER DETAIL

11. SHOP DRAWINGS INCLUDING LAYOUT DRAWINGS, SPECIFICATIONS AND DESIGN CALCULATIONS FOR THE ROOF TRUSSES AND LAMINATED MEMBERS SHALL BE SUBMITTED FOR APPROVAL PRIOR TO ANY FABRICATION.
 NOTES:
 1.) SHOP DRAWINGS SHALL BE CERTIFIED BY A REGISTERED PROFESSIONAL ENGINEER. (FAXED OR REPRODUCED DOCUMENTS ARE NOT ACCEPTABLE)
 2.) G.C. SHALL ALLOW A MINIMUM OF (5) WORKING DAYS FOR REVIEW AND APPROVAL BY THE ARCHITECT/ENGINEER.
12. ROOF TRUSSES SHALL BE DESIGNED FOR ANY SPECIAL LOADING SUCH AS CONCENTRATED LOADS FROM HANGING PARTITIONS OR HVAC EQUIPMENT (SEE PLAN FOR LOCATION AND LOADS).
13. THIS PORTION OF WALL CONSTRUCTED W/ 5 1/2"x11/16" x 1 5/8" WIDE G60 GALV. MTL STUDS @ 12" OC SEE SECTIONS 1 THRU 3-56 SEE ARCH. DWGS. FOR EXTENT.
14. 2x2' ROOF HATCH REF 6/55 FOR FRAMING. REF ARCH. DWGS. FOR LOCATION.
15. NOT USED
16. REF 2/54 FOR RTU CURB ATTACHMENT.

G.C. SHALL SUBMIT ENGINEER SHOP DWGS. FOR APPROVAL PRIOR TO ANY CONSTRUCTION.

ROOF NOT DESIGNED FOR PONDING. SEE ARCHITECTURAL DRAWINGS FOR DRAIN REQR'MNTS.

EXTREME CARE SHALL BE USED IN ERECTING ROOF TRUSSES -

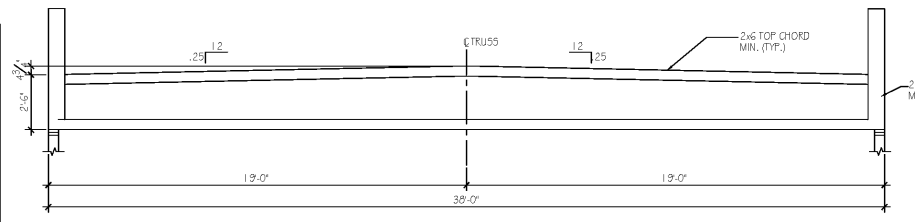

ROOF FRAMING PLAN NOTES

2 NOTES

3 TRUSS PROFILE

SCALE: 1/4"=1'-0" 4

NO.	DATE	REVISIONS

DRAWN BY: ES CHECKED BY: SH

ROOF FRAMING PLAN

DATE: 8-21-2019

SHEET NUMBER:

S2