


ENGQUEST, LLC. This drawing is intended to be used as a guide only. It is not to be used for construction. All dimensions, materials, and specifications are subject to change without notice. The user assumes all responsibility for the use of this drawing.

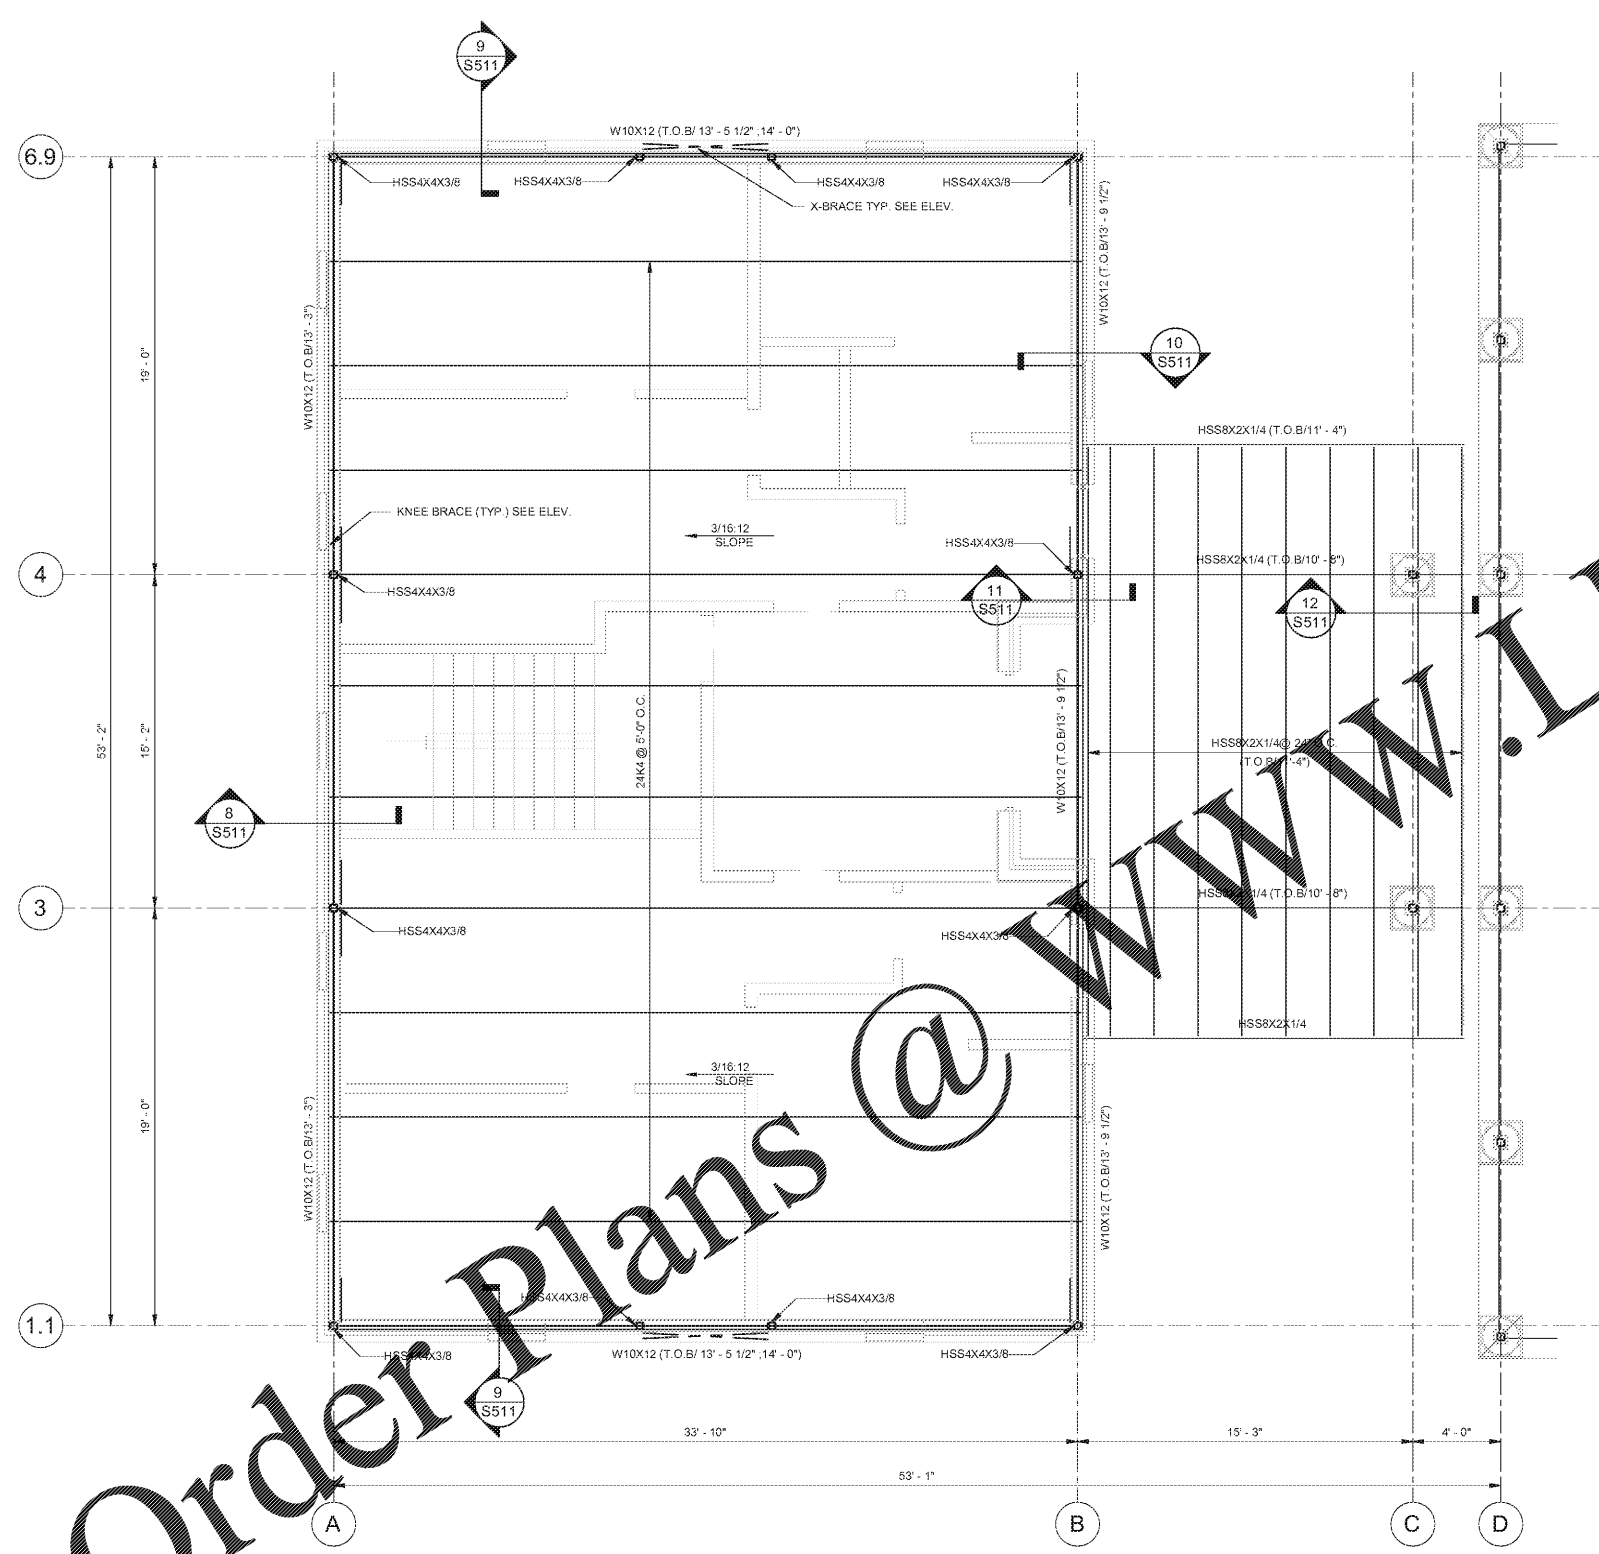

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SERVICED HOUSE-ROOF FRAMING PLAN



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- NOTES:
- SEE DWG S112, S113, S141, S142, S212 THROUGH S216 FOR STRUCTURAL STEEL DESIGN NOTES.
 - SEE PLAN FOR TOP OF STEEL ELEVATION
 - ATTACH STEEL DECK TO STEEL WITH 36/43 PATTERN.
SUPPORT FASTENERS: 5/8" PUDDLE WELDS
SIDELAP FASTENERS: #10 TEK SCREWS
 - ATTACH DECK TO PERIMETER SUPPORTS WITH SAME FASTENER PATTERN AND TYPE SHOWN ABOVE, BUT SPACING NOT MORE THAN 6".
 - ALL STRUCTURAL STEEL, MISCELLANEOUS STEEL AND STEEL JOISTS U.N.O. SHALL BE GIVEN ONE SHOP COAT AND ONE FIELD TOUCH UP PAINT, GRAY COLOR
 - ALL STEEL EXPOSED TO WEATHER SHALL BE HOT DIPPED GALVANIZED AND ALL VENT HOLES SHALL BE PLUG OR SEAL WELDED PRIOR TO ERECTION.
 - 1 1/2" (GALV. G60 PAINTED) TYPE B, 20 GA. METAL DECK FOR ROOF
 - BRIDGING - PROVIDE NUMBER OF ROWS HORIZONTAL ON DIAGONAL BRIDGING OF MATERIAL, SIZE AND TYPE REQUIRED BY SJS SPECIFICATIONS FOR TYPE OF JOIST, CHORD SIZE, SPACING AND SPAN. FURNISH ADDITIONAL ERECTION BRIDGING IF REQUIRED FOR STABILITY
 - FOR CONCRETE WALL SUPPORTING JOIST GIRDER, REF. DET. SHEET S501

SERVICED HOUSE-ROOF FRAMING PLAN
 SCALE: 1/4" = 1'-0"

REV.	DATE	BY	DESCRIPTION
A	1/22/18	DT	PERMIT ISSUE

JOB NO. 1710037
 DRAWN: TB
 CHECKED: DT
 SCALE: AS NOTED

S113
 DRAWING NO.