


12/10/2020 9:09 AM

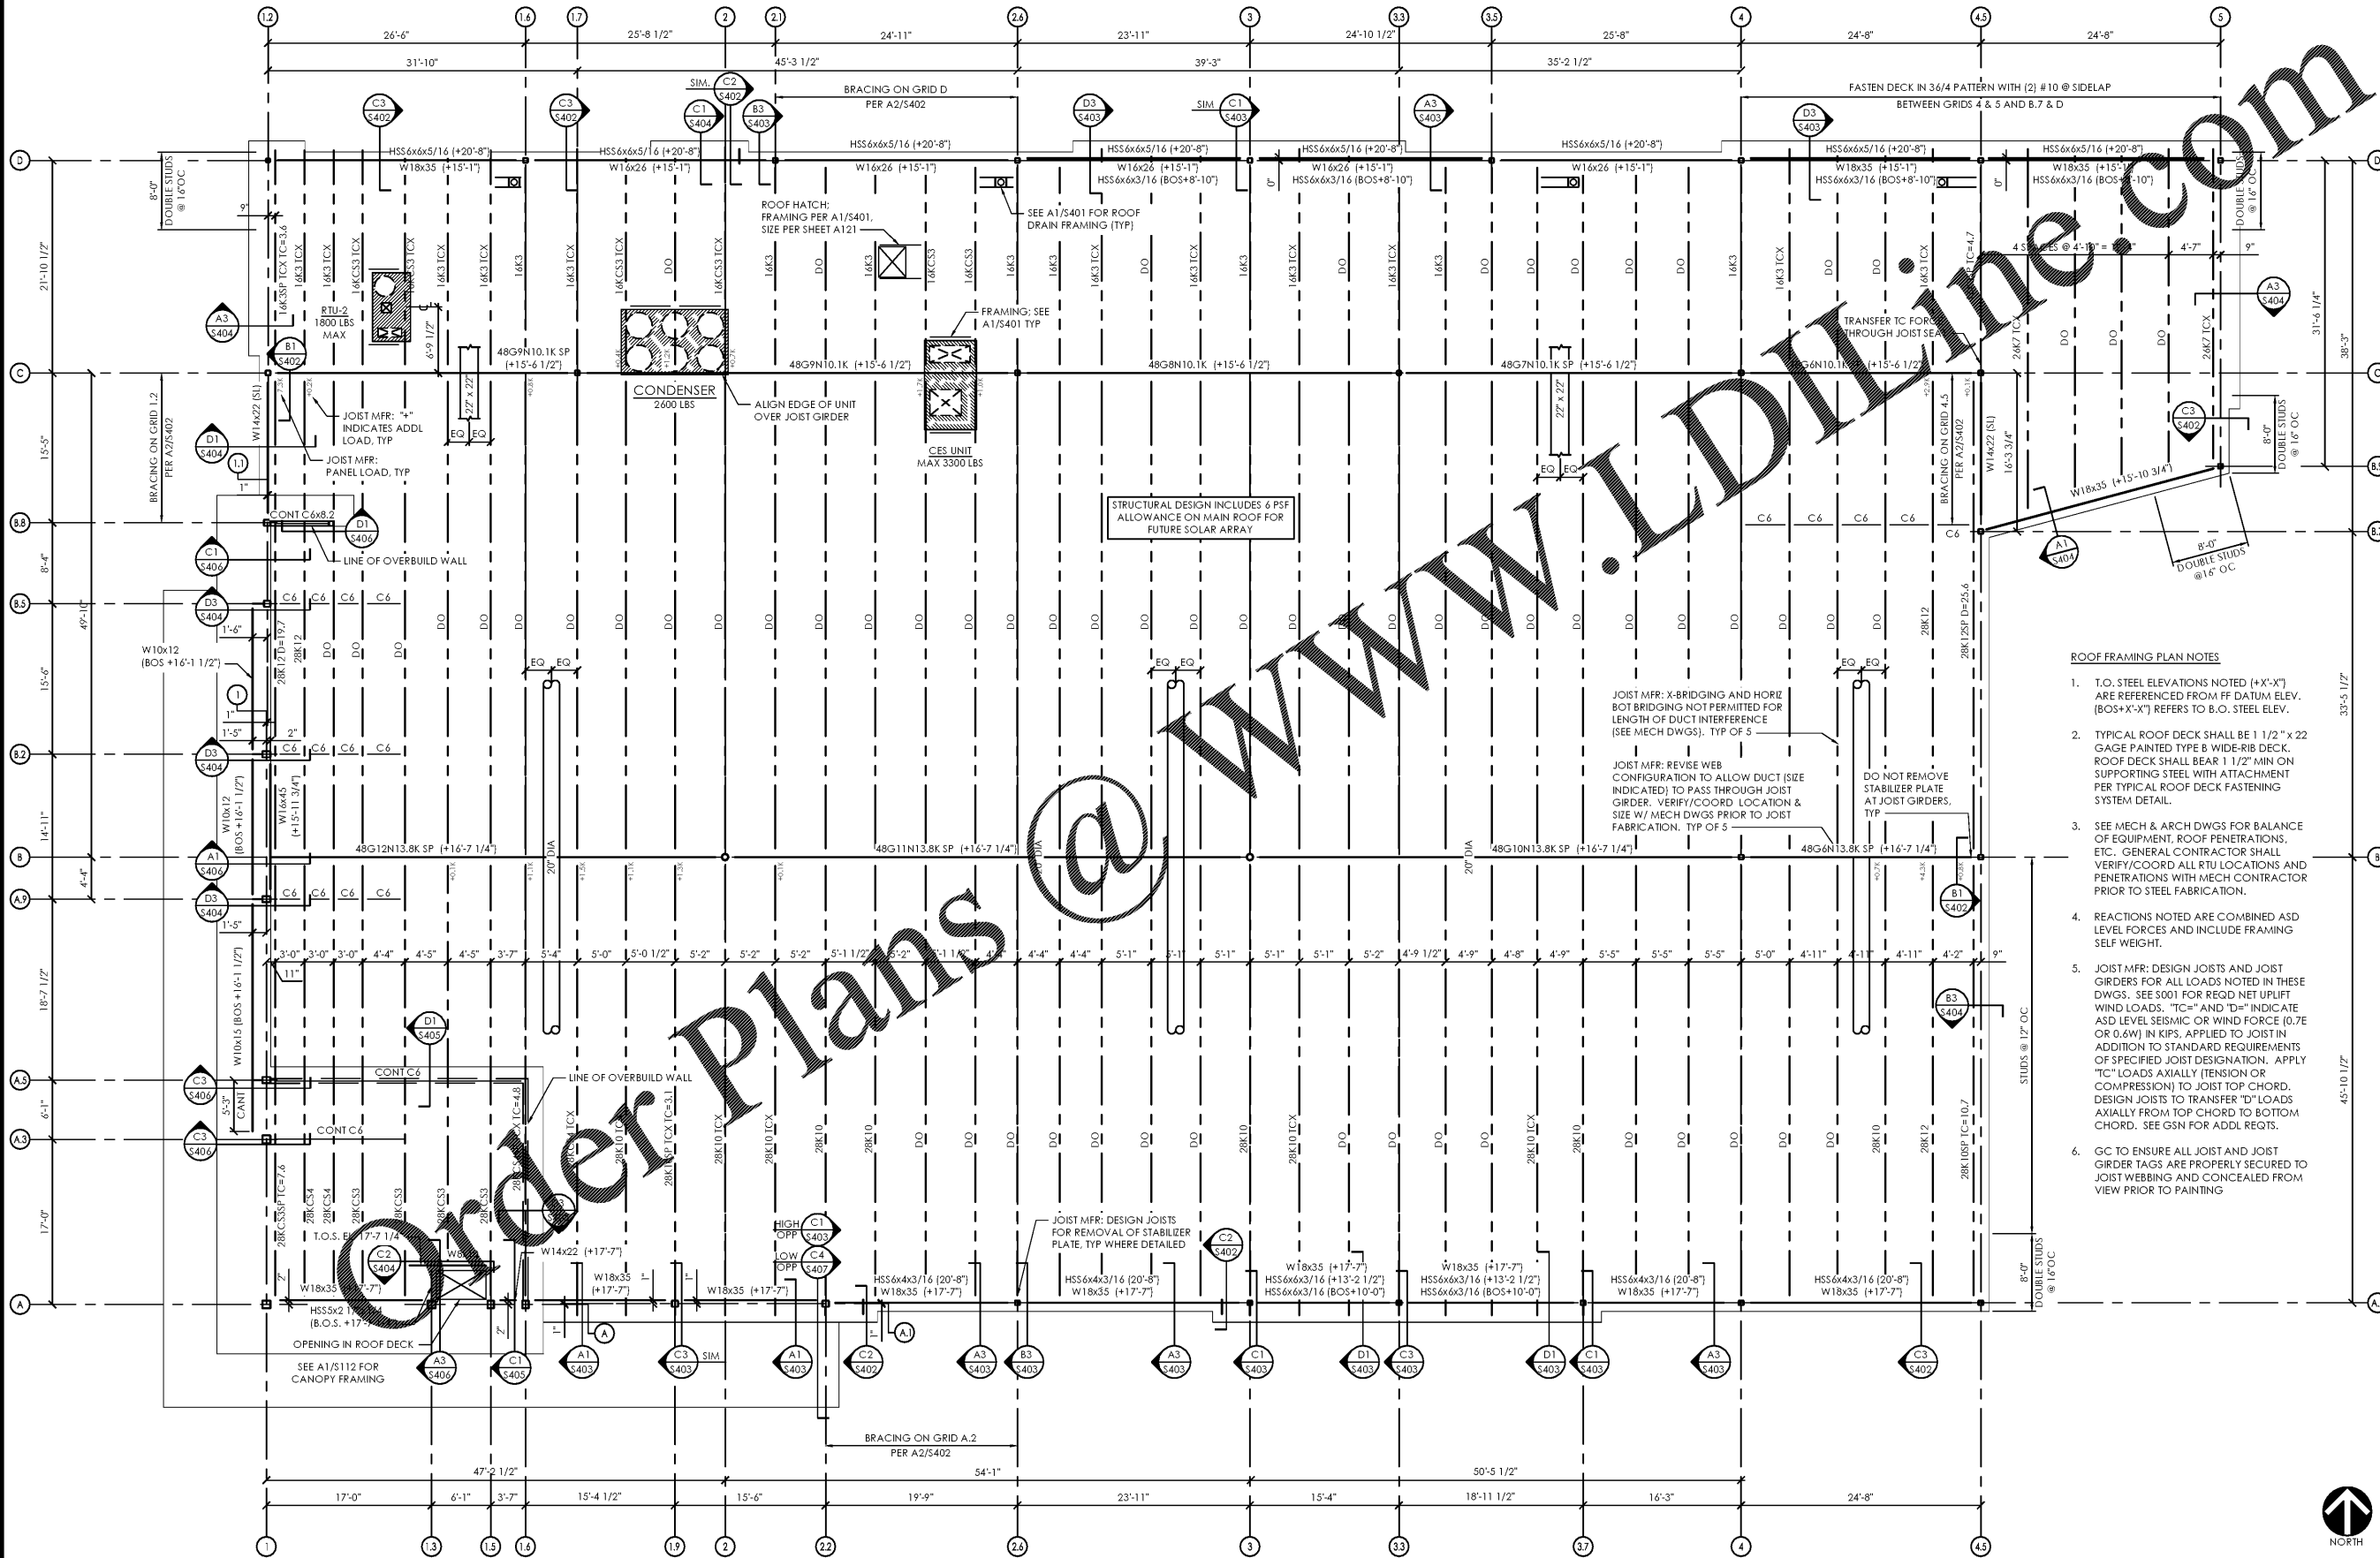


- ROOF FRAMING PLAN NOTES**
1. T.O. STEEL ELEVATIONS NOTED (+X'-X") ARE REFERENCED FROM FF DATUM ELEV. (BOS+X'-X") REFERS TO B.O. STEEL ELEV.
 2. TYPICAL ROOF DECK SHALL BE 1/2" x 22 GAGE PAINTED TYPE B WIDE-RIB DECK. ROOF DECK SHALL BEAR 1/2" MIN ON SUPPORTING STEEL WITH ATTACHMENT PER TYPICAL ROOF DECK FASTENING SYSTEM DETAIL.
 3. SEE MECH & ARCH DWGS FOR BALANCE OF EQUIPMENT, ROOF PENETRATIONS, ETC. GENERAL CONTRACTOR SHALL VERIFY/COORD ALL RTU LOCATIONS AND PENETRATIONS WITH MECH CONTRACTOR PRIOR TO STEEL FABRICATION.
 4. REACTIONS NOTED ARE COMBINED ASD LEVEL FORCES AND INCLUDE FRAMING SELF WEIGHT.
 5. JOIST MFR: DESIGN JOISTS AND JOIST GIRDERS FOR ALL LOADS NOTED IN THESE DWGS. SEE 5001 FOR REQD NET UPLIFT WIND LOADS. "TC=" AND "D=" INDICATE ASD LEVEL SEISMIC OR WIND FORCE (0.7E OR 0.6W) IN KIPS, APPLIED TO JOIST IN ADDITION TO STANDARD REQUIREMENTS OF SPECIFIED JOIST DESIGNATION. APPLY "TC" LOADS AXIALLY (TENSION OR COMPRESSION) TO JOIST TOP CHORD. DESIGN JOISTS TO TRANSFER "D" LOADS AXIALLY FROM TOP CHORD TO BOTTOM CHORD. SEE GSN FOR ADDL REGTS.
 6. GC TO ENSURE ALL JOIST AND JOIST GIRDER TAGS ARE PROPERLY SECURED TO JOIST WEBBING AND CONCEALED FROM VIEW PRIOR TO PAINTING

Issued:	Date:
A Client Review Set	05/07/19
B Permit Set	06/12/19
C Client Review Set	02/07/20
D Bid Set	02/10/20
Revisions:	Date:

DO NOT SCALE PLANS

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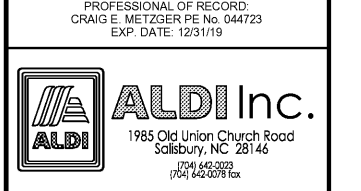

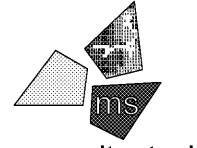
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Seal

PROFESSIONAL OF RECORD:
 CRAIG E. METZGER PE No. 044723
 EXP. DATE: 12/31/19



ALDI Inc. Store #: 154
 Cornelius, NC
 20101 West Catawba Avenue
 Cornelius, NC 28031
 Mecklenburg County
 Project Name & Location:

Roof Framing Plan	
Drawing Name:	
Prototype Rls. 12/10/18	Project No. 40452-07
Type: LHSD-V8ER	
	S-111
Scale: A: 1/8"=1'-0" Drawing No.	

