


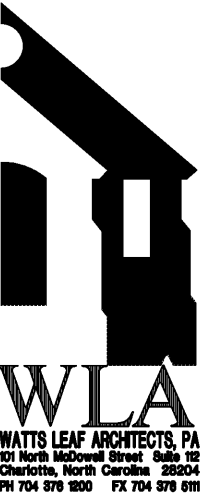

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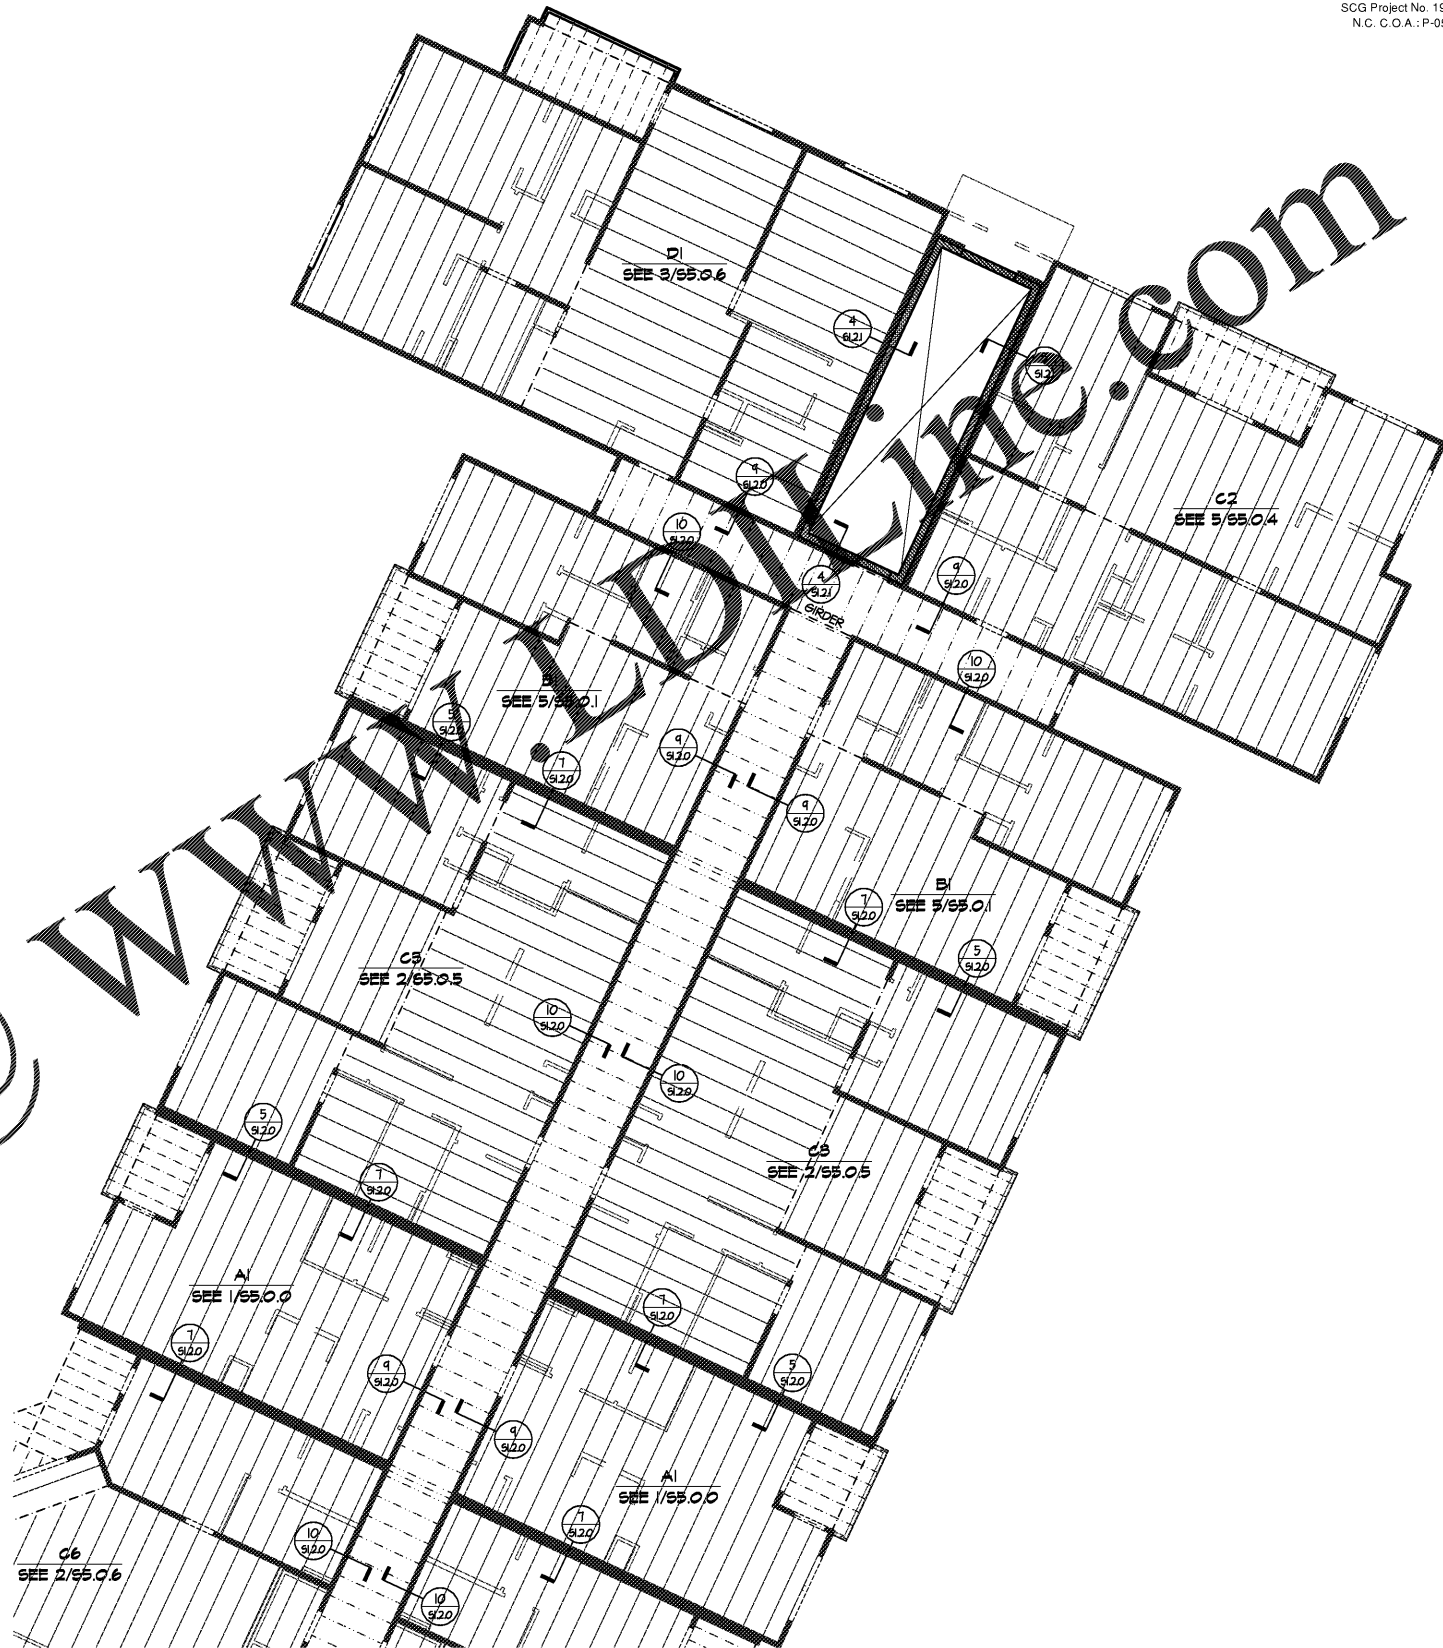
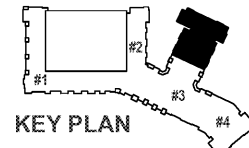
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03FEB20
 PRICING
 SET

PROJECT 1915
 DATE 06NOV19
 DRAWN BY SCG
 CHECKED BY F80

PARTIAL FLOOR FRAMING
 PLAN - BUILDING #3 -
 347.13'

S3.5.3A



WOOD BEAM/HEADER SCHEDULE **					
MARK	MEMBER***	MARK	MEMBER***	MARK	MEMBER***
2-6	(2) 2x6*	2-7L	(2) 1 3/4"x1 1/4" LVL	35-4P	3 1/2"x4 1/4" PSL
2-8	(2) 2x8*	2-4L	(2) 1 3/4"x4 1/4" LVL	35-11P	3 1/2"x11 1/4" PSL
2-10	(2) 2x10*	2-11L	(2) 1 3/4"x11 1/4" LVL	35-12P	3 1/2"x11 7/8" PSL
2-12	(2) 2x12*	2-12L	(2) 1 3/4"x11 7/8" LVL	35-14P	3 1/2"x14" PSL
3-6	(3) 2x6*	2-14L	(2) 1 3/4"x14" LVL	35-16P	3 1/2"x16" PSL
3-8	(3) 2x8*	2-16L	(2) 1 3/4"x16" LVL	35-18P	3 1/2"x18" PSL
3-10	(3) 2x10*	2-18L	(2) 1 3/4"x18" LVL	5-4P	5 1/4"x4 1/4" PSL
3-12	(3) 2x12*	3-7L	(3) 1 3/4"x1 1/4" LVL	5-11P	5 1/4"x11 1/4" PSL
4-6	(4) 2x6*	3-4L	(3) 1 3/4"x4 1/4" LVL	5-12P	5 1/4"x11 7/8" PSL
4-8	(4) 2x8*	3-11L	(3) 1 3/4"x11 1/4" LVL	5-14P	5 1/4"x14" PSL
4-10	(4) 2x10*	3-12L	(3) 1 3/4"x11 7/8" LVL	5-16P	5 1/4"x16" PSL
4-12	(4) 2x12*	3-14L	(3) 1 3/4"x14" LVL	5-18P	5 1/4"x18" PSL
(2) SF - INDICATES (2) 1/2" STEEL FLITCH PLATES WITH 1/2" THRU-BOLTS @ 12" o.c. STAGGERED. REFER TO 4/51.2.4 FOR FLITCH PLATE DETAIL.		3-16L	(3) 1 3/4"x16" LVL	7-4P	7"x4 1/4" PSL
		3-18L	(3) 1 3/4"x18" LVL	7-11P	7"x11 1/4" PSL
		4-7L	(4) 1 3/4"x1 1/4" LVL	7-12P	7"x11 7/8" PSL
		4-4L	(4) 1 3/4"x4 1/4" LVL	7-14P	7"x14" PSL
		4-11L	(4) 1 3/4"x11 1/4" LVL	7-16P	7"x16" PSL
		4-12L	(4) 1 3/4"x11 7/8" LVL	7-18P	7"x18" PSL
		4-14L	(4) 1 3/4"x14" LVL		
		4-16L	(4) 1 3/4"x16" LVL		
		4-18L	(4) 1 3/4"x18" LVL		

* PROVIDE 1/2" PLYWOOD BETWEEN PILES AT INTERIOR CONDITIONS
 ** REFER TO NOTE 9 OF 'WOOD FRAMING NOTES' ON SHEET S1.0.0 FOR HANGERS TO BE USED IF NOT SPECIFIED ON FRAMING PLANS OR IN FRAMING NOTES. (PLEASE NOTE THAT SOME BEAM TYPES MAY NOT BE SPECIFIED IN THIS PROJECT)
 *** MEMBERS SHOWN DASHED ON FRAMING PLANS TO BE DROPPED BELOW FLOOR CAVITY. MEMBERS SHOWN SOLID ON FRAMING PLANS TO BE WITHIN FLOOR CAVITY UNLESS NOTED OTHERWISE.

FLOOR FRAMING NOTES:

- INDICATES 16' DEEP OPEN WEB TRUSSES SPACED 24' o.c. MAXIMUM AT UNIT WALLS UNLESS NOTED OTHERWISE. TRUSS LAYOUT IS FOR SCHEMATIC PURPOSES ONLY, AND TRUSS SHOP DRAWINGS SHOULD BE REFERENCED FOR LOCATION OF TRUSSES. TRUSSES TO ALIGN AT ALL WALLS. TRUSS DESIGNER SHALL COORDINATE TRUSS SPACING WITH FIXTURE LOCATIONS PER FINISH DRAWINGS, AND MECHANICAL CLOSETS PER MECHANICAL DRAWINGS. TOPPING TO BE 1" MAXIMUM CONCRETE.
- PROVIDE A MINIMUM OF (2) STUDS (MAXIMUM SPACING 16" o.c.) AT EACH END OF BEAMS UNLESS NOTED OTHERWISE. MINIMUM EACH END OF HEADERS UNLESS NOTED OTHERWISE.
- REFER TO ARCHITECTURAL AND MECHANICAL PLANS FOR FLOOR OPENINGS.
- REFER TO S1.0.0 FOR ADDITIONAL STRUCTURAL NOTES.
- INDICATES LOAD BEARING UNIT WALL. WALLS NOT SHOWN SOLID ARE NOT TO BE USED FOR BEARING. REFER TO WALL SCHEDULE FOR WALL GRADE AND SPACING.
- INDICATES 2x8 PRESSURE TREATED JOISTS SPACED 16' o.c. MAXIMUM AT UNIT BALCONIES, UNLESS NOTED OTHERWISE ON PLANS. BALCONIES TO HAVE SLOPED (2" MAXIMUM) CONCRETE TOPPING.
- INDICATES 12' OPEN WEB TRUSSES @ 24' o.c. MAXIMUM AT BREEZEWAYS UNLESS NOTED OTHERWISE. BREEZEWAY GIRDERS TO BEAR DIRECTLY ON UNIT WALLS. TOPPING TO BE 1" MAXIMUM CONCRETE.
- FLOOR FINISHING PER NOTE 9 OF 'HORIZONTAL AND UPLIFT LOAD SYSTEM NOTES' ON SHEET S1.0.2.
- REFER TO SHEARWALL PLANS FOR SHEARWALL LOCATIONS, AND SHEARWALL SCHEDULE FOR REQUIREMENTS.
- REFER TO ARCHITECTURAL DRAWINGS TO CONFIRM LOCATION OF ACCESSIBLE UNITS.
- STEEL STAIRS AND LANDINGS BY STEEL SUPPLIER, PER NOTES ON SHEET S1.0.0.
- DRAWING DESIGNATION BELOW UNIT TYPE INDICATES UNIT FLOOR FRAMING PLAN. UNITS SHOWN ON STRUCTURAL PLANS OCCUR BELOW FLOOR INDICATED IN SHEET TITLE.

1 PARTIAL FLOOR FRAMING PLAN - BUILDING #3 - 347.13'
 SCALE: 1/8" = 1'-0"

Original Plans