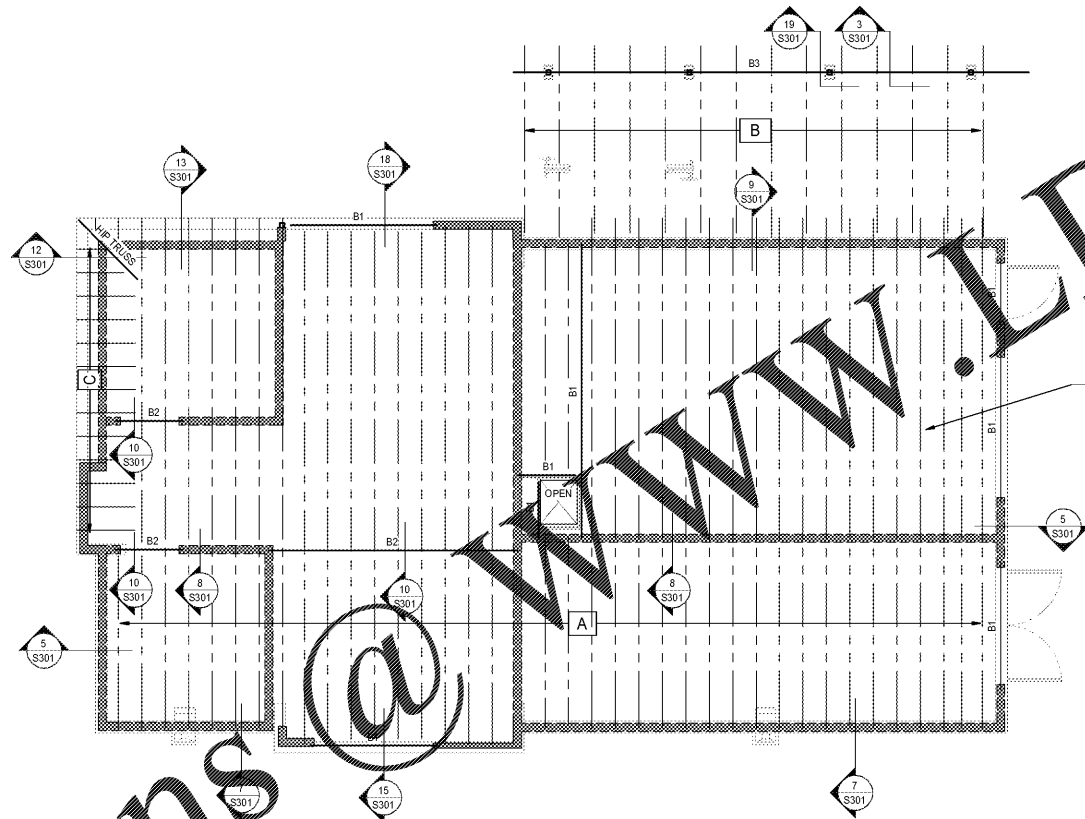


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ROOF FRAMING PLAN - UTILITY

SCALE: 1/4" = 1'-0"


- NOTES:
- 1) REFER TO THE T.P.1 "HB-91 SUMMARY SHEET COMMENTARY AND RECOMMENDATIONS FOR HANDLING, INSTALLING, & BRACING METAL PLATE CONNECTED WOOD TRUSSES;" INCLUDED IN THE DELIVERY PACKAGE.
 - 2) ALL BLOCKING AND BRACING TO BE JOB CUT AND FRAMED.
 - 3) ROOF SHEATHING REQUIRES 1 SIMPSON P.S.C. SHEATHING CLIP BETWEEN TRUSSES AT ALL UNSUPPORTED EDGES. SEE/S FOR ATTACHMENT.
 - 4) ROOF TRUSSES TO BE DESIGNED PER NOTES ON SHIT. S.
 - 5) SEE 16/S301 FOR HEADER SCHEDULE.
 - 6) SEE 17/S301 FOR TOP PLATE DETAIL.
 - 7) TRUSS BEARING ELEVATION = A.F.F.

BEAM SCHEDULE	
MARK #	MEMBER
B1	(2) -1-3/4"x11 7/8" LVL
B2	(3) -1-3/4"x11 7/8" LVL
B3	3 1/2"x11" GLULAM
B4	2x6 P.T.

WOOD FRAMING SCHEDULE		
MARK #	MEMBER	SPACING
A	11 7/8" TJI 110	16" O.C.
B	2x6	24" O.C.
C	1 3/4"x11 7/8" LVL	24" O.C.

EMS
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 1925 PROSPECT AVE.
 ORLANDO, FL 32814
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S112

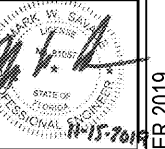


Revision Schedule	
No.	Description

PROJECT NO.	210072
DATE	2/19/11
DRAWN	EMC
CHECKED	EMC

PROJECT NAME: **ROCKLEDGE FLATS - BUILDING D**
 220 Barton Boulevard
 Rockledge, FL 32955

CLIENT NAME: **HUTTON DEVELOPMENT**

SHEET TITLE: **ROOF FRAMING PLAN - UTILITY BLDG.**

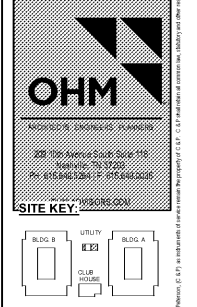

Chilcote & Peterson
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1925 Prospect Ave.
 Orlando, FL 32814
 P (407) 661-9100
 F (407) 661-9101
www.efp.com

GMP PRICING SET 15 NOVEMBER 2019