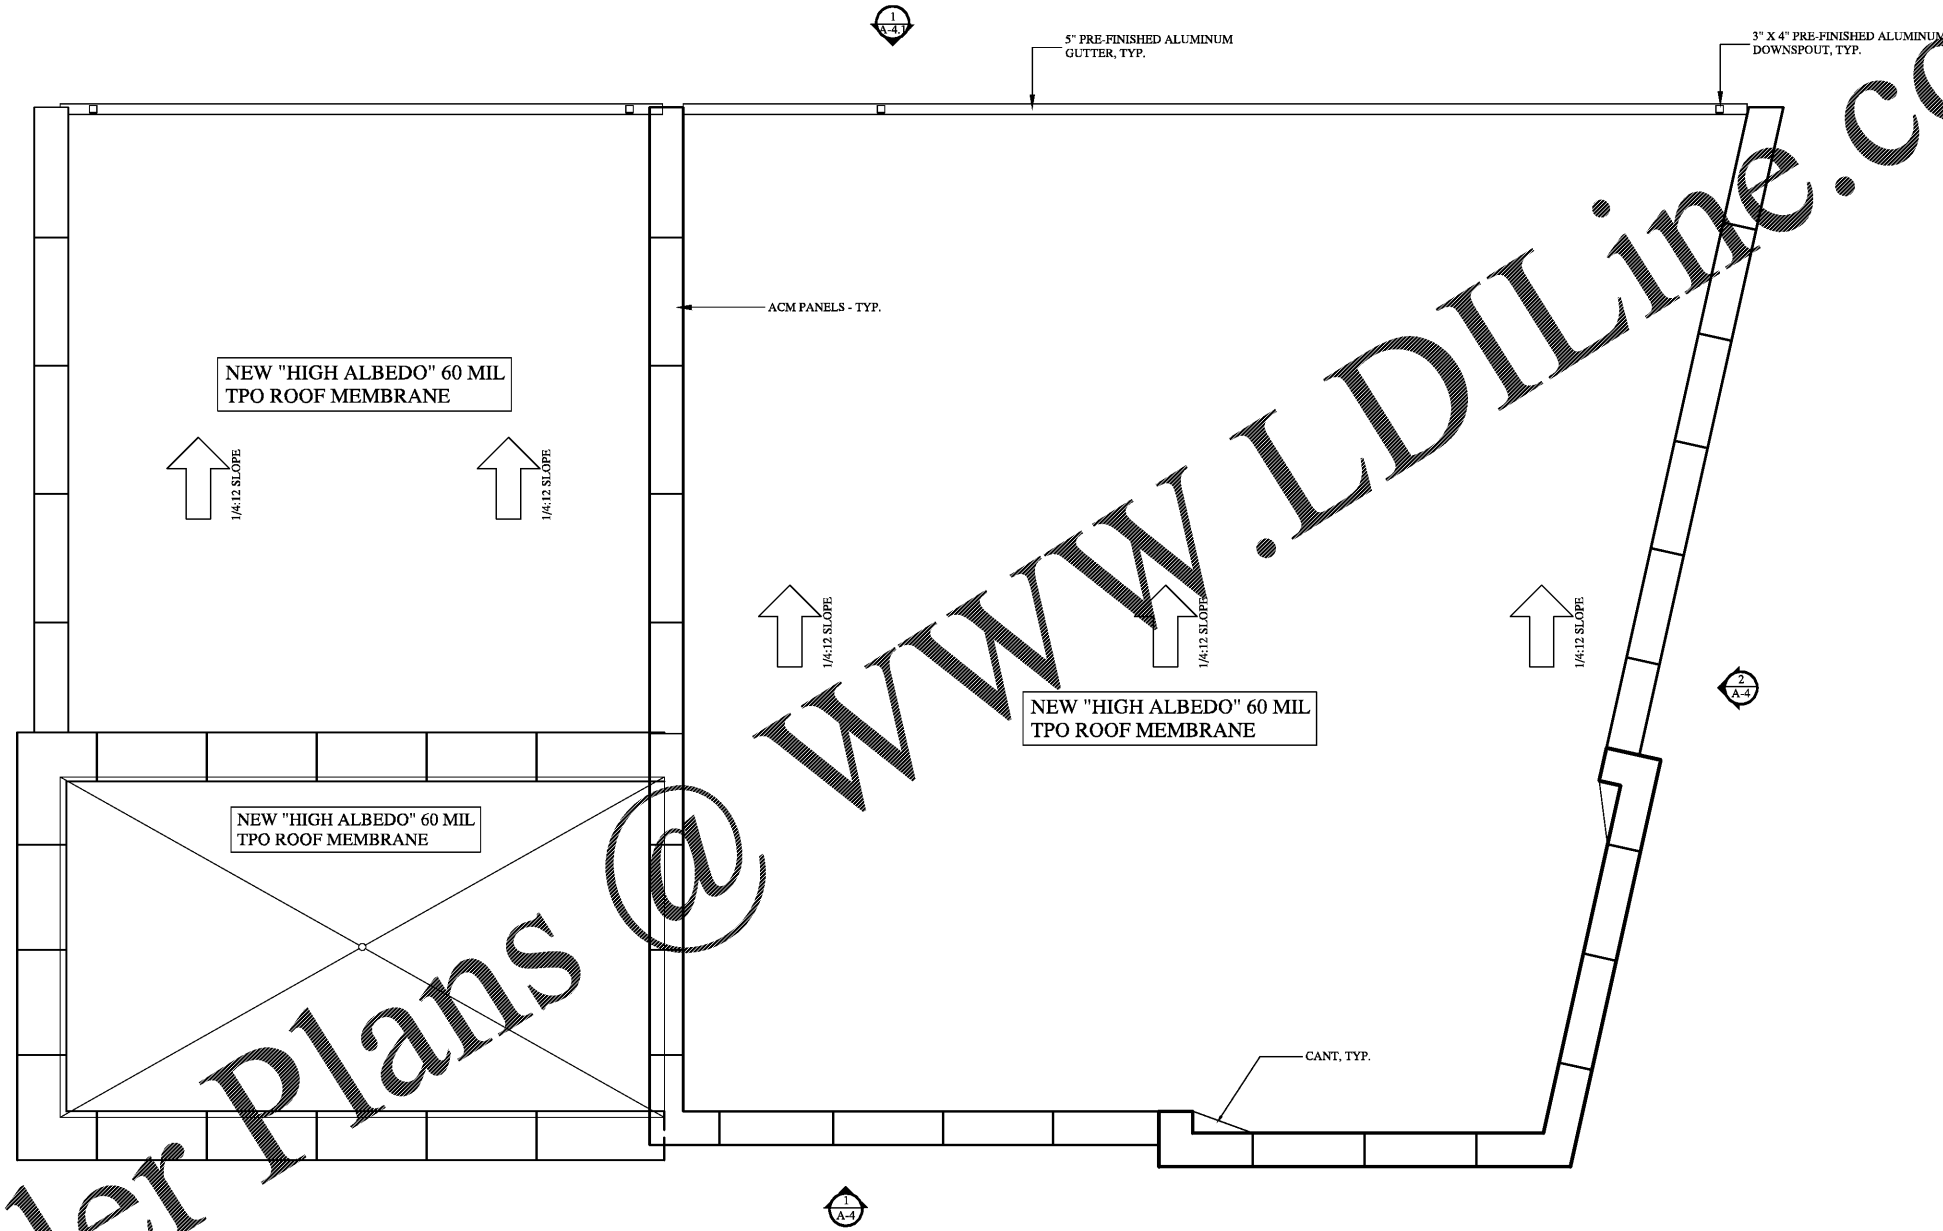


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1 ROOF PLAN
A-3 1/4" = 1'-0"

ROOF DRAINAGE SIZING DATA	
TOTAL PATIO AREA =	409 S.F.
4" HORIZONTAL STORM DRAINAGE PIPING CAPACITY PER NCPC 1106.3 =	2,650 S.F.
EACH DRAIN & ASSOCIATED PIPING COVERS 409 SF OF ROOF AREA	

ROOF DRAINAGE SIZING DATA	
TOTAL ROOF AREA = UPPER ROOF -	1,995 S.F.
LOWER ROOF -	742 S.F.
5" HORIZONTAL STORM DRAINAGE PIPING CAPACITY PER NCPC 1106.3 =	4,720 S.F.
3" X 4" RECTANGULAR VERTICAL CONDUCTOR CAPACITY PER 1106.2(2) =	3,300 S.F.

PRIEST ARCHITECTURE
 PRIEST ARCHITECTURE, PLLC
 1704 STATE ST. SUITE 1100 CHARLOTTE, NC 28205
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REGISTERED PROFESSIONAL ARCHITECT
 STATE OF NORTH CAROLINA
 NO. 35872

REVISIONS	
NO.	DATE

BH PECAN, LLC
 904 PECAN AVENUE
 CHARLOTTE, NORTH CAROLINA 28205

Project No: 1923
 Scale:
 Date Drawn:
 Sheet Title
ROOF PLAN

A-3