





NOTES:

- T.G.C. SHALL INSTALL A FIRE ALARM SYSTEM IN ACCORDANCE W/ THE APPLICABLE CODE. IF A FIRE ALARM MONITOR IS REQUIRED, THE MONITORING SERVICES SHALL BE PROVIDED BY T.G.C. AND ALL WORK PERFORMED BY TENANT'S F.A. CONTRACTOR, IF IT IS AN INDEPENDENT FIRE ALARM PANEL, MONITORING SHALL BE TENANT'S RESPONSIBILITY.
- A - SIGNAL BELLS - DOORBELL SIGNAL ON SALES FLOOR AND STOCK ROOM TO BE MOUNTED ON JOISTS, EDWARDS - #EDW130
- B - SIGNAL BELL PUSH BUTTON TO SIGNAL BELL NEAR STOREFRONT TRANSFORMER # P.B. 48' A.F.F., EDWARDS #EDW142.
- ALL WIRING BY T.G.C. UNLESS OTHERWISE NOTED.
- ALL OUTLET COVERS AND FACEPLATES SHOWN TO BE WHITE, EXCEPT TOE KICK AT LOZIER FIXTURES.
- REFER TO DRAWINGS A5.0 FOR LOCATION AND ELEVATION OF RECEPTACLES AND DATA/PHONE BOXES IN INFO CENTER AND OFFICE.
- BOTTOM OF SHOW HINDOCH CONVENIENCE OUTLETS TO BE ABOVE 12'-6" AFF. VERIFY HEIGHT AND EXACT LOCATION IN FIELD WITH FIVE BELOW PM. PROVIDE DISCONNECT PER N.E.C. 600.6. TYPICAL.
- HEIGHT OF POWER POLE AT CASHWRAP SHALL BE DETERMINED IN FIELD. T.G.C. TO PROVIDE CIRCUITS IN A JUNCTION BOX LOCATED IN CEILING, ABOVE POWER POLE LOCATION. ALL CIRCUITS TO BE CONNECTED TO THIS CASH AREA ARE TO RUN THROUGH THIS POWER POLE PROVIDED BY F.B. & INSTALLED BY T.G.C. COORDINATE WITH A3.1 AND FIXTURE INSTALLER.
- ALL SHOWN LIGHT AND DASHED IS EXISTING AND ALL SHOWN SOLID AND HEAVY IS NEW UNLESS NOTED OTHERWISE.
- HANGING SIGNS - UNISTRUT AND POWER. LOCATION - 24'-0" CONTINUOUS UNISTRUT TO BE MOUNTED AT 15'-0" A.F.F. AND SECURE TO THE STRUCTURE ABOVE. 7'-0" FROM STOREFRONT SOFFIT / FACE OF STOREFRONT WALL & 7'-0" FROM DEMISING WALL. UNISTRUT AND POWER BY T.G.C. COORDINATE WITH ARCHITECTURAL DWGS.
- PROVIDE ALTERNATE TO REUSE/RELOCATE EXISTING WATER HEATER (IF POSSIBLE).
- RELOCATE EXISTING PANELS & TRANSFORMER TO NEW LOCATION (LESS THAN 20' AWAY), REUSE CIRCUITS IF POSSIBLE, REWORK PANELS PER FIELD CONDITION.

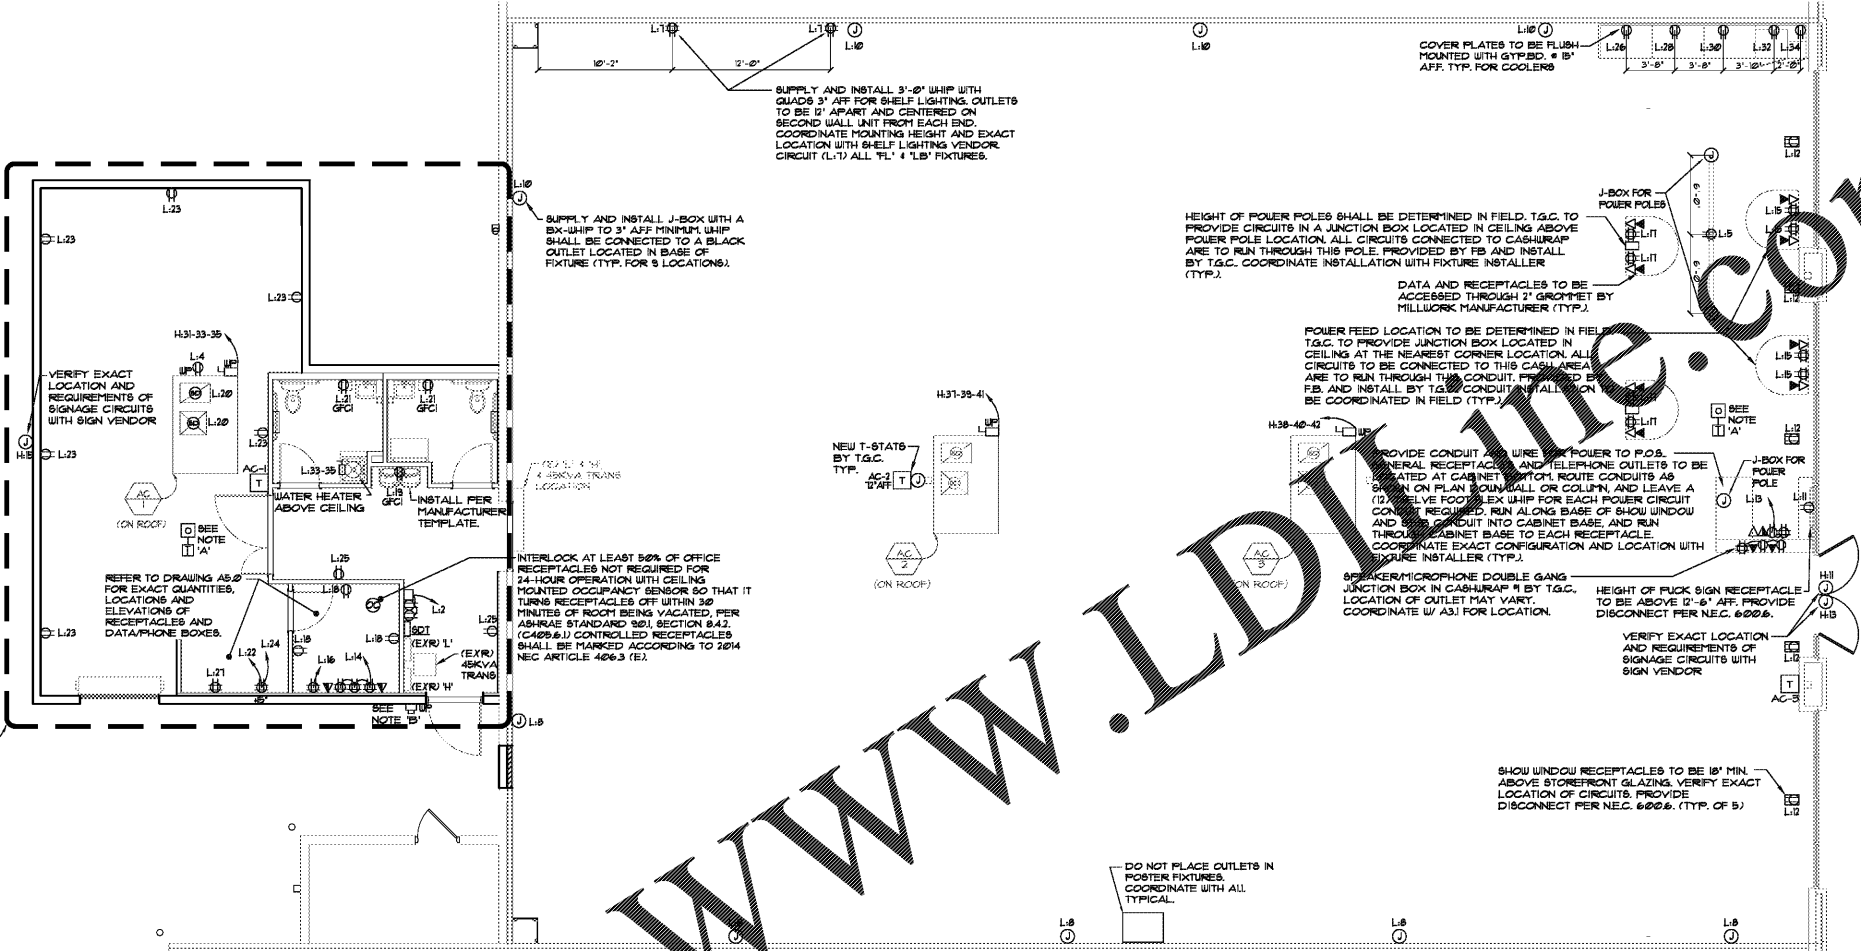

1 ELECTRICAL POWER PLAN

SCALE: 3/16" = 1'-0"

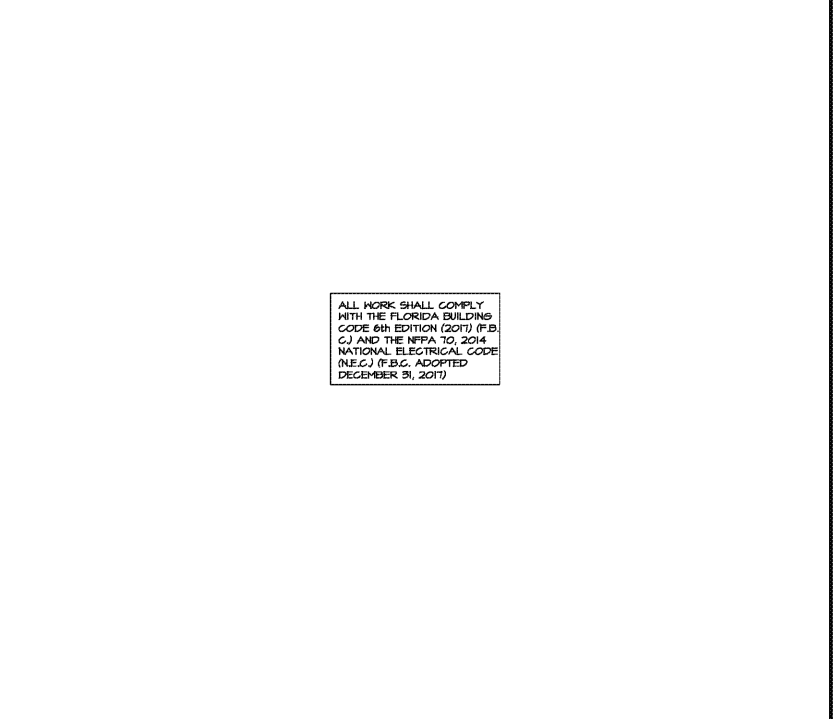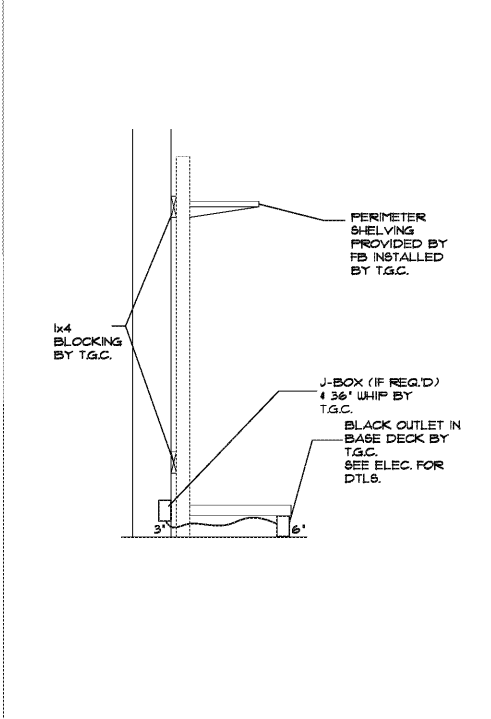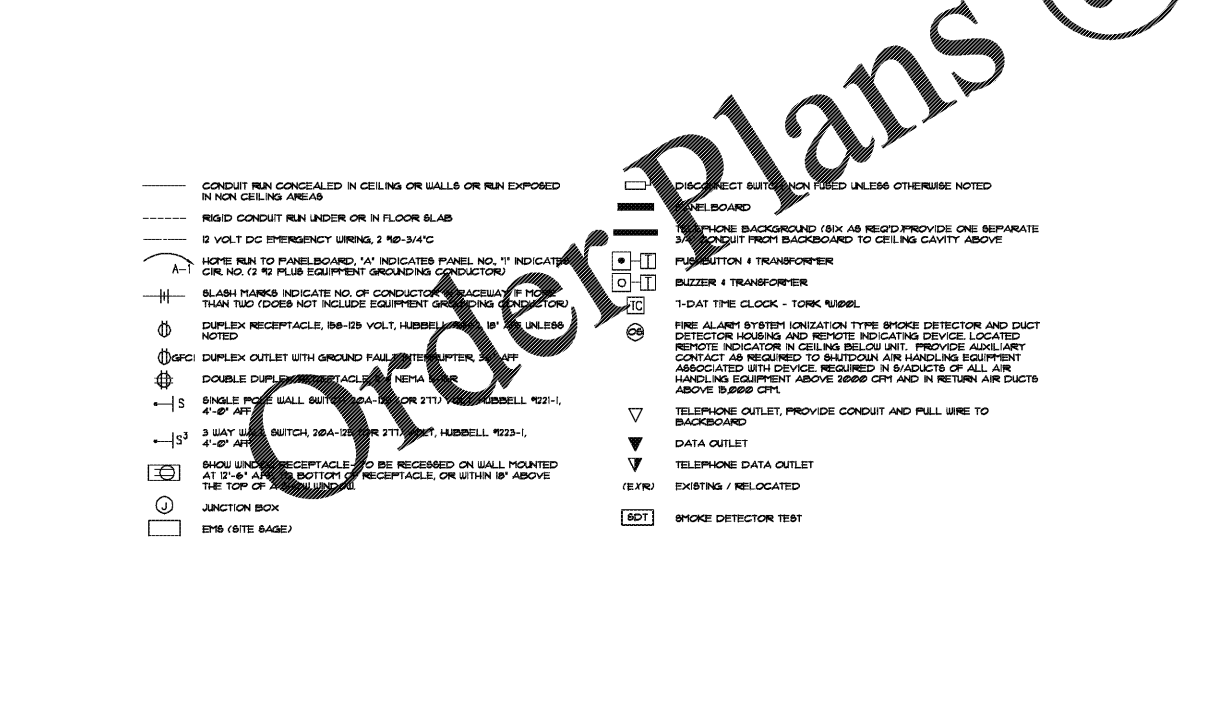

ENGINEER

ARCHITECTURAL SEAL

DATE ISSUE

DATE	REVISION	NAME

59/18/19 PERMIT / OWNER

PROJECT NAME / LOCATION

**FIVE BELOW**

NORTH LAKELAND  
919 LAKELAND PARK CENTER DRIVE  
LAKELAND, FL 32809

PROJECT INFORMATION

DATE: SEPTEMBER 18, 2019  
PROJECT NO.: 190636  
DELIVERY TYPE: AS-IS

DRAWN:  
CHECKED:

SHEET TITLE / NUMBER

POWER PLAN

**E1.0**

A LEGEND

B SEC. B PERIMETER SHELVING

C NOTE TO CONTRACTOR