


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Cumberland
 A R M S
 Store # 9747
 VSH # V1735
 Oracle # FL1735
 8090 US 1 AND MICCO RD
 MICCO, FL 32976
 JOB NUMBER: 41-17-00190

ISSUE BLOCK

CLIENT REVIEW	08/30/19
100%	09/27/19

CHECKED BY: GGB
 DRAWN BY: AHM

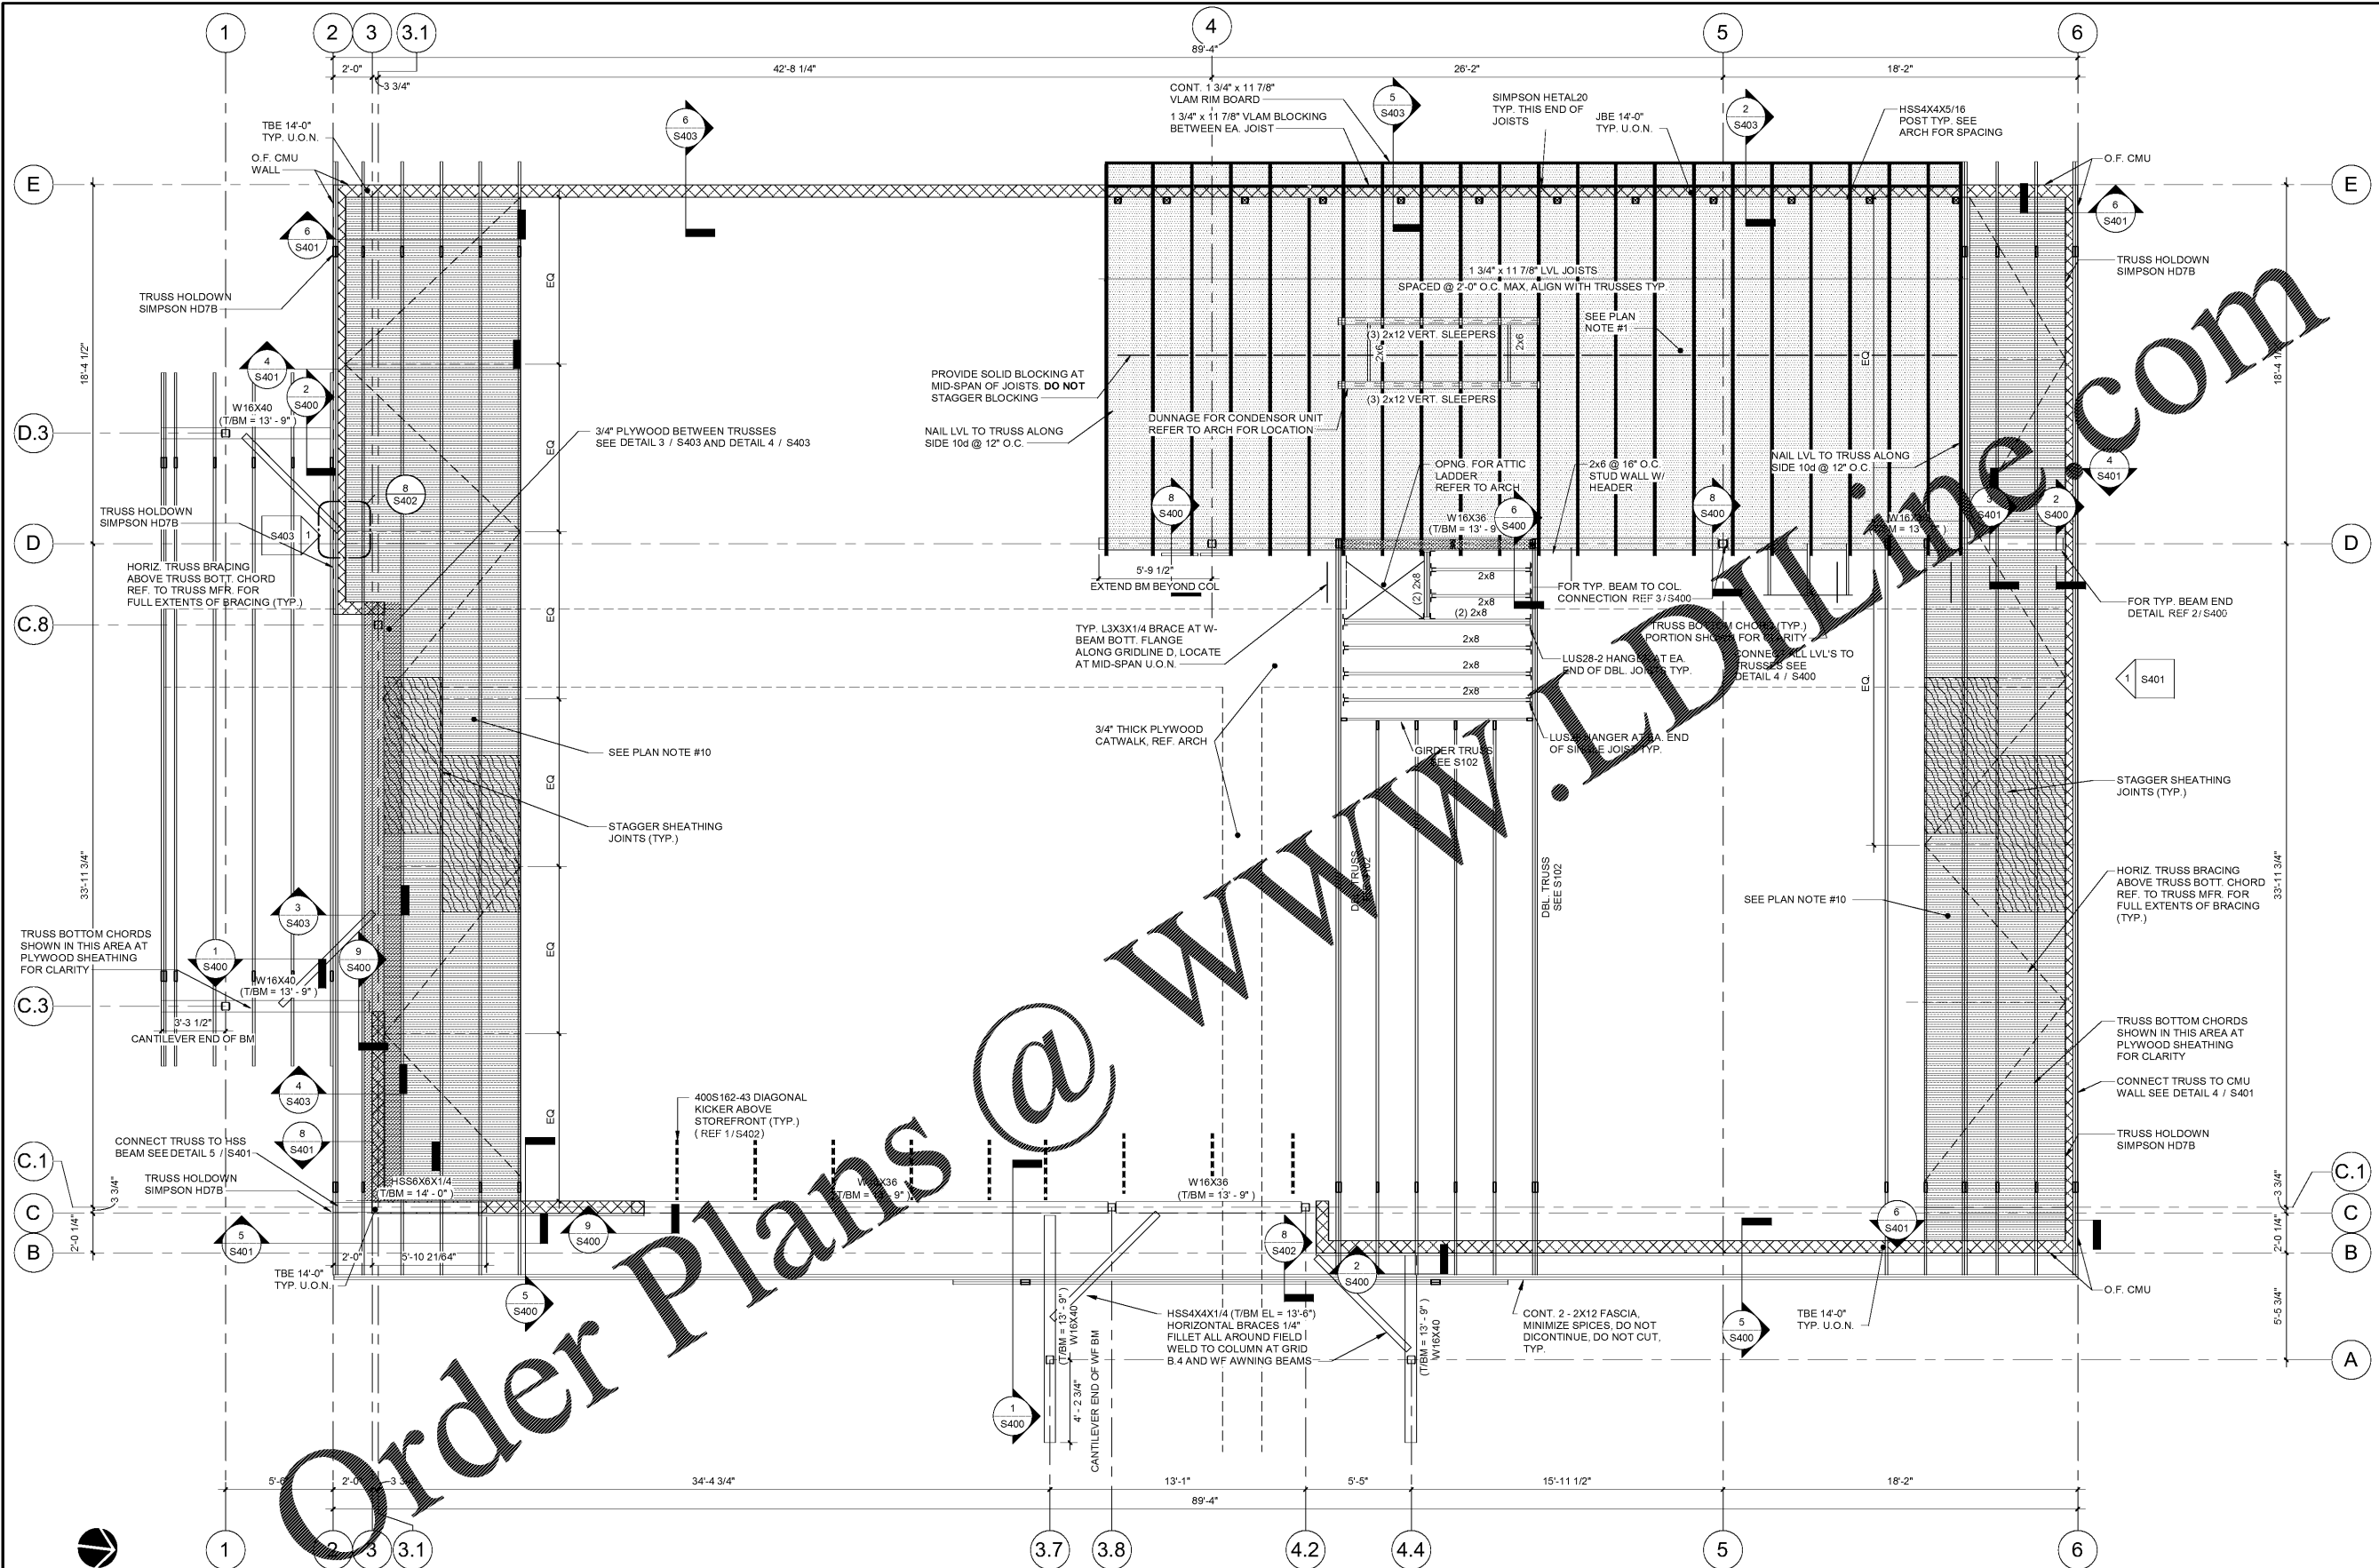

Order Plans @ www.dline.com

1 ROOF ACCESS AND REAR PLATFORM FRAMING PLAN
 1/4" = 1'-0"
LEGEND:

JBE	DENOTES JOIST BEARING ELEVATION	[Hatched Box]	DENOTES LIMITS OF PLATFORM ROOF SHEATHING (SEE PLAN NOTES)	[Dashed Line]	DENOTES SIMPSON STRONG-TIE CONTINUITY STRAP CONNECTOR (SEE PLAN FOR TYPE & LOCATIONS)
[Hatched Box]	DENOTES STUD WALL	[Dotted Box]	DENOTES LIMITS OF PLYWOOD SHEATHING AT TRUSS BOTTOM CHORD	[Solid Line]	H1 DENOTES HEADER MARK
TBE	DENOTES TRUSS BEARING ELEVATION				
O.F.	DENOTES OUTSIDE FACE				

- PLAN NOTES:**
1. PLATFORM ROOF SHEATHING: SEE PLYWOOD SHEATHING REQUIREMENTS ON S002
 2. SEE DWGS. S001 & S002 GENERAL NOTES
 3. PLATFORM JOIST BEARING ELEVATION VARIES. SEE PLAN.
 4. ALL PLATFORM JOISTS ARE SPACED @ 24" o.c. MAXIMUM. FIELD ADJUST AS REQUIRED.
 5. SEE FOUNDATION PLAN & ARCH. DWGS. FOR DIMENSIONS NOT SHOWN.
 6. ALL EXTERIOR STUD WALLS SHALL BE SHEATHED FULL HEIGHT. SEE PLYWOOD SHEATHING REQUIREMENTS ON SHEET S002 FOR ATTACHMENT REQUIREMENTS.
 7. REF. MECH. & ARCH. DWGS. FOR EXACT LOCATIONS OF MECHANICAL UNITS ON REAR PLATFORM AND AT ROOF TRUSSES.
 8. 4824 SHEATHING MIN. 1/2" THICK PANELS ORIENTED W/ LONG DIMENSION PERPENDICULAR TO SUPPORTING JOISTS/TRUSSES BLOCKED AT PANEL EDGES. NAIL SPACING: 6" AT EDGES, 12" FIELD.
 9. ALL LAMINATED VENEER LUMBER (LVL) BEAMS SHALL BE 2.0E VERSALAM LVL AS MANUFACTURED BY BOISE CASCADE.
 10. HORIZONTAL PLYWOOD DIAPHRAGM UNDER TRUSS BOTT. CHORD. SEE PLYWOOD SHEATHING REQUIREMENTS ON S002.

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 2019 HFCP - ROOF ACCESS AND REAR PLATFORM FRAMING PLAN