


FOUNDATION LEGEND	
FOOTING OR FOUNDATION	
1ST LEVEL WALLS	
LOW WALLS	
COLUMN	

BASE PLATE SCHEDULE	
BP10	200X107 A36 STEEL PLATE, W/ (4) #9 ANCHOR BOLTS, 2" EMBEDDED INTO CONC. W/ SIMPSON SET-NIP
BP100	200X107 A36 STEEL PLATE, W/ (4) #9 ANCHOR BOLTS, 2" EMBEDDED INTO CONC. W/ SIMPSON SET-NIP
BP1414	200X107 A36 STEEL PLATE, W/ (4) #9 ANCHOR BOLTS, 2" EMBEDDED INTO CONC. W/ SIMPSON SET-NIP

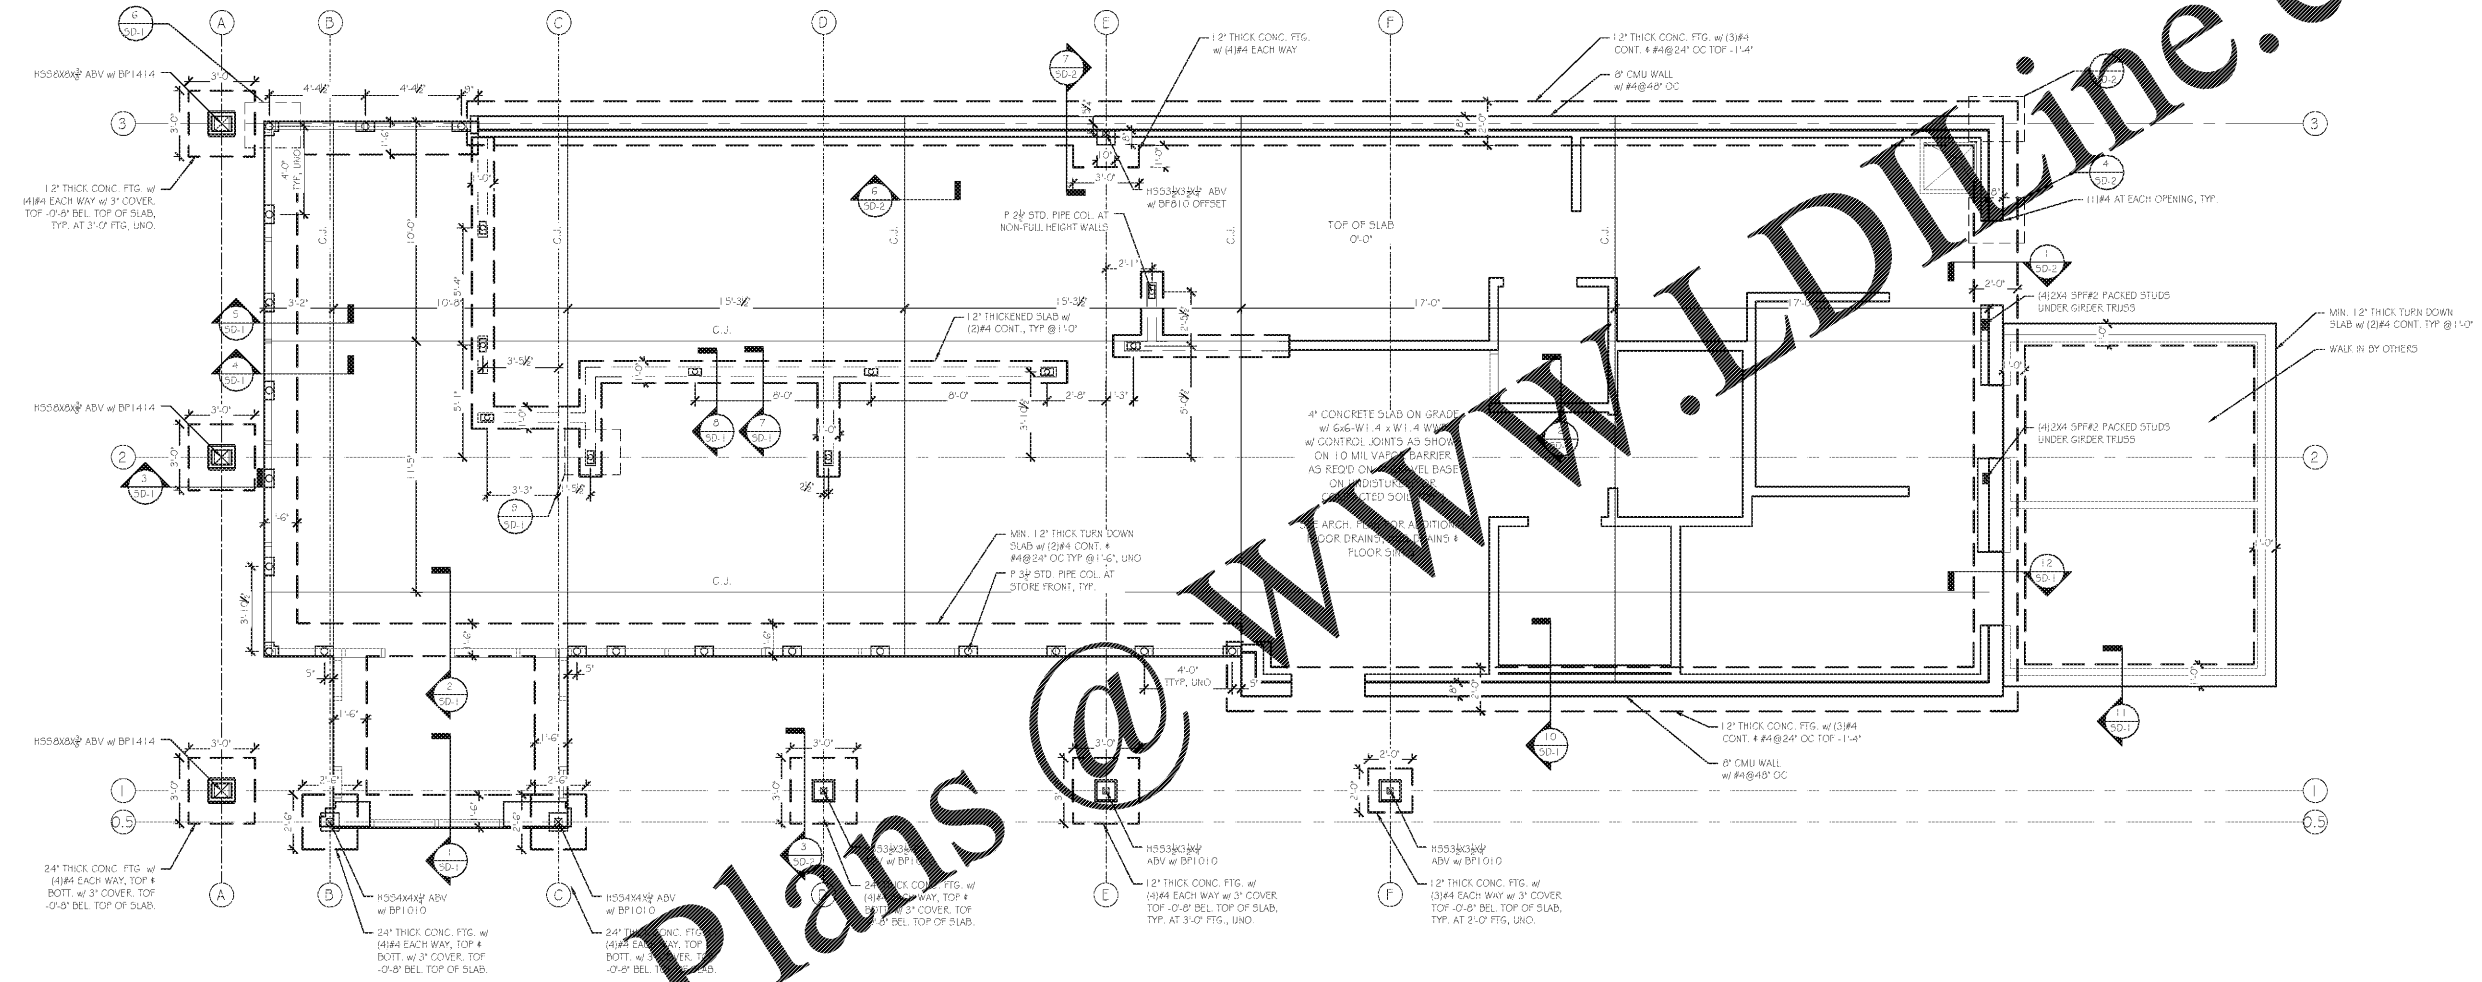

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KOBLASZ & KENNISON
ENGINEERING, P.C.
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 404 | 860 | 2600

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HUDDLE HOUSE
 EVO 2000 RESTAURANT
 US HWY 78 JASPER, AL
 WALKER CO. 35501

SUBMITTALS:	
DATE	DESCRIPTION
07-13-2019	STRUCTURAL DESIGN ISSUED

SHEET TITLE:
FOUNDATION PLAN

JOB NUMBER: 19102
 ENGINEER: LHK
 CHECKED BY: LHK



SHEET NUMBER:
S-1

- FOUNDATION NOTES:
- FOUNDATION DESIGNED BASED ON 2500 PSF ALLOWABLE SOIL BEARING CAPACITY PER GEOTECHNICAL REPORT.
 - SOLE/SILL PLATES TO BE ANCHORED TO THE FOUNDATION WITH #9 ANCHOR BOLTS @ A MAXIMUM OF 4'-0" OC. UNO. MINIMUM (2) BOLTS PER PLATE SECTION AND (1) BOLT WITHIN 12" FROM END OF PLATE SECTION. MINIMUM 6" EMBEDMENT INTO MASONRY OR CONCRETE.
 - SEE SHEET S-0 FOR ADDITIONAL NOTES.
 - ALL DIMENSIONS LABELED ON PLAN ARE TO BE CONFIRMED BY ARCHITECT PRIOR TO CONSTRUCTION.
- RELEASED FOR CONSTRUCTION

1 FOUNDATION PLAN
 S-1 SCALE: 1/4" = 1'-0"