
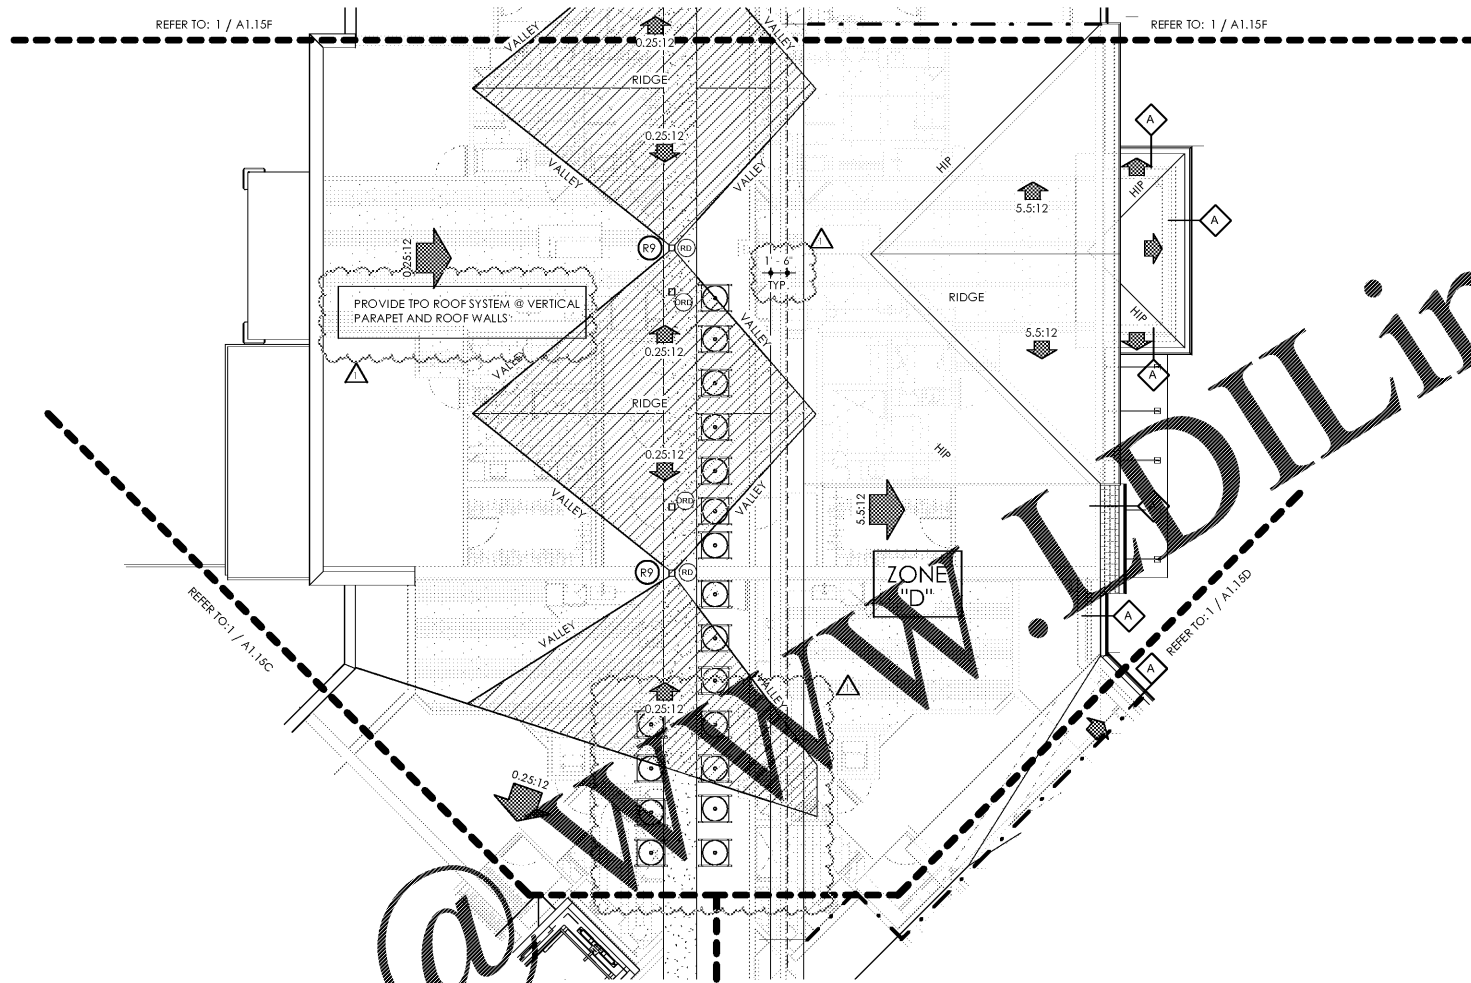


7/3/19

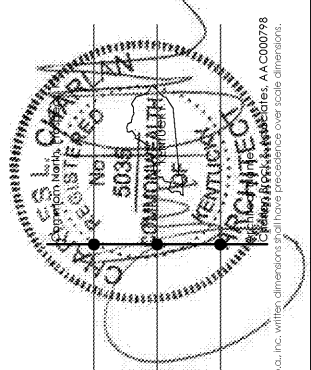

1 PARTIAL BUILDING PLAN G - (05) ROOF PLAN

SCALE: 1/8" = 1'-0"

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PARTIAL BUILDING PLAN G - ROOF PLAN

date: 06/04/2019
job no: 3789.15
drawn by: EGR JAC, TQT
reviewed by: CBA
issue history:
Δ Date 1/07/03/19

A1.15G

ROOF TRUSS LEGEND				ATTIC VENTILATION CALCULATIONS						ROOF LEGEND		ROOF PLAN GENERAL NOTES	ROOF KEYNOTES		KEY PLAN
TRUSS TYPE	HEEL HEIGHT	BRG. HEIGHT	OVERHANG	ZONES	AREA SQ.FT.	PERIMETER LIN.FT.	REQ. VENT. SQ.FT. HIGH	REQ. VENT. SQ.FT. LOW	PROVIDED VENT. SQ.FT. HIGH	PROVIDED VENT. SQ.FT. LOW	INDICATES ASPHALT SHEATHING ROOF	1. ALL ROOF PITCHES ARE 5:12 UNLESS NOTED OTHERWISE.	R1	DENOTES OFF RIDGE VENT	
A	1'-8 1/4"	32'-6 3/4"	1'	D	12,668	882	21.11	21.11	15	21.90	70.56	INDICATES TPO ROOF SYSTEM W/ 1/2" PER 1'-0" SLOPPING	R2	HVAC CONDENSER RACK - ROUTE HVAC COMPRESSOR DRAIN PIPES PER MEP DRAWINGS	
B	1'-2 3/4"	32'-6 3/4"	0'									INDICATES 4'-0" MIN. WIDE FIRE RETARDANT SHEATHING AT PERIMETER FOR 2 HR BUILDING SEPARATION WALL - NO ROOF PENETRATIONS PERMITTED AT THIS LOCATION	R3	DENOTES 4'-0" MIN. WIDE FIRE RETARDANT PLYWOOD ON BOTH SIDES OF 2-HOUR BUILDING SEPARATION WALL, NO ROOF PENETRATIONS AT THIS LOCATION	
C	1'-9"	32'-6 3/4"	2'-6"									INDICATES ANTICIPATED EQUIPMENT ROOF LOCATIONS	R4	PROVIDE 1/4" PER FOOT MIN. SLOPE AWAY FROM ALL WALLS, TYPICAL.	
D	2'-7 1/4"	42'-6 3/4"	1'-6"									INDICATES ACCESS UNDER ROOF - TRUSS ENGINEER TO PROVIDE REINFORCED BOTTOM AND CLEAR PATH THRU TRUSSES	R5	DENOTES 6" GUTTER LOCATION	
E	2'-11 1/4"	42'-6 3/4"	2'-3"										R6	DENOTES DOWNSPOUT LOCATION	
F	2'-7 1/2"	42'-6 3/4"	1'-4"										R7	SCUPPER	
G	2'-7 7/8"	42'-6 3/4"	1'-9"										R8	DENOTES 30"X48" ATTIC ACCESS	
H	2'-7 7/8"	42'-6 3/4"	1'-10"										R9	DENOTES PRIMARY ROOF DRAIN	
I	2'-2 3/8"	42'-6 3/4"	0'-10"										R10	DENOTES OVERFLOW ROOF DRAIN MOUNTED 2' ABOVE PRIMARY ROOF DRAIN	
J	2'-9 1/2"	42'-6 3/4"	1'-11"										R11	ROOFTOP EQUIPMENT STAND CAPABLE TO SUPPORT 2,000 POUNDS REFER TO MEP. SEE DETAIL 3/A7.52	
K	2'-7"	42'-6 3/4"	1'-8"												
L	3'-1 3/8"	42'-6 3/4"	2'-10"												
M	2'-10 3/4"	42'-6 3/4"	2'-4"												
N	2'-4 1/2"	42'-6 3/4"	1'-2"												

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