


Date:	06/04/19
Drawn by:	PC
Reviewed by:	RC/JW
Job Number:	21889.1
Revision:	Date:

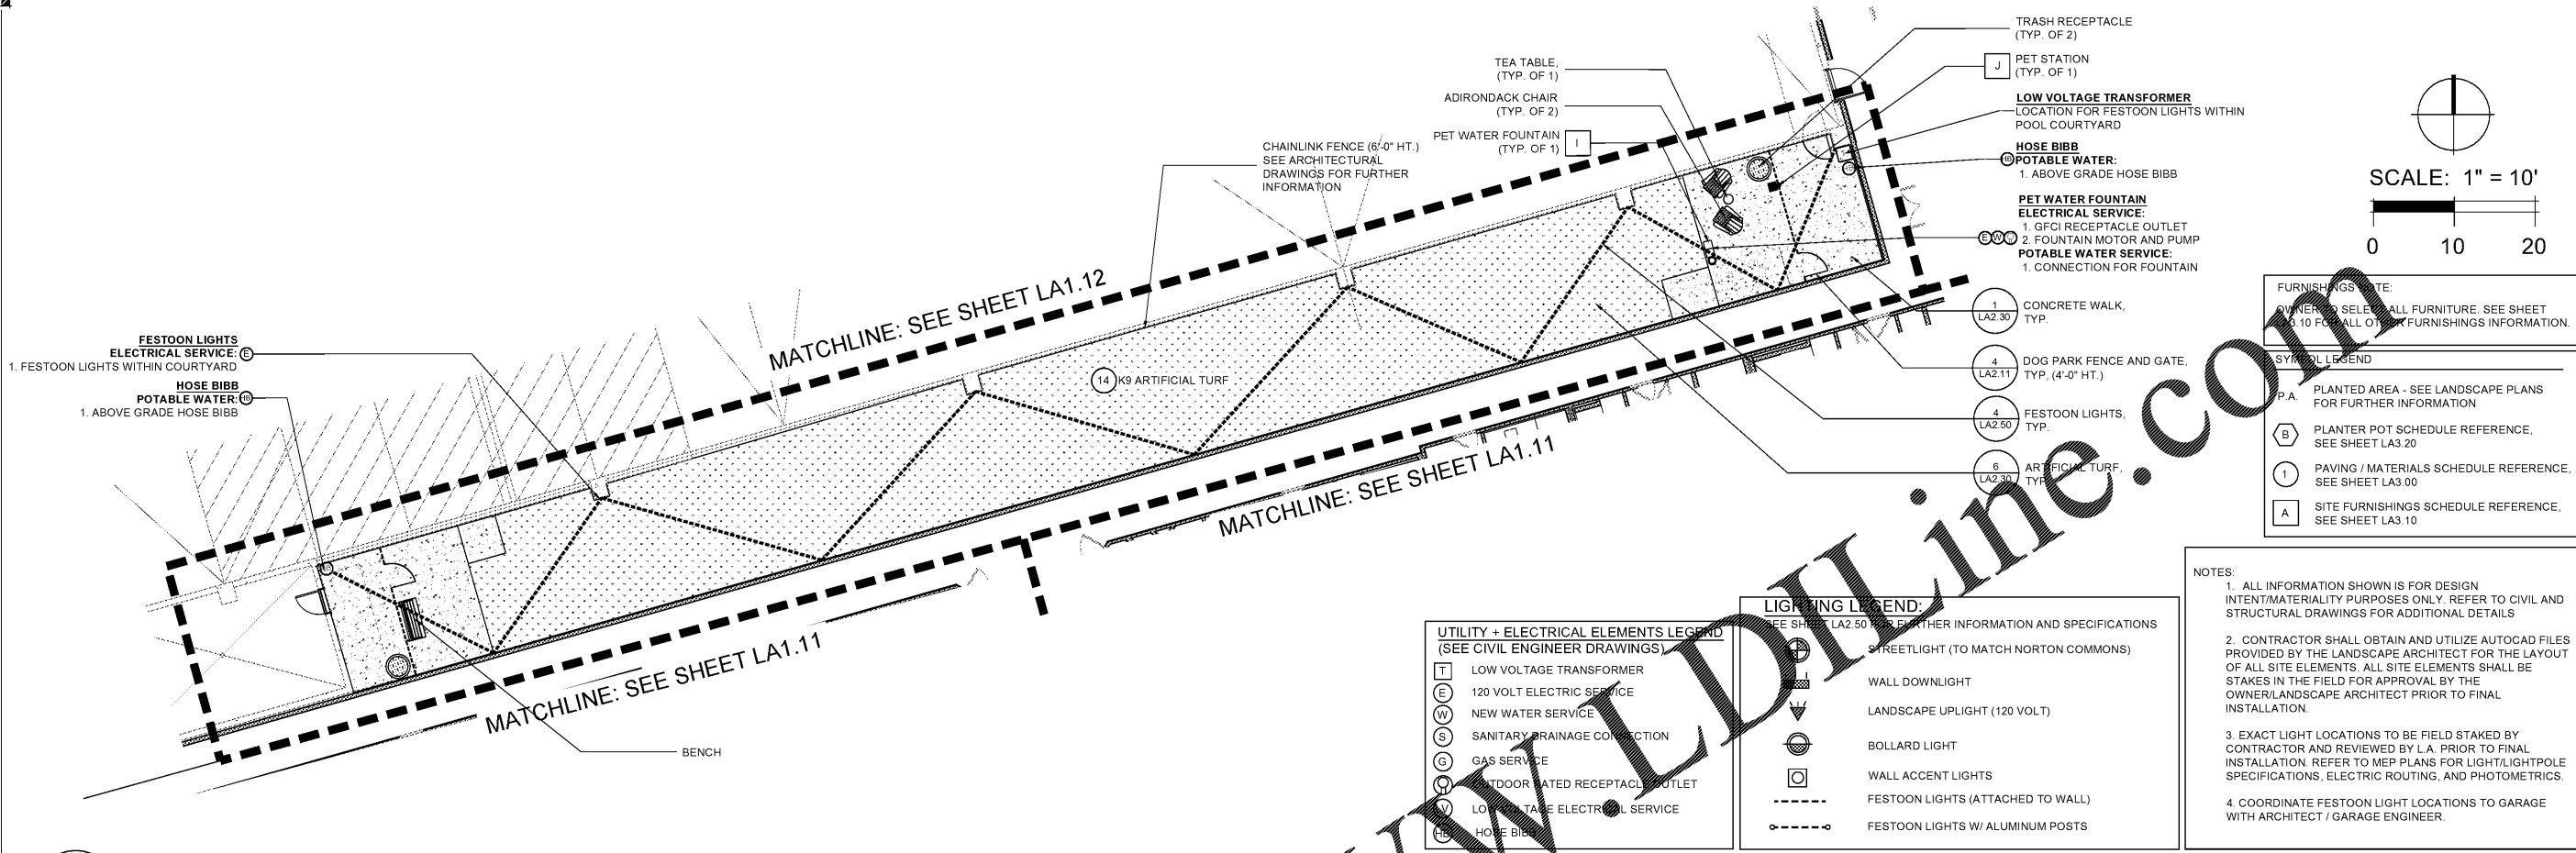

**FURNISHINGS NOTE:**  
OWNER TO SELECT ALL FURNITURE. SEE SHEET LA2.10 FOR ALL OTHER FURNISHINGS INFORMATION.

**SYMBOL LEGEND:**

- P.A. PLANTED AREA - SEE LANDSCAPE PLANS FOR FURTHER INFORMATION
- B PLANTER POT SCHEDULE REFERENCE. SEE SHEET LA3.20
- 1 PAVING / MATERIALS SCHEDULE REFERENCE. SEE SHEET LA3.00
- A SITE FURNISHINGS SCHEDULE REFERENCE. SEE SHEET LA3.10

**UTILITY + ELECTRICAL ELEMENTS LEGEND (SEE CIVIL ENGINEER DRAWINGS)**

- T LOW VOLTAGE TRANSFORMER
- E 120 VOLT ELECTRIC SERVICE
- W NEW WATER SERVICE
- S SANITARY DRAINAGE CONNECTION
- G GAS SERVICE
- Q OUTDOOR RATED RECEPTACLE OUTLET
- V LOW VOLTAGE ELECTRICAL SERVICE
- HL HOSE BIBB

**LIGHTING LEGEND:**  
(SEE SHEET LA2.50 FOR FURTHER INFORMATION AND SPECIFICATIONS)

- STREETLIGHT (TO MATCH NORTON COMMONS)
- WALL DOWNLIGHT
- LANDSCAPE UPLIGHT (120 VOLT)
- BOLLARD LIGHT
- WALL ACCENT LIGHTS
- FESTOON LIGHTS (ATTACHED TO WALL)
- FESTOON LIGHTS W/ ALUMINUM POSTS

**NOTES:**


- ALL INFORMATION SHOWN IS FOR DESIGN INTENT/MATERIALITY PURPOSES ONLY. REFER TO CIVIL AND STRUCTURAL DRAWINGS FOR ADDITIONAL DETAILS
- CONTRACTOR SHALL OBTAIN AND UTILIZE AUTOCAD FILES PROVIDED BY THE LANDSCAPE ARCHITECT FOR THE LAYOUT OF ALL SITE ELEMENTS. ALL SITE ELEMENTS SHALL BE STAKES IN THE FIELD FOR APPROVAL BY THE OWNER/LANDSCAPE ARCHITECT PRIOR TO FINAL INSTALLATION.
- EXACT LIGHT LOCATIONS TO BE FIELD STAKED BY CONTRACTOR AND REVIEWED BY L.A. PRIOR TO FINAL INSTALLATION. REFER TO MEP PLANS FOR LIGHT/LIGHTPOLE SPECIFICATIONS, ELECTRIC ROUTING, AND PHOTOMETRICS.
- COORDINATE FESTOON LIGHT LOCATIONS TO GARAGE WITH ARCHITECT / GARAGE ENGINEER.

01  
LA1.50 DOG PARK HARDSCAPE, FURNISHINGS, SITE LIGHTING AND UTILITY NEEDS ENLARGEMENT PLAN  
SCALE: 1"=10'-0"

**LYRIC AT NORTON COMMONS**  
Prospect, Kentucky

**Bristol Development Group**  
380 Mallory Station Rd., #504, Franklin, TN 37064

**DIX.HITE**  
+ PARTNERS  
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LONGWOOD, FLORIDA 32750  
TEL 407.667.1777

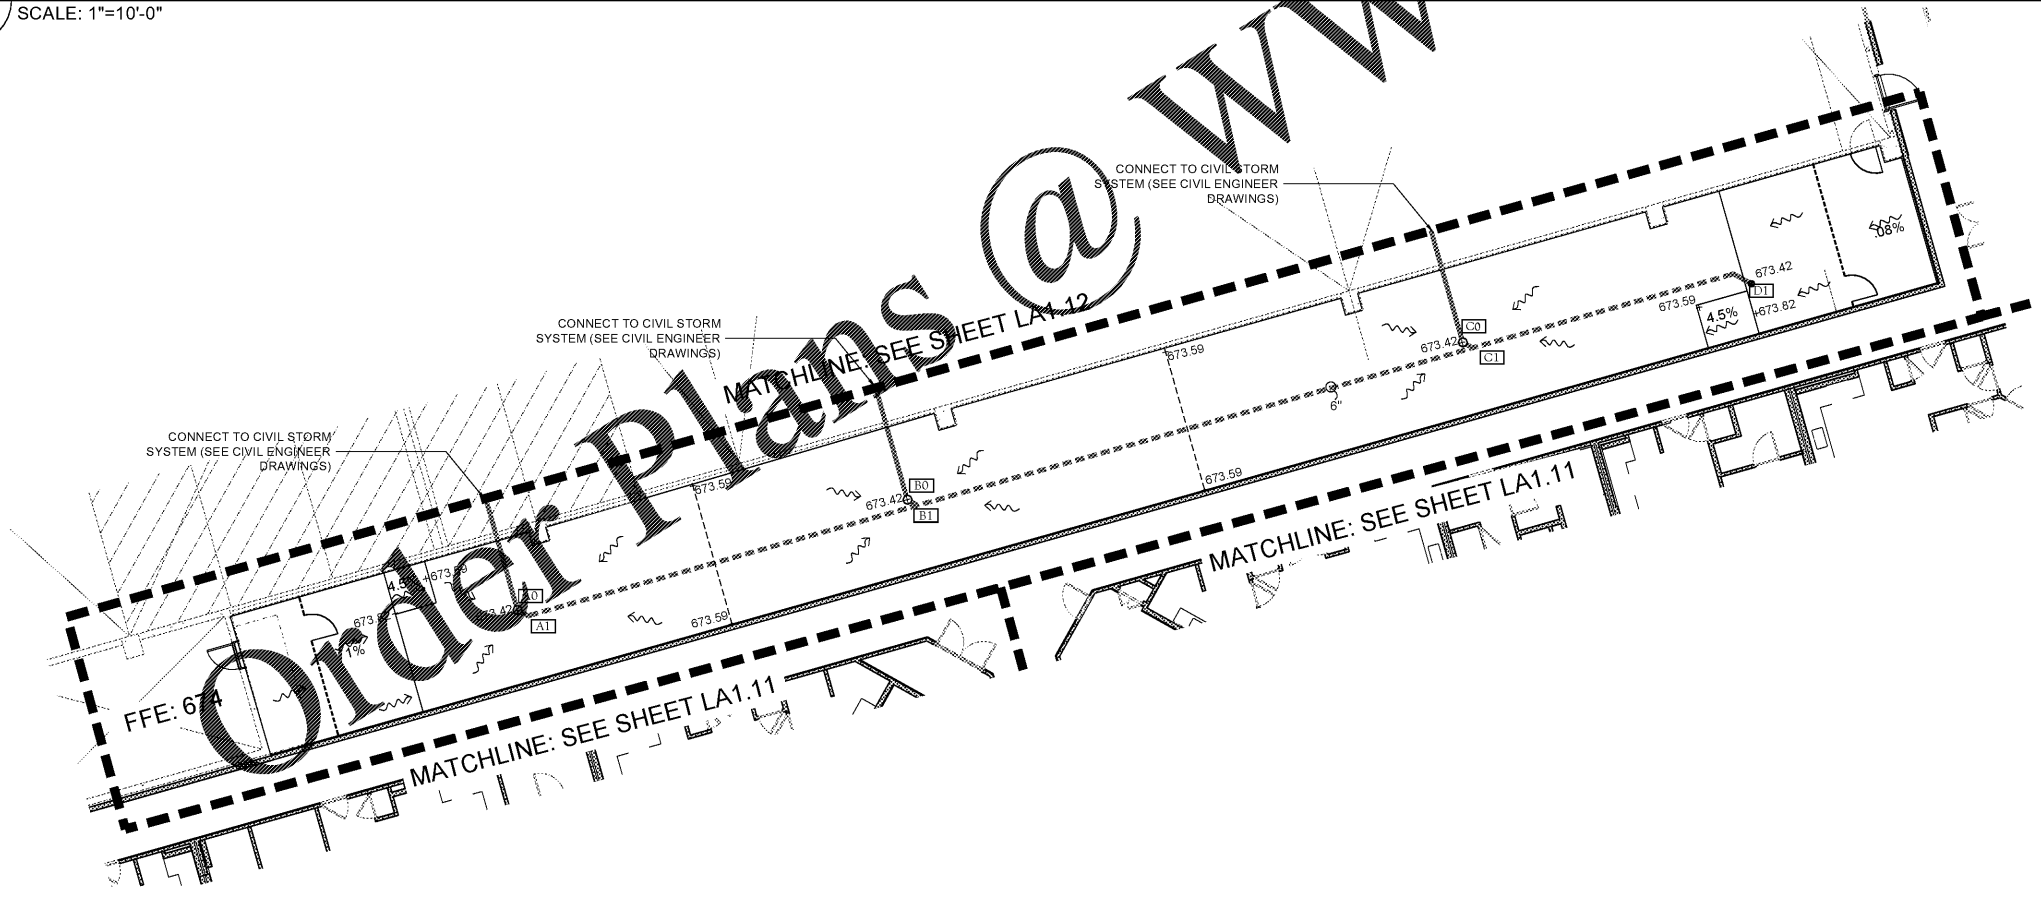

DRAIN NUMBER	SURFACE ELEVATION	INVERT ELEVATION	DRAIN TYPE
A00	-	-	CONNECT TO CIVIL DRAIN SYSTEM
A01	673.42	671.67	6" SOCK PIPE CONNECTION
B00	-	-	CONNECT TO CIVIL DRAIN SYSTEM
B01	673.42	671.67	6" SOCK PIPE CONNECTION
C00	-	-	CONNECT TO CIVIL DRAIN SYSTEM
C01	673.42	671.67	6" SOCK PIPE CONNECTION
D01	673.42	671.67	6" ATRIUM GRATE (DOG FOUNTAIN)

**GRADING AND DRAINAGE LEGEND:**

- WAVE LINE: SURFACE FLOW DIRECTION
- SQUARE: 9" BRASS DECK DRAIN
- CIRCLE: 6" ATRIUM GRATE
- DOT: 12" YARD DRAIN
- SOLID LINE: SOLID PVC DRAIN PIPE (SEE PLAN FOR SIZES)
- PIPE SIZE: PIPE SIZE
- 77.92: SPOT ELEVATION
- 1.0%: FLOW DIRECTION OF PIPE AND GRADIENT
- BT: DRAIN IDENTIFICATION SYMBOL
- CHANNEL DRAIN: CHANNEL DRAIN
- PERFORATED LINE: 6" PERFORATED DRAIN PIPE
- 77.92: SPOT ELEVATION PER CIVIL PLANS

**GRADING AND DRAINAGE NOTES:**

- + DRAINAGE SHALL OUTFALL TO CIVIL STUB OUT.
- + ALL DRAINAGE SYSTEM COMPONENTS SHALL BE NDS OR APPROVED EQUAL.
- + CONTRACTOR TO ENSURE POSITIVE DRAINAGE IN ALL AREAS. NO STANDING WATER.
- + INSTALL DRAINAGE EQUIPMENT PER MANUFACTURER'S DETAILS AND STANDARDS.

02  
LA1.50 DOG PARK GRADING AND DRAINAGE PLAN  
SCALE: 1"=10'-0"

**90% HARDSCAPE PLANS**

**DOG PARK HARDSCAPE PLAN**

