


Partial Roof Framing Plan
SCALE: 1/8" = 1'-0"

- NOTES:
1. TOP OF STEEL BEAM TO BE 4" BELOW BOTTOM OF WOOD FRAMING.
 2. BOTTOM OF STEEL BEAM TO BE OVERRUN DISTANCE ABOVE LEVEL.
 3. VERIFY REQUIRED ELEVATOR OVERRUN WITH MANUFACTURER.
 4. ROOF CONSTRUCTION 3/4" PLYWOOD
 5. MAXIMUM JOIST SPACING 1'-4" U.N.O.


Schedule - Headers		
MARK	TYPE	COMMENTS
H1	Microlam® LVL 2.0E - 9' 1/4"	
H2	Microlam® LVL 2.0E - 14'	
H3	(3) Microlam® LVL 2.0E - 9' 1/4"	
H4	(3) Microlam® LVL 2.0E - 16'	
H5	(3) 2x10 w/ (2) 1/2" PLY	
H6	(3) 2x12 w/ (2) 1/2" PLY	
H7	(4) Microlam® LVL 2.0E - 9' 1/4"	(3) JACK STUDS, EACH END

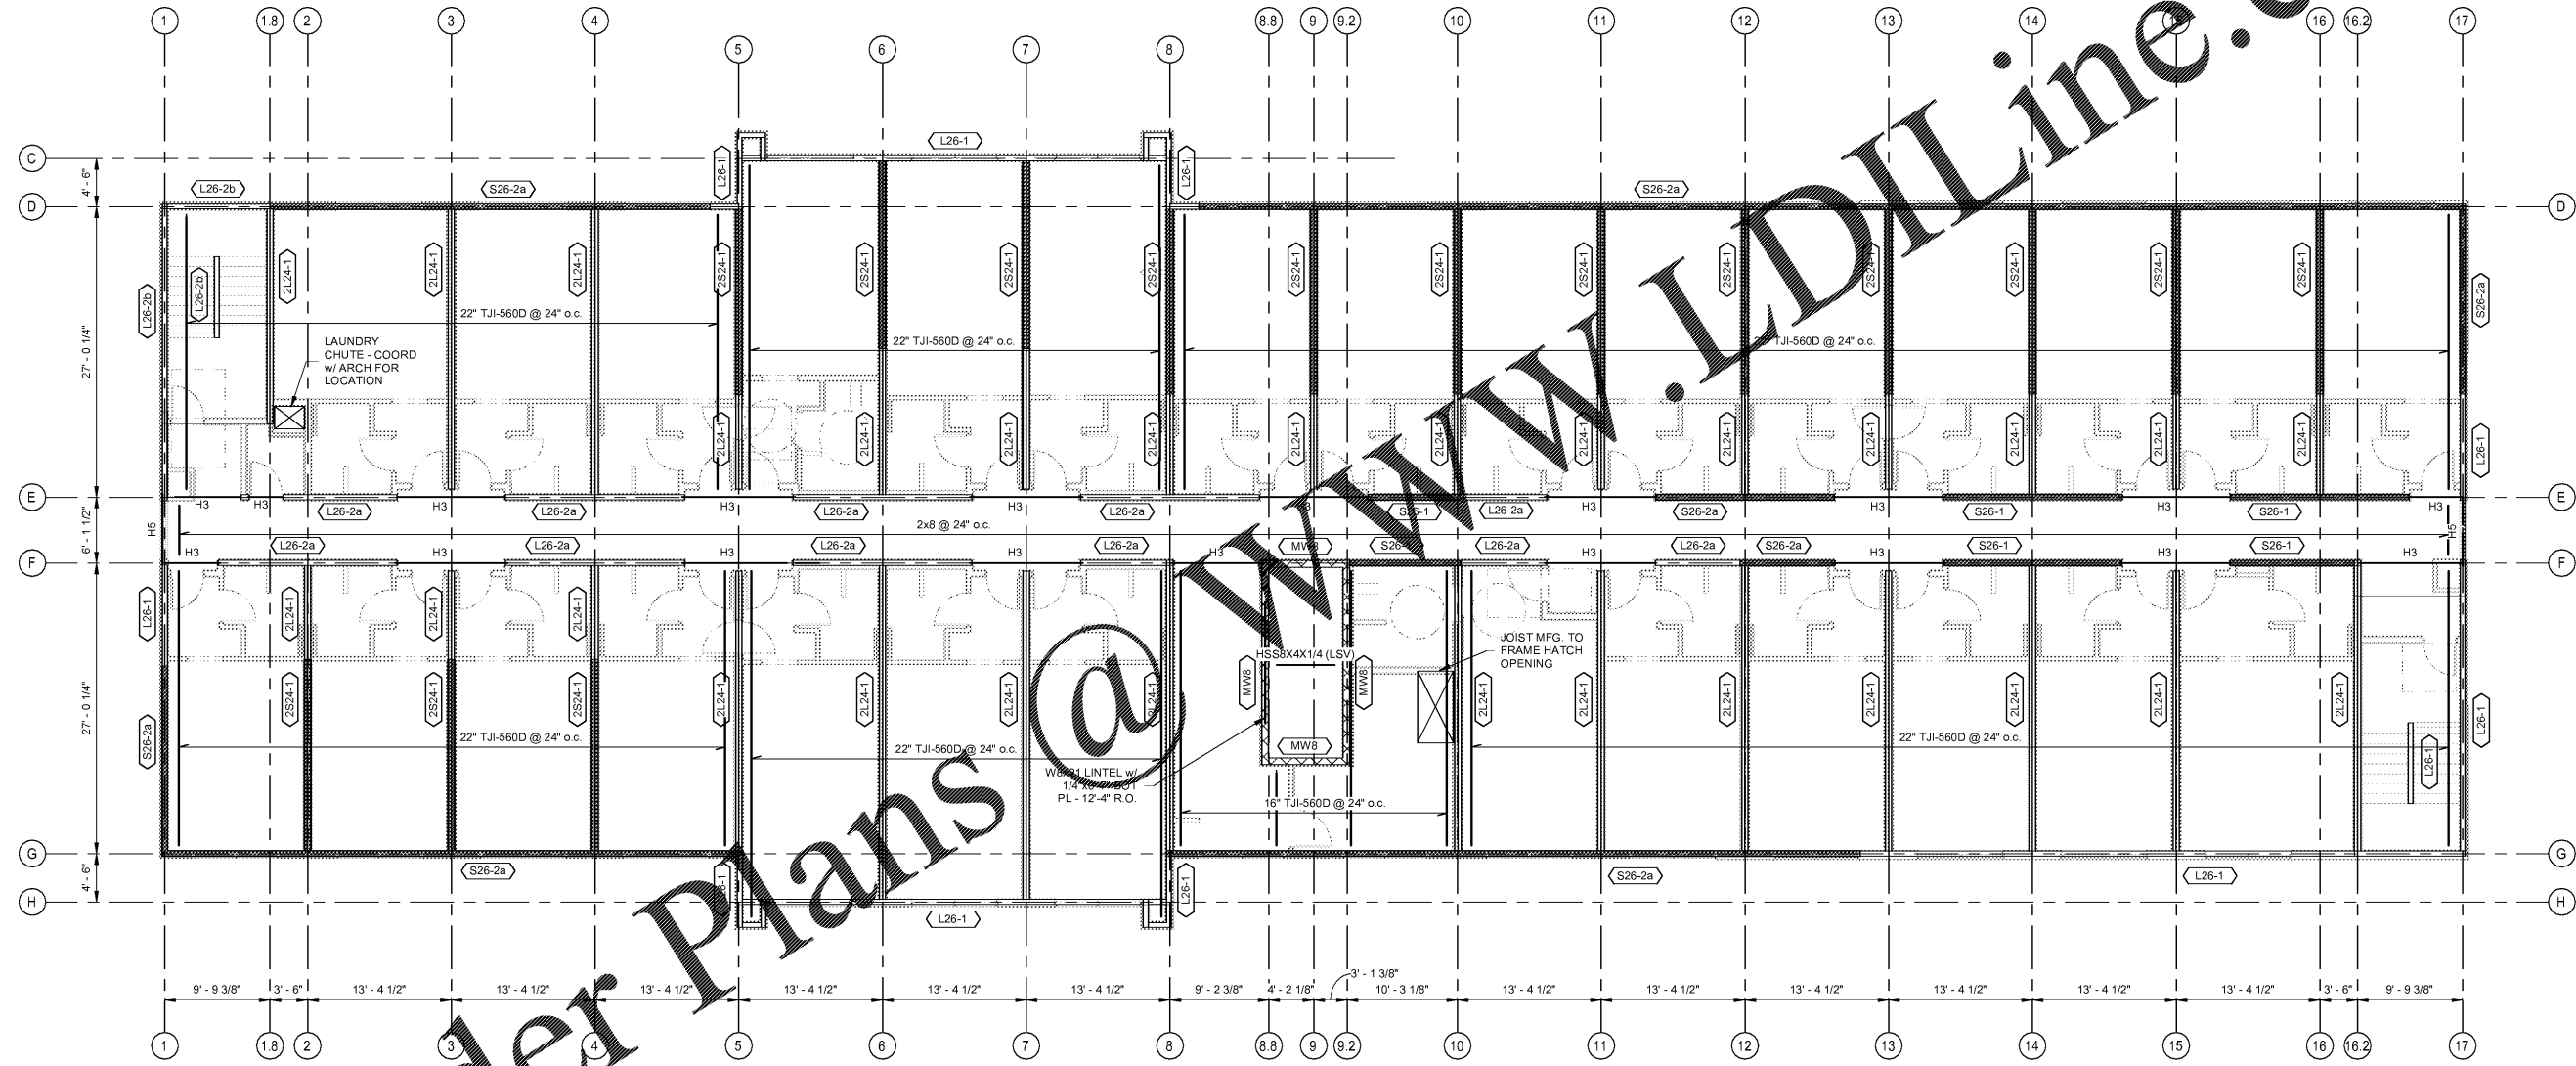

Roof Framing Plan
SCALE: 1/8" = 1'-0"

- NOTES:
1. ROOF JOIST BEARING ELEVATION (U.N.O.): 209' - 4"
 2. MAXIMUM ROOF JOIST SPACING 2'-0" U.N.O.
 3. COORDINATE MECHANICAL UNIT LOCATIONS AND LOADING WITH MECHANICAL CONTRACTOR. ADJUST ROOF FRAMING SPACING AS REQUIRED FOR MECHANICAL UNIT LOADING.
 4. ALL WOOD-TO-WOOD CONNECTIONS TO BE MADE WITH APPLICABLE SIMPSON PRODUCT OR EQUAL.
 5. ROOF CONSTRUCTION 3/4" PLYWOOD
 6. ROOF JOISTS TO SATISFY 3/4" TOTAL DEFLECTION & 3/8" SNOW DEFLECTION.
 7. SEE ARCHITECTURAL DRAWINGS FOR TAPERED INSULATION ON FLAT ROOF.
 8. FOR WOOD DETAILS AND SCHEDULES SEE: S2.4


Order Plans @ www.lidiline.com

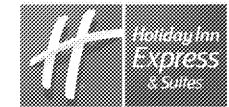

CONTRACTOR SHALL VERIFY ALL CONDITIONS AND DIMENSIONS FOR THE ENTIRE PROJECT BEFORE PROCEEDING WITH THE WORK.

No.	Description	Date

MEISTER-COX ARCHITECTS
 INFO@MEISTER-COX.COM
 PHONE: 610-375-1331 FAX: 610-375-4555
 1522 PENN AVENUE WYOMISSING, PA 19610
 WWW.MEISTER-COX.COM

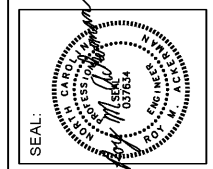

ROOF FRAMING PLAN
 HOLIDAY INN EXPRESS & SUITES
 INTERSECTION OF HAYNES PLACE & LAMM RD.
 WILSON, NC 27783

STATUS:	PERMIT
PROJ. DATE:	06-05-19
PROJ. NO.	1083218.000
PRINTED:	6/5/2019 4:24:29 PM
DRAWN BY:	RPK
CHECKED BY:	RMA
SHEET NO.	S2.3
SCALE:	As indicated