


BIM 360/1083218 000_HIEK-Wilson-NC_R19/Struct_1083218000_HIEK_Wilson-NC_R19.rvt

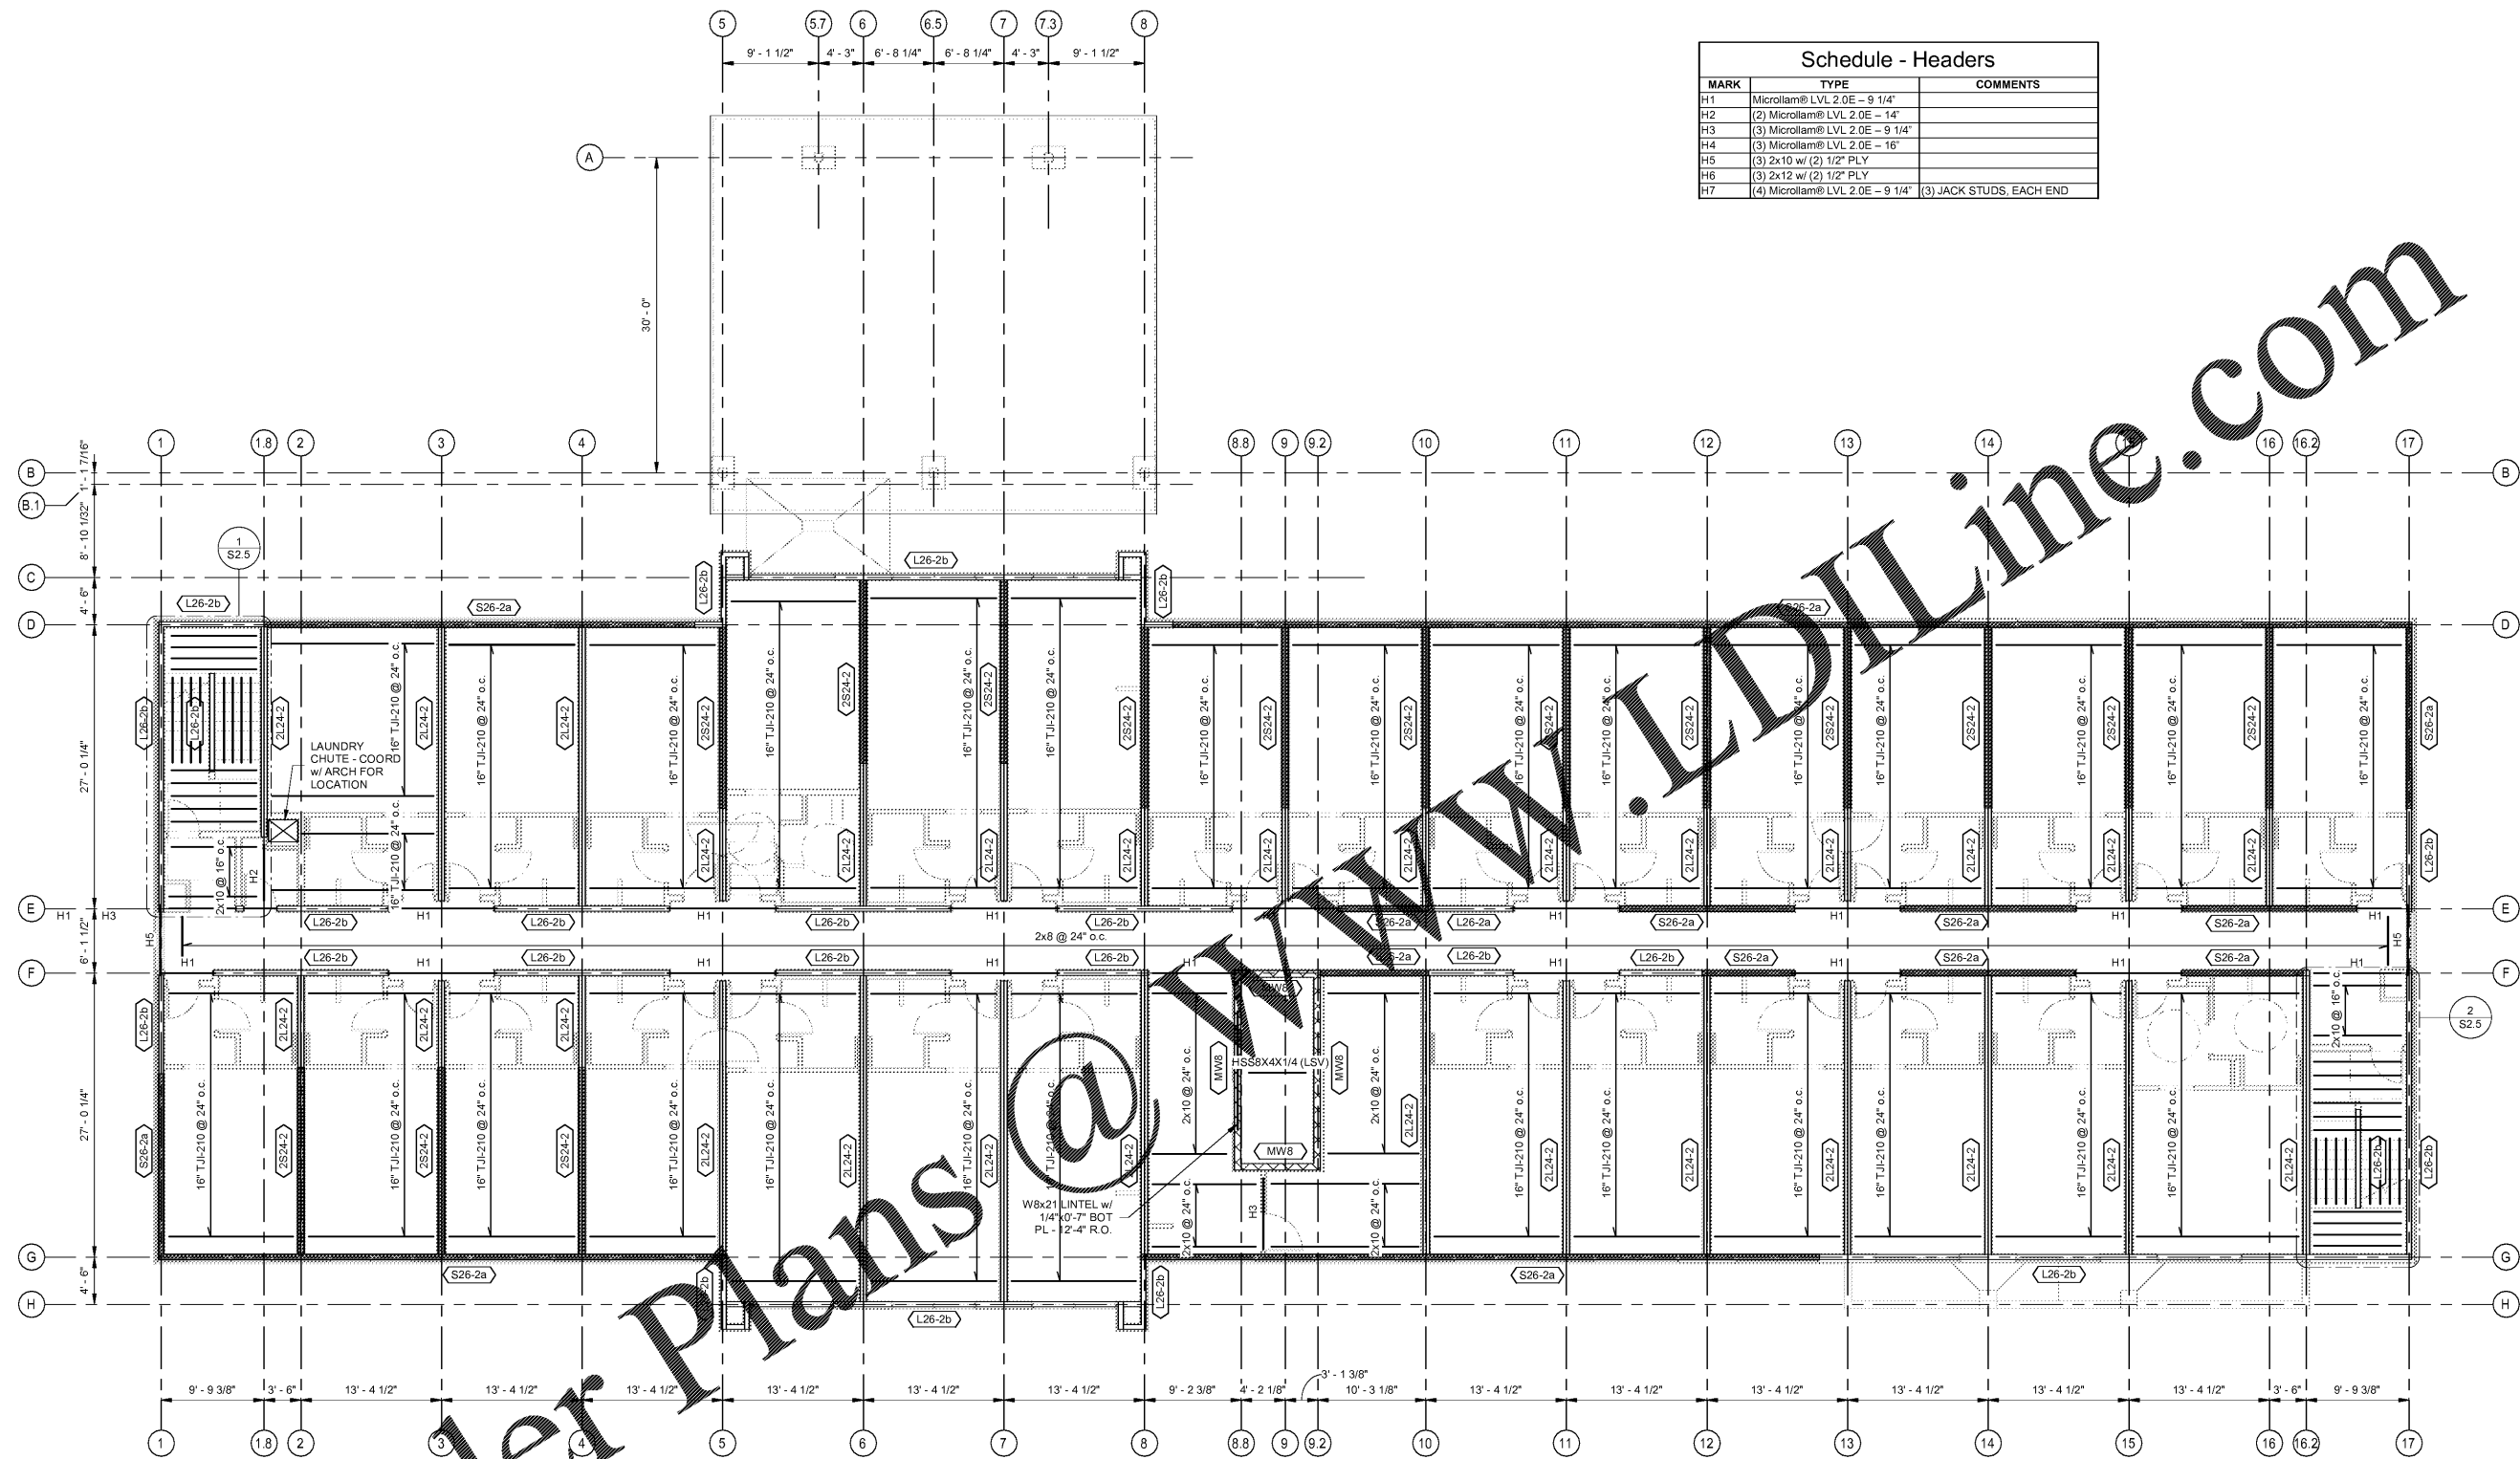

Order Plans @ www.ArchLine.com

Schedule - Headers		
MARK	TYPE	COMMENTS
H1	Microlam® LVL 2.0E - 9 1/4"	
H2	(2) Microlam® LVL 2.0E - 14"	
H3	(3) Microlam® LVL 2.0E - 9 1/4"	
H4	(3) Microlam® LVL 2.0E - 16"	
H5	(3) 2x10 w/ (2) 1/2" PLY	
H6	(3) 2x12 w/ (2) 1/2" PLY	
H7	(4) Microlam® LVL 2.0E - 9 1/4"	(3) JACK STUDS, EACH END


Level 3 Framing Plan
SCALE: 1/8" = 1'-0"

NOTES:
1. FINISH FLOOR ELEVATION (U.N.O.): 19'1" - 8"
2. FLOOR JOIST BEARING ELEVATION (U.N.O.): 19'0" - 2 1/4"
3. MAXIMUM FLOOR JOIST SPACING 2'-0" U.N.O.
4. ALL WOOD-TO-WOOD CONNECTIONS TO BE MADE WITH APPLICABLE SIMPSON PRODUCT OR EQUAL
5. SEE CHART BELOW FOR FLOOR SLAB AND/OR ROOF DECK TYPES
6. FOR WOOD DETAILS AND SCHEDULES SEE: S24

TYPE	DECK TYPE/GA/FINISH	MAX. BEAM SPACING	DECK FASTENING
3/4" Sheathing w/ 1" Gypcrete	APA Rated Sheathing - Exp 1 - Slurd-I-Floor	24" o.c.	Nailed W/ 10d @ 6" o.c.

No.	Description	Date

MEISTER-COX ARCHITECTS
 INFO@MEISTER-COX.COM
 PHONE: 610-375-1331 FAX: 610-375-4555
 1522 PENN AVENUE WYOMISSING, PA 19610
 WWW.MEISTER-COX.COM

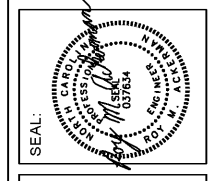

THIRD FLOOR FRAMING PLAN
 HOLIDAY INN EXPRESS & SUITES
 INTERSECTION OF HAYNES PLACE & LAMM RD.
 WILSON, NC 27783

STATUS:	PERMIT
PROJ. DATE:	06-05-19
PROJ. NO.	1083218.000
PRINTED:	6/5/2019 4:24:20 PM
DRAWN BY:	RPK
CHECKED BY:	RMA
SHEET NO.	S2.1
SCALE:	As indicated

BARRY J. SETTLE & ASSOCIATES
 610.398.0904
 barryjsettle.com

Holiday Inn Express & Suites

CONTRACTOR SHALL VERIFY ALL CONDITIONS AND DIMENSIONS FOR THE ENTIRE PROJECT BEFORE PROCEEDING WITH THE WORK.