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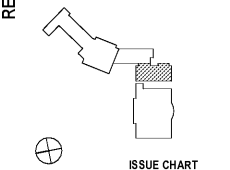
CONTRACTOR

PROJECT

**KIPP ATLANTA
COLLEGIATE - Addition
and Renovations**
98 Anderson Ave NW
Atlanta GA 30314

RELEASED FOR CONSTRUCTION 06/07/2019

KEYPLAN



ISSUE CHART




DATE	ISSUE	BY
18220	Job Number	ZZ
	Drawn	ZZ
	Checked	SG
	Approved	JH

**FOUNDATION PLAN -
PART B**


SHEET NUMBER

S11-01B

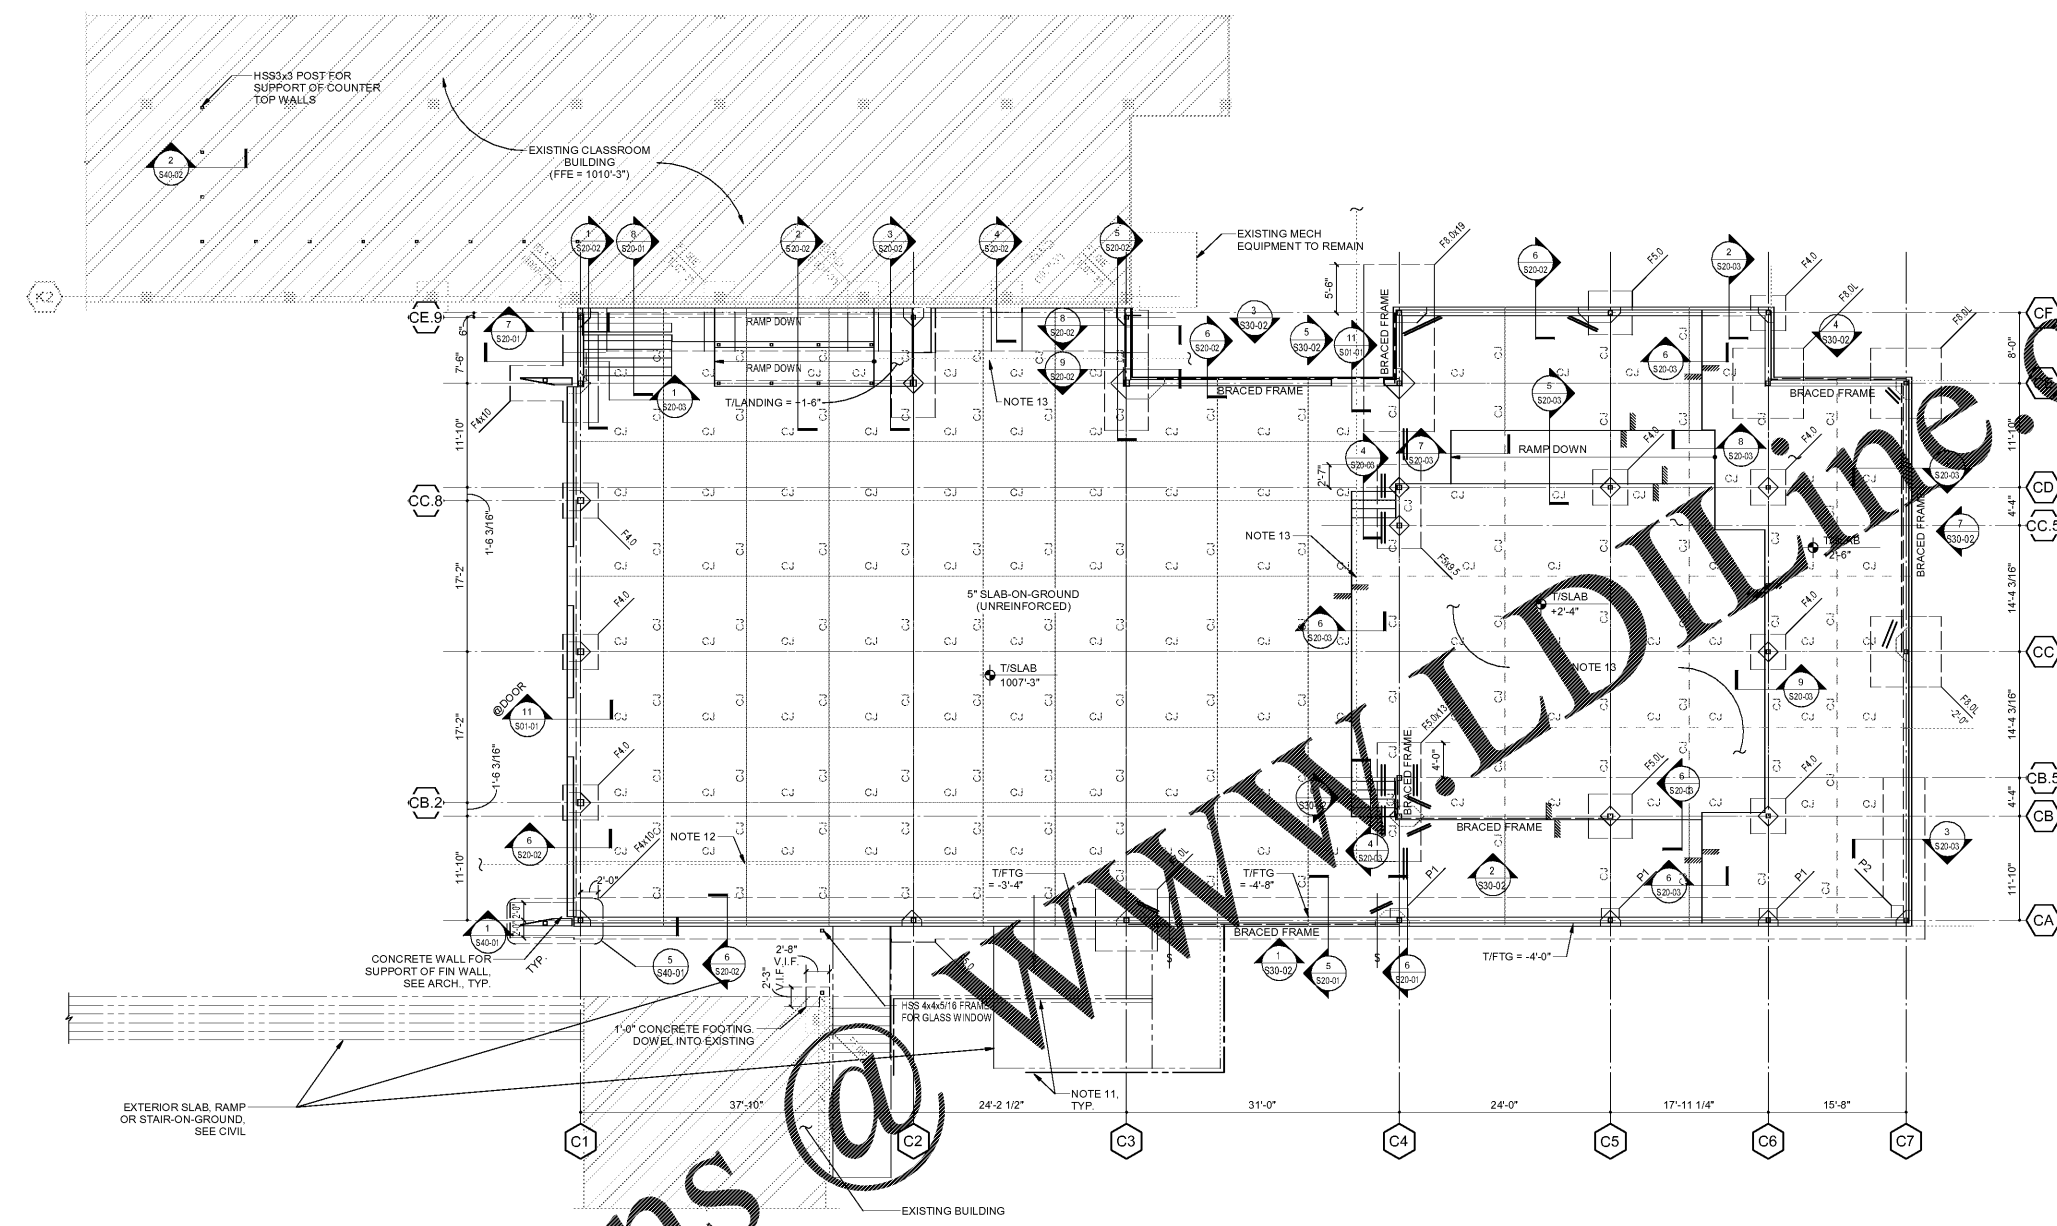

1 FOUNDATION PLAN PART B
S11-01B SCALE: 1/8" = 1'-0"

- FOUNDATION & S.O.G. NOTES:**
- TOP OF NOMINAL SLAB ELEVATION = 1007'-3". (ELEVATIONS ARE GIVEN RELATIVE TO GROUND FLOOR NOMINAL ELEVATION OF 0'-0". SEE CIVIL DRAWINGS FOR DATUM ELEVATION)
 - SLAB-ON-GROUND THICKNESS IS 5" U.N.O. SEE GENERAL NOTES FOR ADDITIONAL INFORMATION.
 - INDICATES STEP IN FOOTING. SEE 1/S01-01.
 - CJ INDICATES CONTRACTION JOINT. SEE 7/S01-01. CONTRACTION JOINTS ONLY IN SLAB ON GROUND & TOPPING SLABS. DO NOT CUT IN STRUCTURED SLABS. SEE 9/S01-01 FOR CONTRACTION JOINT DETAIL.
 - INDICATES REINFORCING AT CONTRACTION JOINT ENDS. SEE DETAIL 3/S01-01 FOR ADDITIONAL INFORMATION.
 - ALL FOOTINGS ARE CENTERED ABOUT COLUMN CENTERLINES U.N.O.
 - VERIFY FOOTING ELEVATIONS AT WET COLUMNS WITH ARCH. AND PLUMBING DRAWINGS.
 - SEE ARCH. DRAWINGS FOR EDGE OF SLAB DIMENSIONS, LOCATIONS OF DRAINS, SLOPES, AND CONTOURS OF AREAS SLOPED TO DRAIN NOT SHOWN. COORDINATE BEFORE POURING.
 - SEE S21-01 FOR COLUMN SCHEDULE.
 - SEE MEP DRAWINGS FOR HOUSEKEEPING PAD REQUIREMENTS UNDER EQUIPMENT.
 - INDICATES SITE WALL. SEE CIVIL FOR LAYOUT. SEE DETAILS ON 10/S20-03 FOR REINFORCING.
 - INDICATES UNDERSLAB PLUMBING LINES. COORDINATE WITH FOOTING LOCATIONS.
 - STAGE OVERBUILD CONSISTING OF 3" NORMAL WEIGHT CONCRETE ON 1-1/2" METAL FORM DECK ON 4", 18 GAGE CFMF STUD WALLS SPACED AT 4'-0" MAX. SEE ARCH FOR EXTENTS.

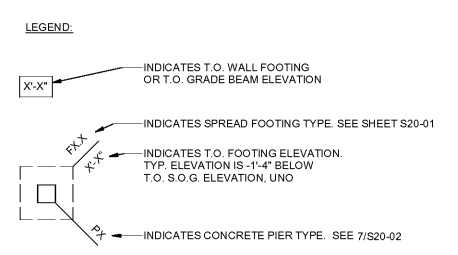

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