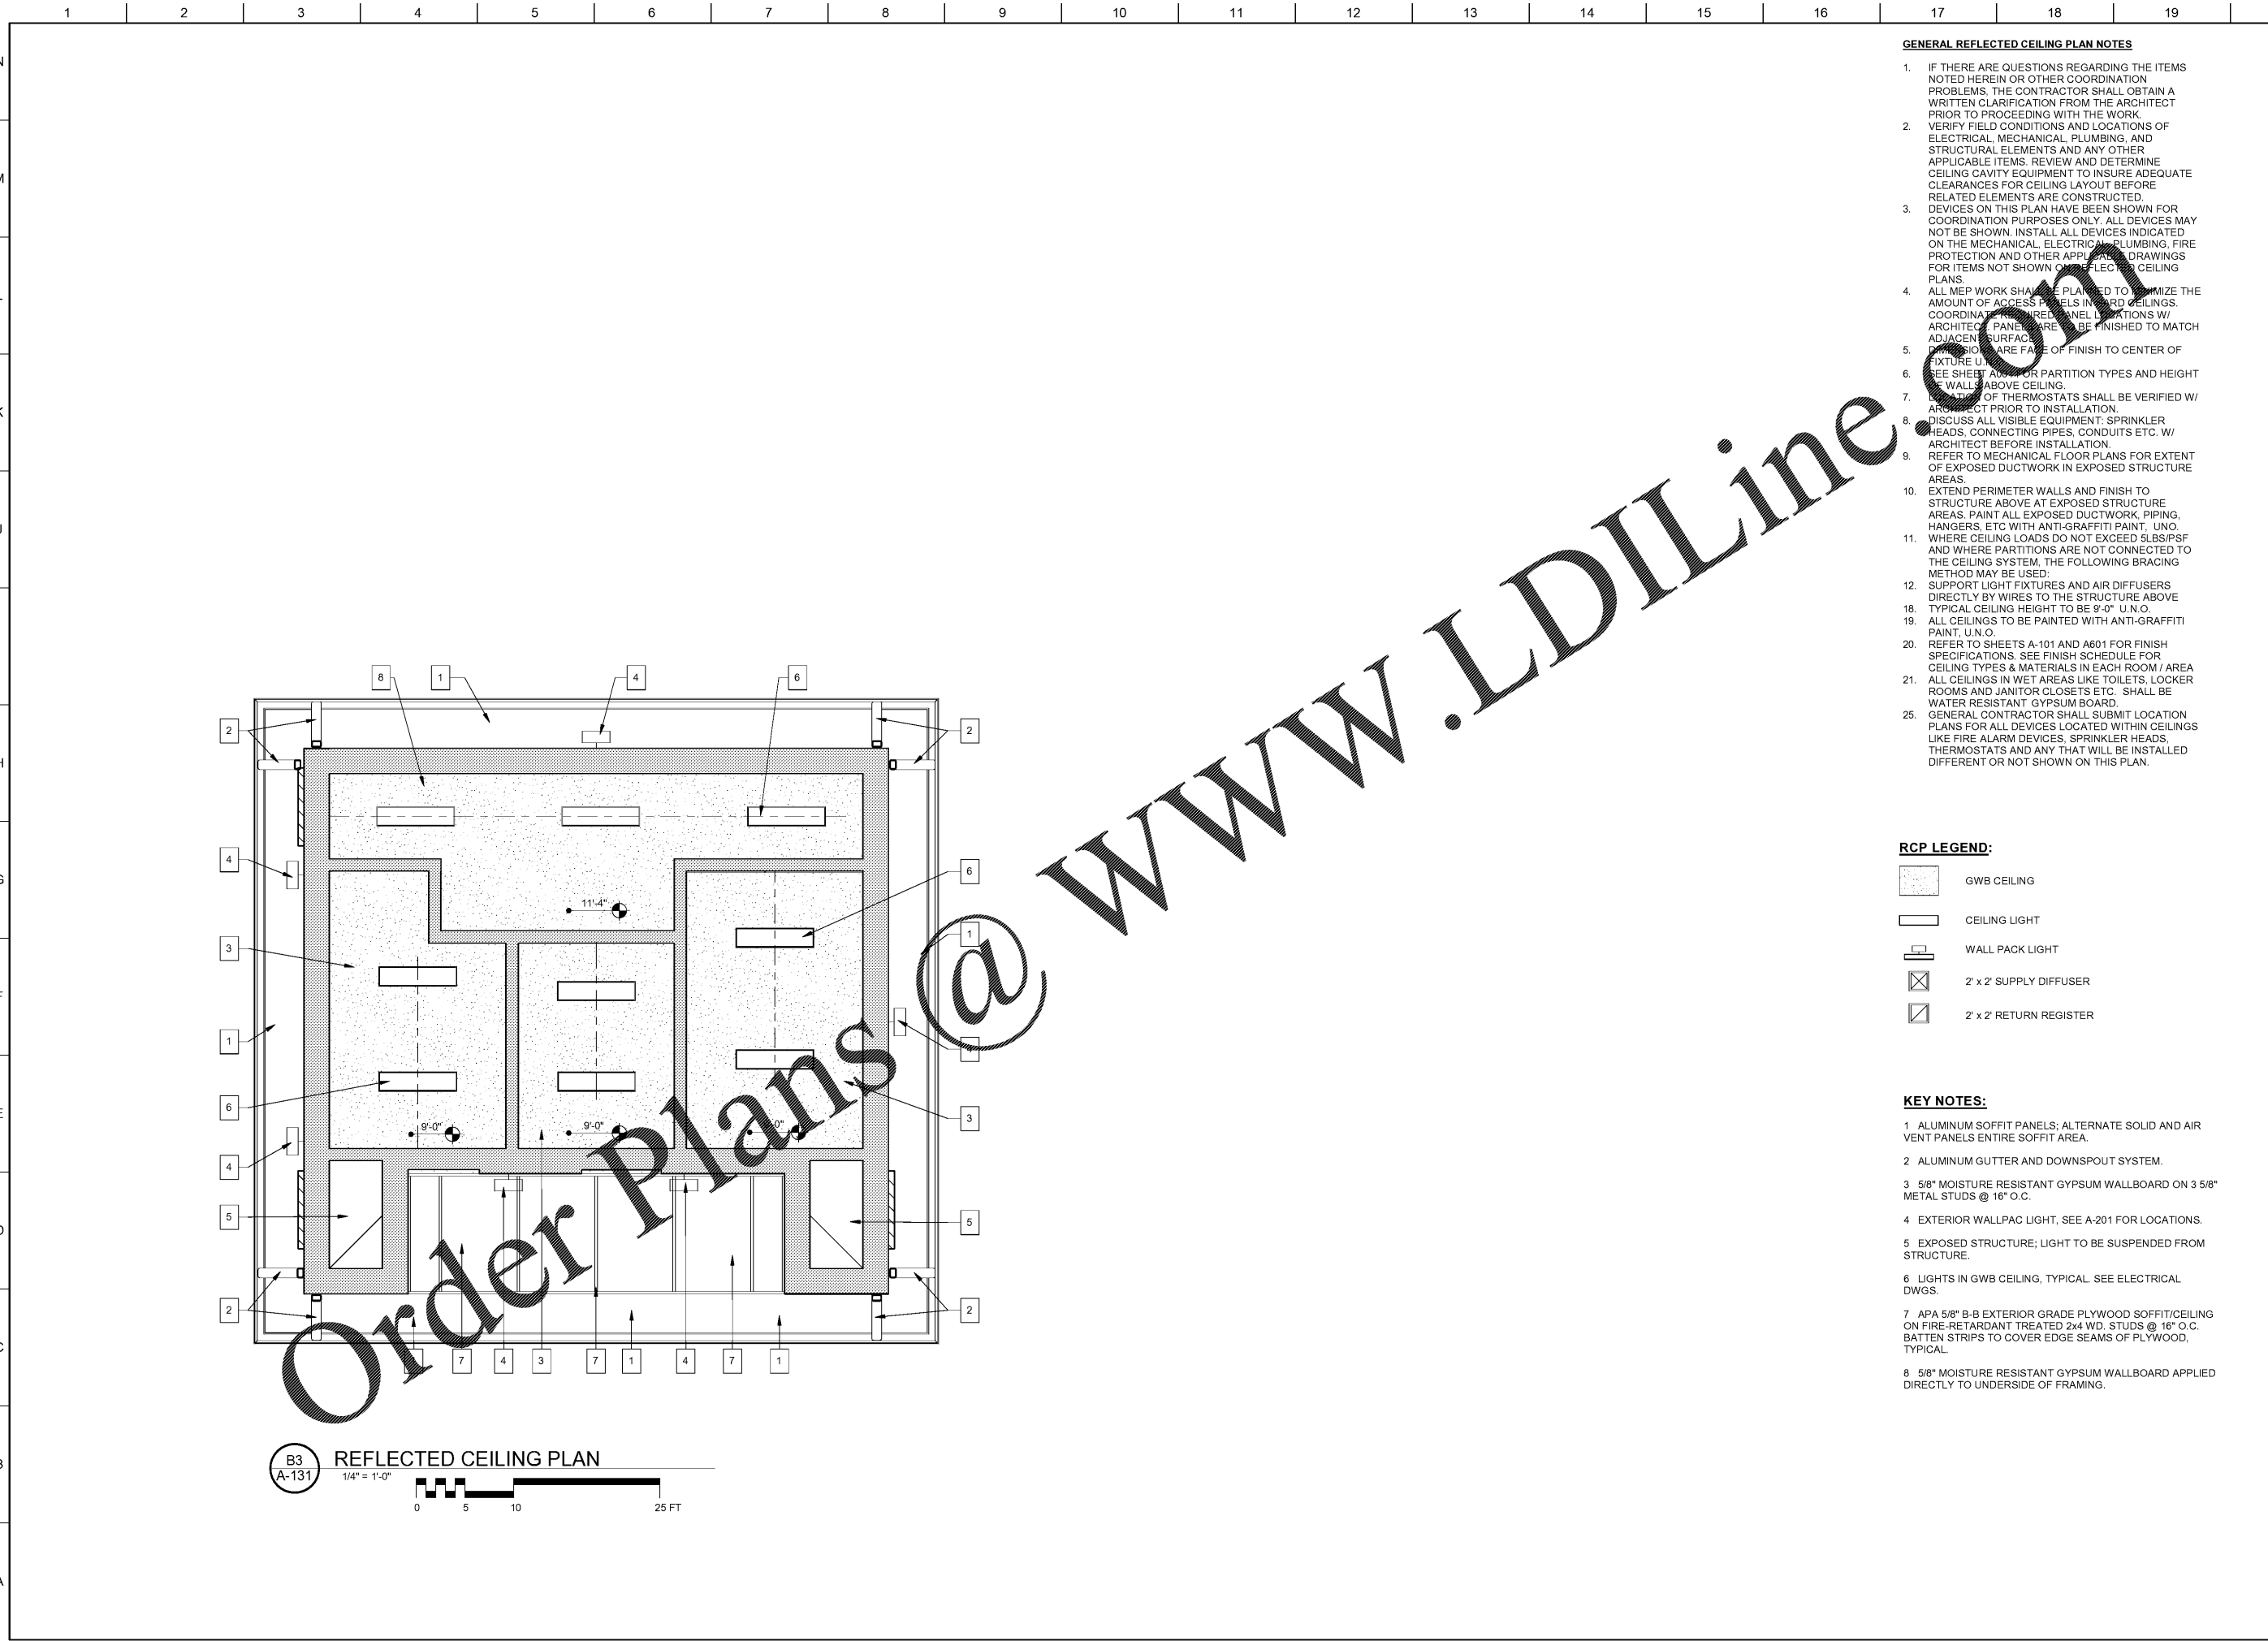


THIS SHEET PLOTS ON 22" x 34" ANSI D 1/2" = 1" 2" = 1/4" 3" = 1/8"

P:\COMMERCIAL\2016 PROJECT IN-BOX\2016-139 New Restroom at Durr Field\5. Drawing Info.c. Revit\16139 Durr Field Restrooms.rvt
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B3
A-131
 REFLECTED CEILING PLAN
 1/4" = 1'-0"
 0 5 10 25 FT

GENERAL REFLECTED CEILING PLAN NOTES

- IF THERE ARE QUESTIONS REGARDING THE ITEMS NOTED HEREIN OR OTHER COORDINATION PROBLEMS, THE CONTRACTOR SHALL OBTAIN A WRITTEN CLARIFICATION FROM THE ARCHITECT PRIOR TO PROCEEDING WITH THE WORK.
- VERIFY FIELD CONDITIONS AND LOCATIONS OF ELECTRICAL, MECHANICAL, PLUMBING, AND STRUCTURAL ELEMENTS AND ANY OTHER APPLICABLE ITEMS. REVIEW AND DETERMINE CEILING CAVITY EQUIPMENT TO INSURE ADEQUATE CLEARANCES FOR CEILING LAYOUT BEFORE RELATED ELEMENTS ARE CONSTRUCTED.
- DEVICES ON THIS PLAN HAVE BEEN SHOWN FOR COORDINATION PURPOSES ONLY. ALL DEVICES MAY NOT BE SHOWN. INSTALL ALL DEVICES INDICATED ON THE MECHANICAL, ELECTRICAL, PLUMBING, FIRE PROTECTION AND OTHER APPLICABLE DRAWINGS FOR ITEMS NOT SHOWN ON REFLECTED CEILING PLANS.
- ALL MEP WORK SHALL BE PLACED TO MINIMIZE THE AMOUNT OF ACCESS PANELS IN FLOOR CEILINGS. COORDINATE ALL WIRE AND PANEL LOCATIONS W/ ARCHITECT. PANELS ARE TO BE FINISHED TO MATCH ADJACENT SURFACE.
- FIXTURES ARE FACE OF FINISH TO CENTER OF REE SHEET UNLESS PARTITION TYPES AND HEIGHT OF WALLS ABOVE CEILING.
- LOCATION OF THERMOSTATS SHALL BE VERIFIED W/ ARCHITECT PRIOR TO INSTALLATION.
- DISCUSS ALL VISIBLE EQUIPMENT: SPRINKLER HEADS, CONNECTING PIPES, CONDUITS ETC. W/ ARCHITECT BEFORE INSTALLATION.
- REFER TO MECHANICAL FLOOR PLANS FOR EXTENT OF EXPOSED DUCTWORK IN EXPOSED STRUCTURE AREAS.
- EXTEND PERIMETER WALLS AND FINISH TO STRUCTURE ABOVE AT EXPOSED STRUCTURE AREAS. PAINT ALL EXPOSED DUCTWORK, PIPING, HANGERS, ETC WITH ANTI-GRAFFITI PAINT, UNO.
- WHERE CEILING LOADS DO NOT EXCEED 5LBS/PSF AND WHERE PARTITIONS ARE NOT CONNECTED TO THE CEILING SYSTEM, THE FOLLOWING BRACING METHOD MAY BE USED:
- SUPPORT LIGHT FIXTURES AND AIR DIFFUSERS DIRECTLY BY WIRES TO THE STRUCTURE ABOVE TYPICAL CEILING HEIGHT TO BE 9'-0" U.N.O.
- ALL CEILINGS TO BE PAINTED WITH ANTI-GRAFFITI PAINT, U.N.O.
- REFER TO SHEETS A-101 AND A601 FOR FINISH SPECIFICATIONS. SEE FINISH SCHEDULE FOR CEILING TYPES & MATERIALS IN EACH ROOM / AREA
- ALL CEILINGS IN WET AREAS LIKE TOILETS, LOCKER ROOMS AND JANITOR CLOSETS ETC. SHALL BE WATER RESISTANT GYPSUM BOARD.
- GENERAL CONTRACTOR SHALL SUBMIT LOCATION PLANS FOR ALL DEVICES LOCATED WITHIN CEILINGS LIKE FIRE ALARM DEVICES, SPRINKLER HEADS, THERMOSTATS AND ANY THAT WILL BE INSTALLED DIFFERENT OR NOT SHOWN ON THIS PLAN.


RCP LEGEND:

- GWB CEILING
- CEILING LIGHT
- WALL PACK LIGHT
- 2' x 2' SUPPLY DIFFUSER
- 2' x 2' RETURN REGISTER

KEY NOTES:

- ALUMINUM SOFFIT PANELS; ALTERNATE SOLID AND AIR VENT PANELS ENTIRE SOFFIT AREA.
- ALUMINUM GUTTER AND DOWNSPOUT SYSTEM.
- 5/8" MOISTURE RESISTANT GYPSUM WALLBOARD ON 3 5/8" METAL STUDS @ 16" O.C.
- EXTERIOR WALLPAC LIGHT, SEE A-201 FOR LOCATIONS.
- EXPOSED STRUCTURE; LIGHT TO BE SUSPENDED FROM STRUCTURE.
- LIGHTS IN GWB CEILING, TYPICAL. SEE ELECTRICAL DWGS.
- APA 5/8" B-B EXTERIOR GRADE PLYWOOD SOFFIT/CEILING ON FIRE-RETARDANT TREATED 2x4 WD. STUDS @ 16" O.C. BATTEN STRIPS TO COVER EDGE SEAMS OF PLYWOOD, TYPICAL.
- 5/8" MOISTURE RESISTANT GYPSUM WALLBOARD APPLIED DIRECTLY TO UNDERSIDE OF FRAMING.

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 ACWORTH, GEORGIA 30101

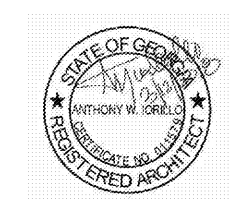No.	Date	Description
0	2018-03-12	ISSUED FOR CONSTRUCTION
	2016-07-22	100% Set
B	2016-07-15	IN-HOUSE REVIEW
ISSUANCE		

PROJECT NUMBER
16139
 DRAWN: LAP CHECKED: AWI
 SHEET TITLE
REFLECTED CEILING PLAN
 SHEET NO.
A-131