


Revisions		
#	Date	Description

Project Number: 18021
Issued for: CONSTRUCTION
Issue Date: 2019.05.07

DRAWING TITLE
**MECHANICAL
ROOF PLAN**

SHEET NUMBER
M.103

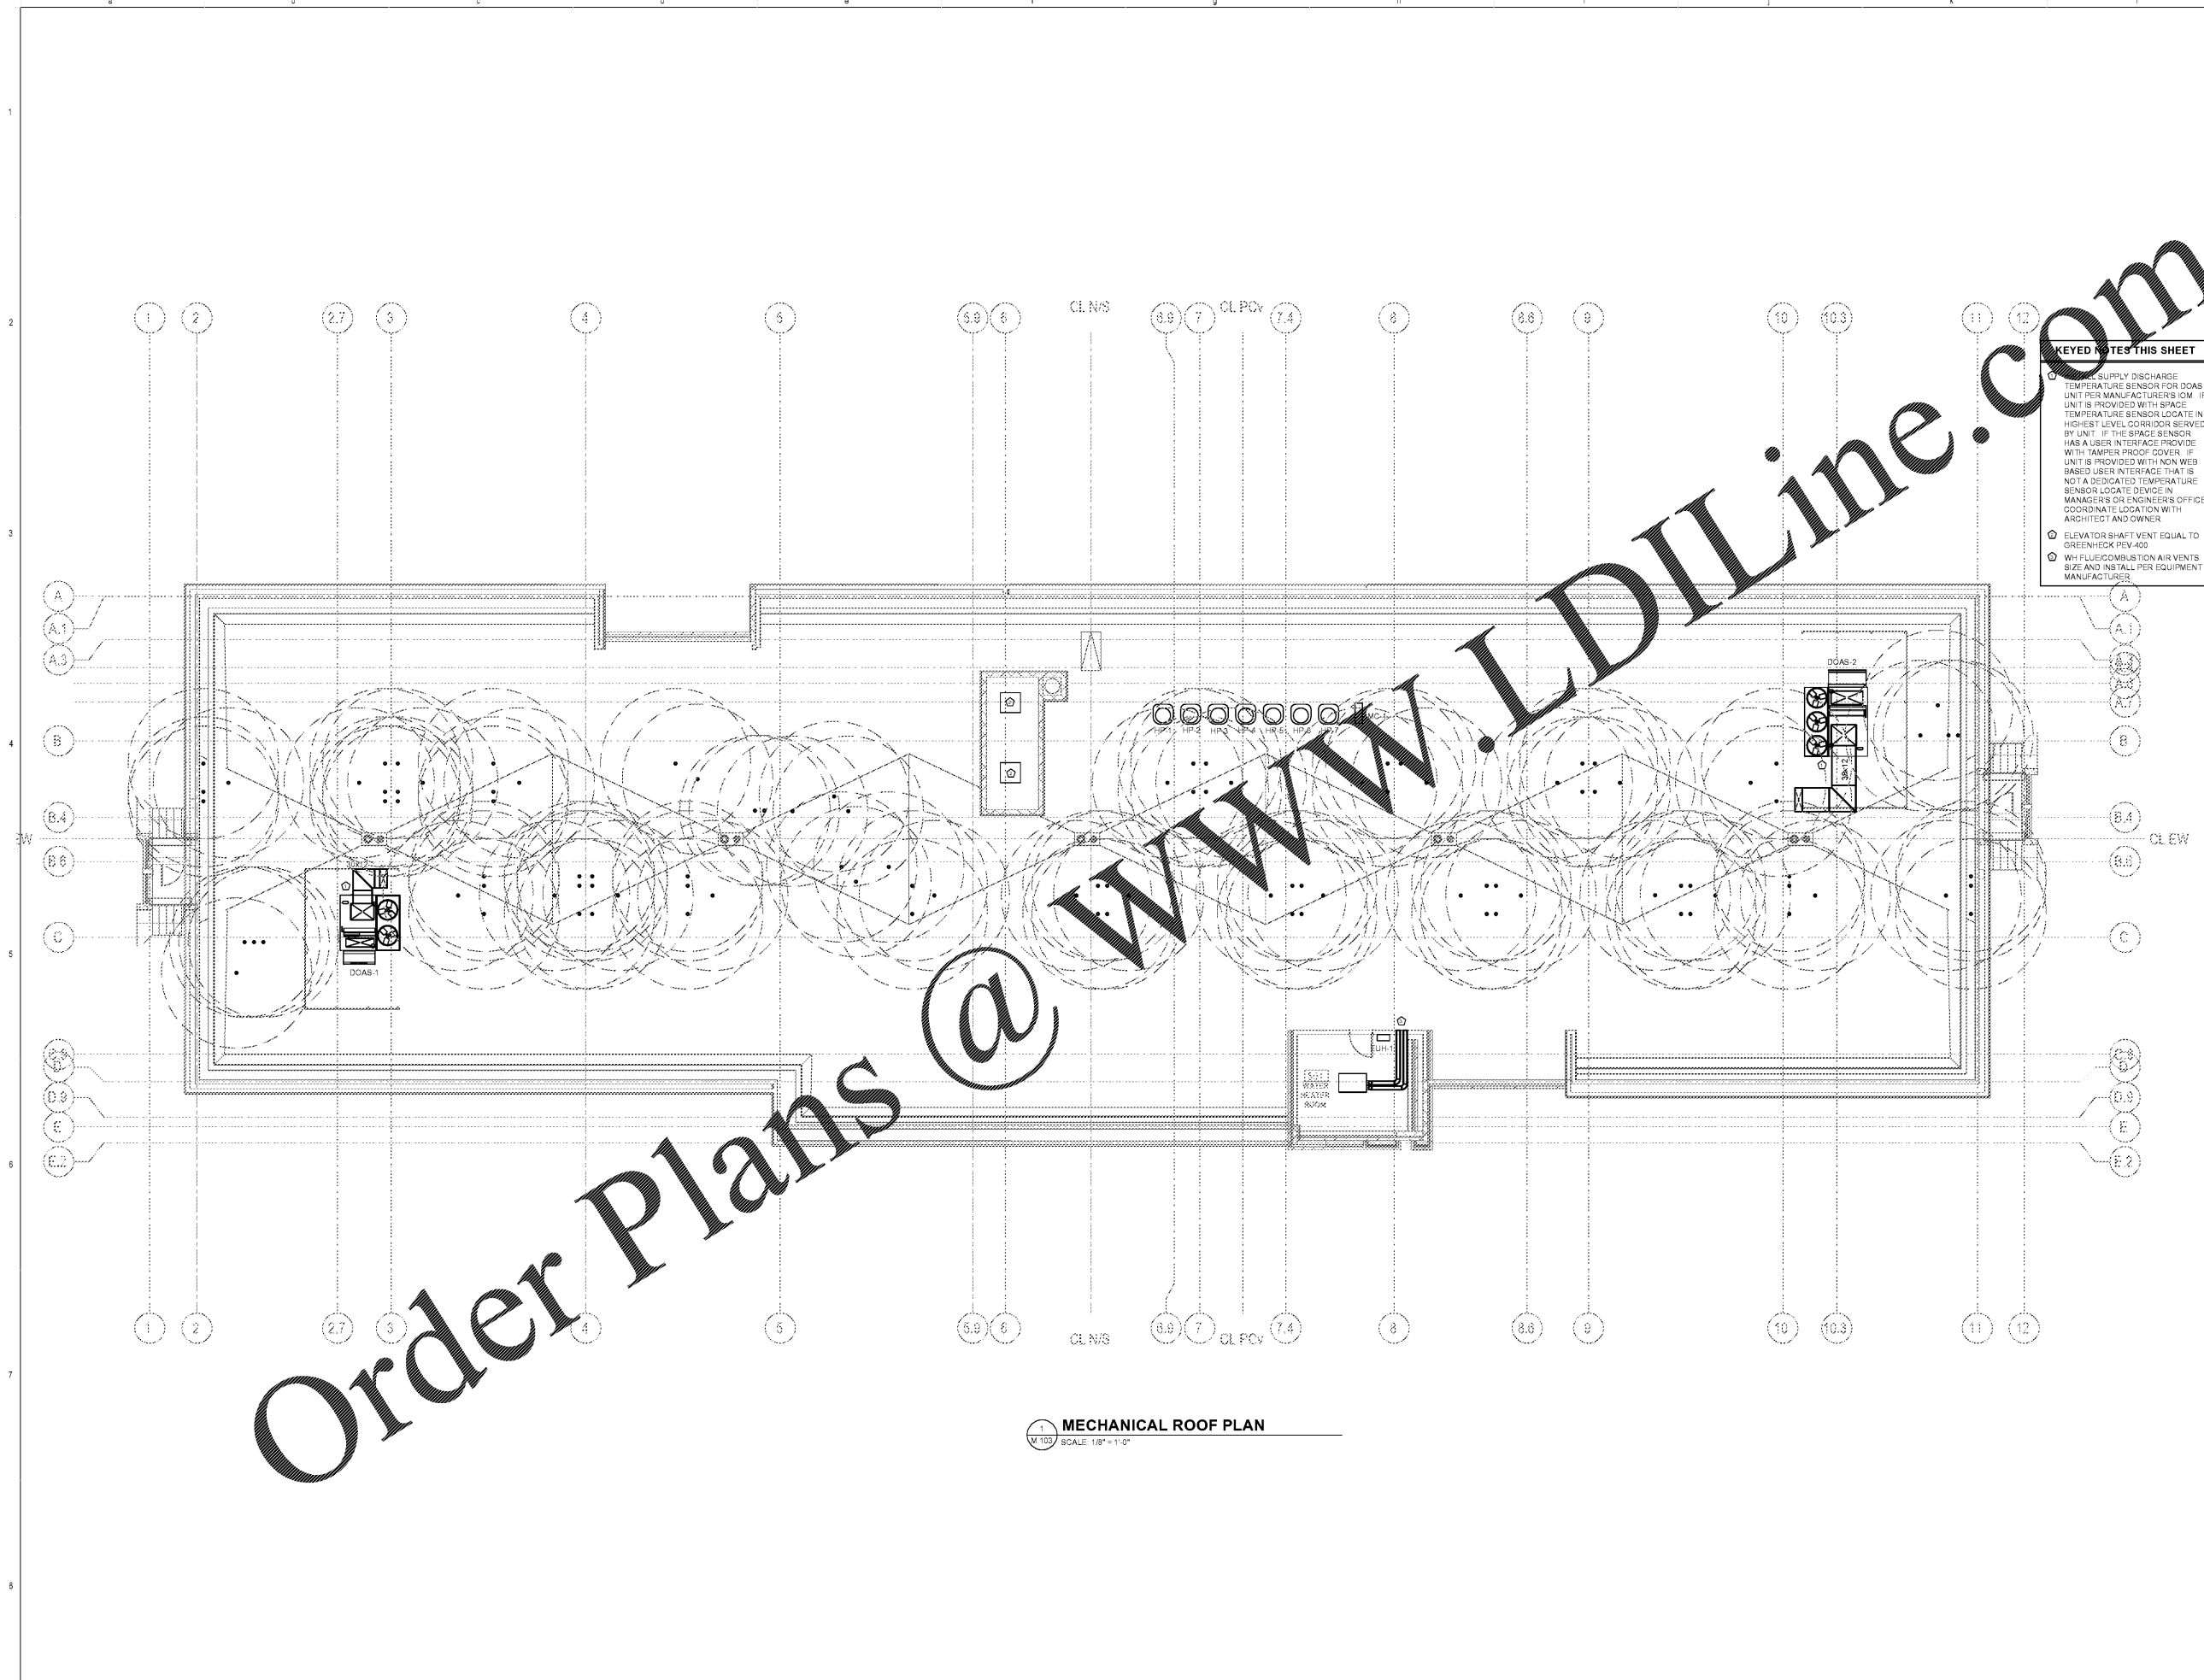

KEYED NOTES THIS SHEET

- SUPPLY DISCHARGE TEMPERATURE SENSOR FOR DOAS UNIT PER MANUFACTURER'S IOM. IF UNIT IS PROVIDED WITH SPACE TEMPERATURE SENSOR LOCATE IN HIGHEST LEVEL CORRIDOR SERVED BY UNIT. IF THE SPACE SENSOR HAS A USER INTERFACE PROVIDE WITH "TAMPER PROOF" COVER. IF UNIT IS PROVIDED WITH NON WEB BASED USER INTERFACE THAT IS NOT A DEDICATED TEMPERATURE SENSOR LOCATE DEVICE IN MANAGER'S OR ENGINEER'S OFFICE COORDINATE LOCATION WITH ARCHITECT AND OWNER.
- ELEVATOR SHAFT VENT EQUAL TO GREENHECK PEV-400.
- WH FLUE/COMBUSTION AIR VENTS SIZE AND INSTALL PER EQUIPMENT MANUFACTURER.

M.103 MECHANICAL ROOF PLAN
SCALE: 1/8" = 1'-0"

Order Plans @