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DATE	DESCRIPTION
05/28/19	COORDINATION SET
02/20/19	HEALTH SUBMITTAL
04/24/19	HEALTH RESPONSE
05/03/19	PERMIT/BD SET

PROFESSIONAL SEAL

PROFESSIONAL IN CHARGE  
S. KOUGAS  
PROJECT MANAGER  
E. ARELLANO  
QUALITY CONTROL  
S. KOUGAS  
DRAWN BY  
E. ARELLANO

PROJECT NAME  
**BUBBA'S 33**

**GASTONIA**  
NORTH CAROLINA

3287 E. FRANKLIN BLVD.




PROJECT NUMBER  
20181046.0

SHEET TITLE


**BUILDING SECTIONS**

SHEET NUMBER


**A5**

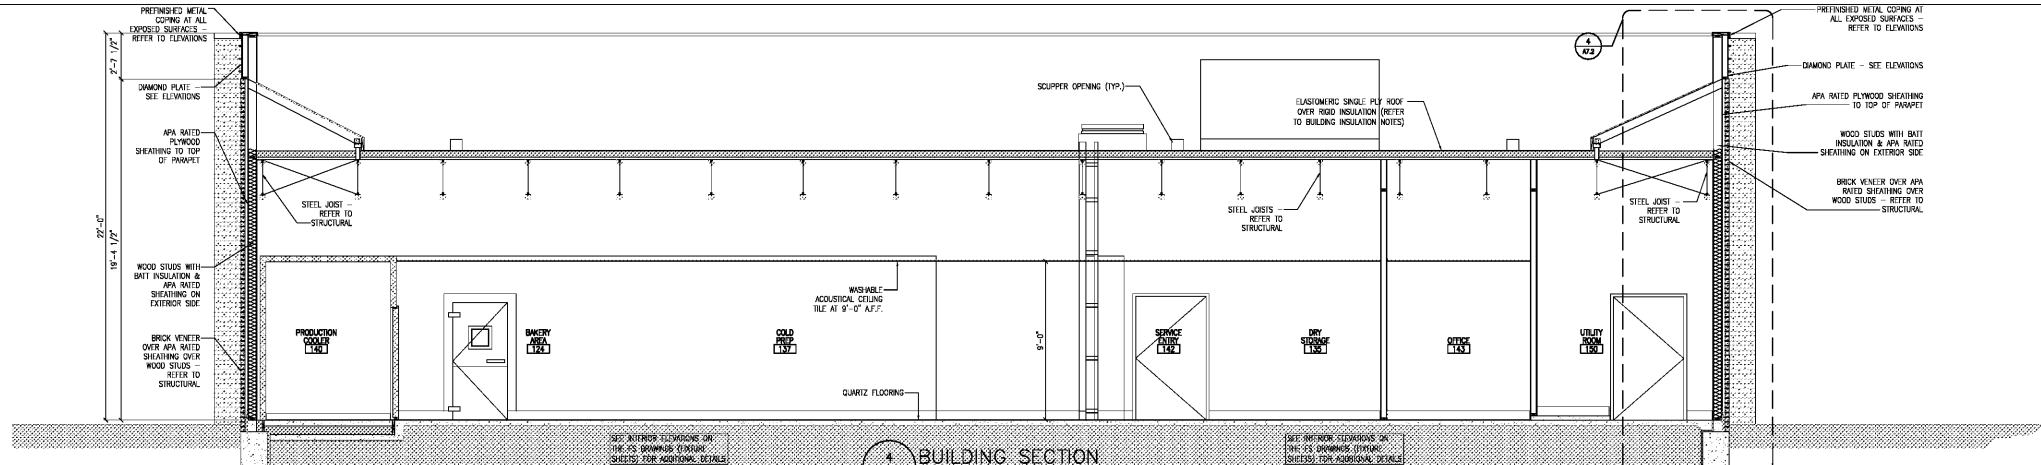


**4 BUILDING SECTION**  
A5  
SCALE: 1/4" = 1'-0"

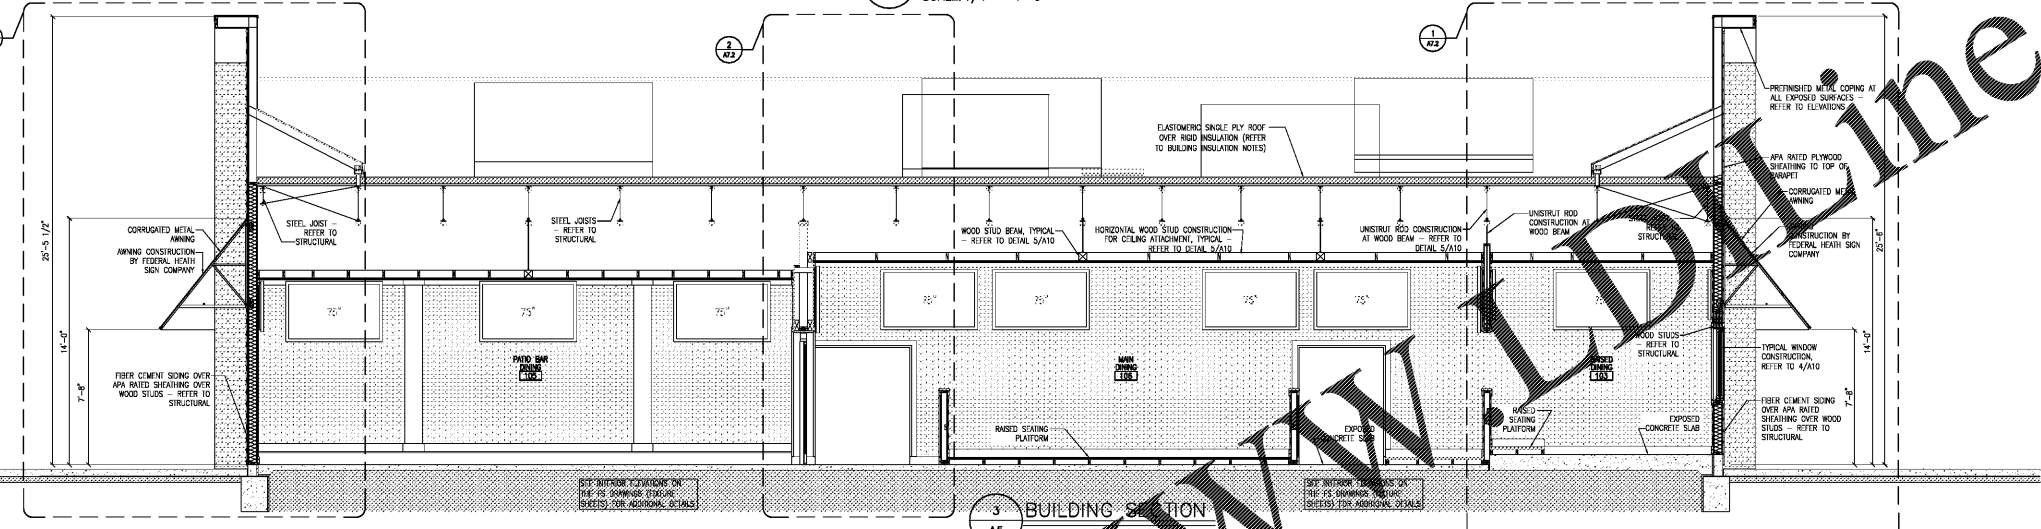

**3 BUILDING SECTION**  
A5  
SCALE: 1/4" = 1'-0"

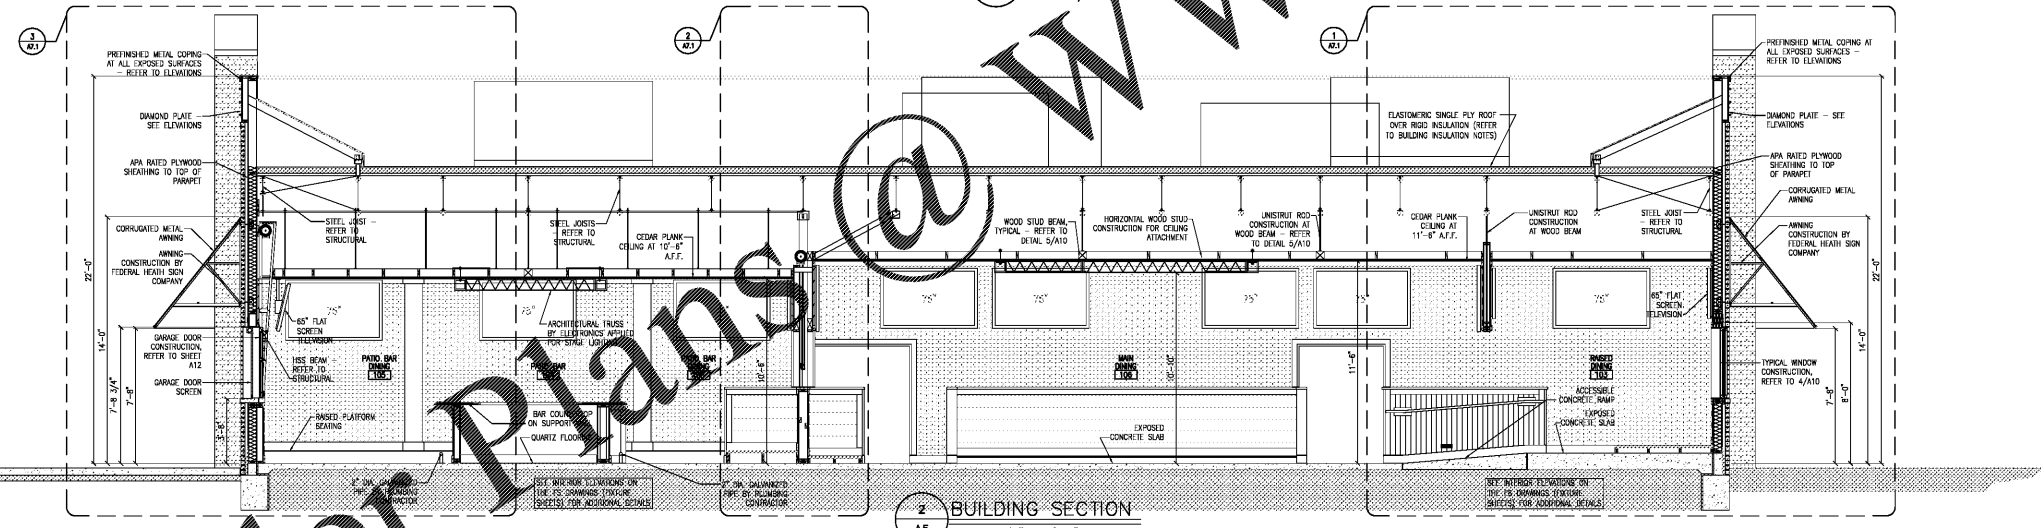

**2 BUILDING SECTION**  
A5  
SCALE: 1/4" = 1'-0"

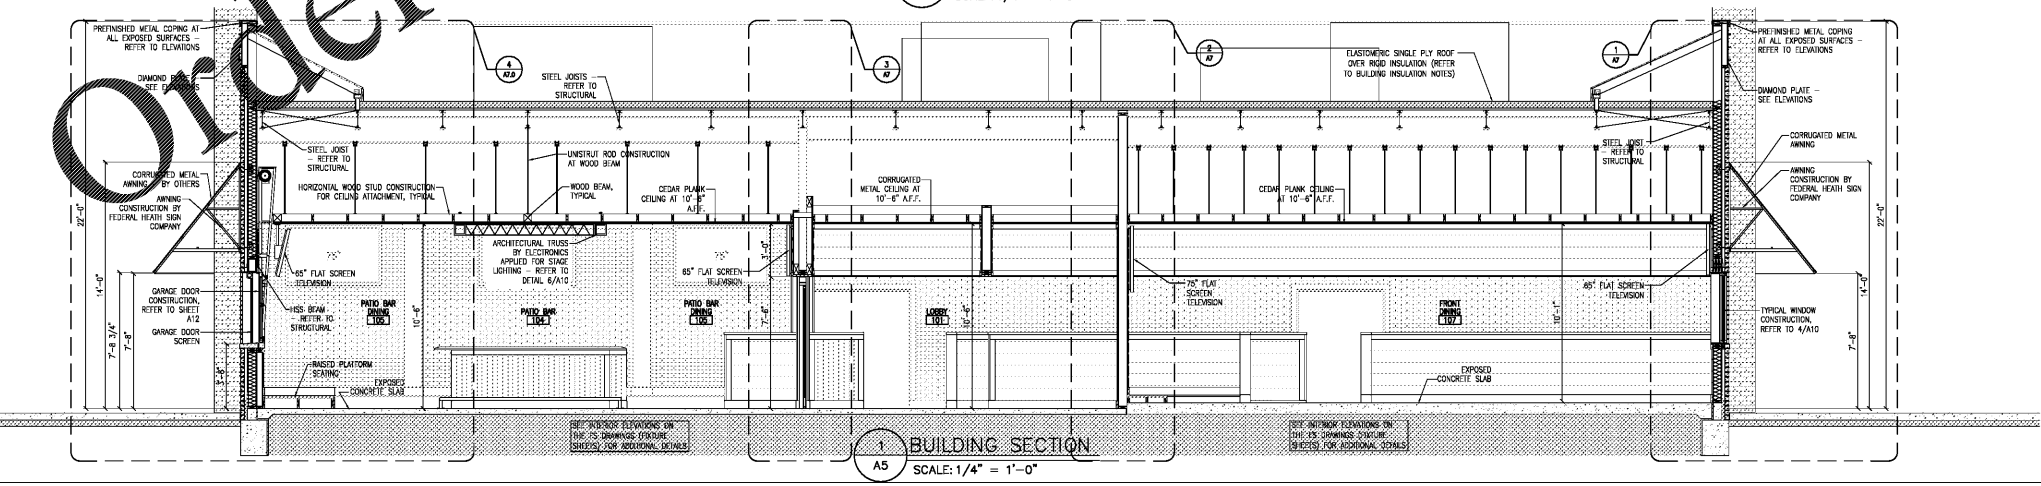

**1 BUILDING SECTION**  
A5  
SCALE: 1/4" = 1'-0"

**METAL DECKING NOTES**

1. 36" WIDE 1 1/2" DEEP, 20 GAUGE TYPE B WIDE RB ROOF DECK.
- VERIFY THICKNESSES WITH ROOF FRAMING PLAN NOTES ON SHEET S3. SHOULD DISCREPANCIES OCCUR BETWEEN THESE SECTIONS & THE STRUCTURAL PLANS, THE STRUCTURAL PLANS SHALL TAKE PRECEDENCE.

**BUILDING SHEATHING NOTES**

1. WALL SHEATHING: 1/2" APA RATED PLYWOOD ON ORIENTED STRAND BOARD (OSB) EXCEPT WHERE OTHERWISE NOTED.
  2. ROOF SHEATHING AT SLOPED ROOF: 1/2" 1&G APA RATED PLYWOOD OR ORIENTED STRAND BOARD (OSB) EXCEPT WHERE OTHERWISE NOTED.
- VERIFY THICKNESSES WITH SECTION J - PLYWOOD ON SHEET S1. SHOULD DISCREPANCIES OCCUR BETWEEN THESE SECTIONS & THE STRUCTURAL PLANS, THE STRUCTURAL PLANS SHALL TAKE PRECEDENCE.

**BUILDING INSULATION NOTES**

1. ALL ROOF AREAS WITH CONDITIONED SPACE BELOW TO HAVE TYPICAL - MIN. OF R-23.6 INSULATION (THICKNESS = 4")
  2. ALL EXTERIOR STUD WALLS TO HAVE MIN. OF R21 BATT INSULATION (THICKNESS = 5 1/2")
  3. VERTICAL FOUNDATION WALL TO HAVE MIN. OF R-5 ROOF INSULATION (THICKNESS = 1")
- SEE SHEET SPC2, SECTION 7, SECTION 07120 BUILDING INSULATION FOR MORE INFORMATION.  
INSULATION REQUIREMENTS METI, Cellulose and CO2 REQUIREMENTS. ALTERNATE R-VALUES SHALL BE COORDINATED WITH ARCHITECT.

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