

ISSUE/REVISION RECORD

DATE	DESCRIPTION
01/29/19	COORDINATION SET
02/20/19	MECHANICAL SET
04/24/19	MECHANICAL RESPONSE
05/03/19	PERMIT/SD SET

ROOF FRAMING PLAN NOTES:

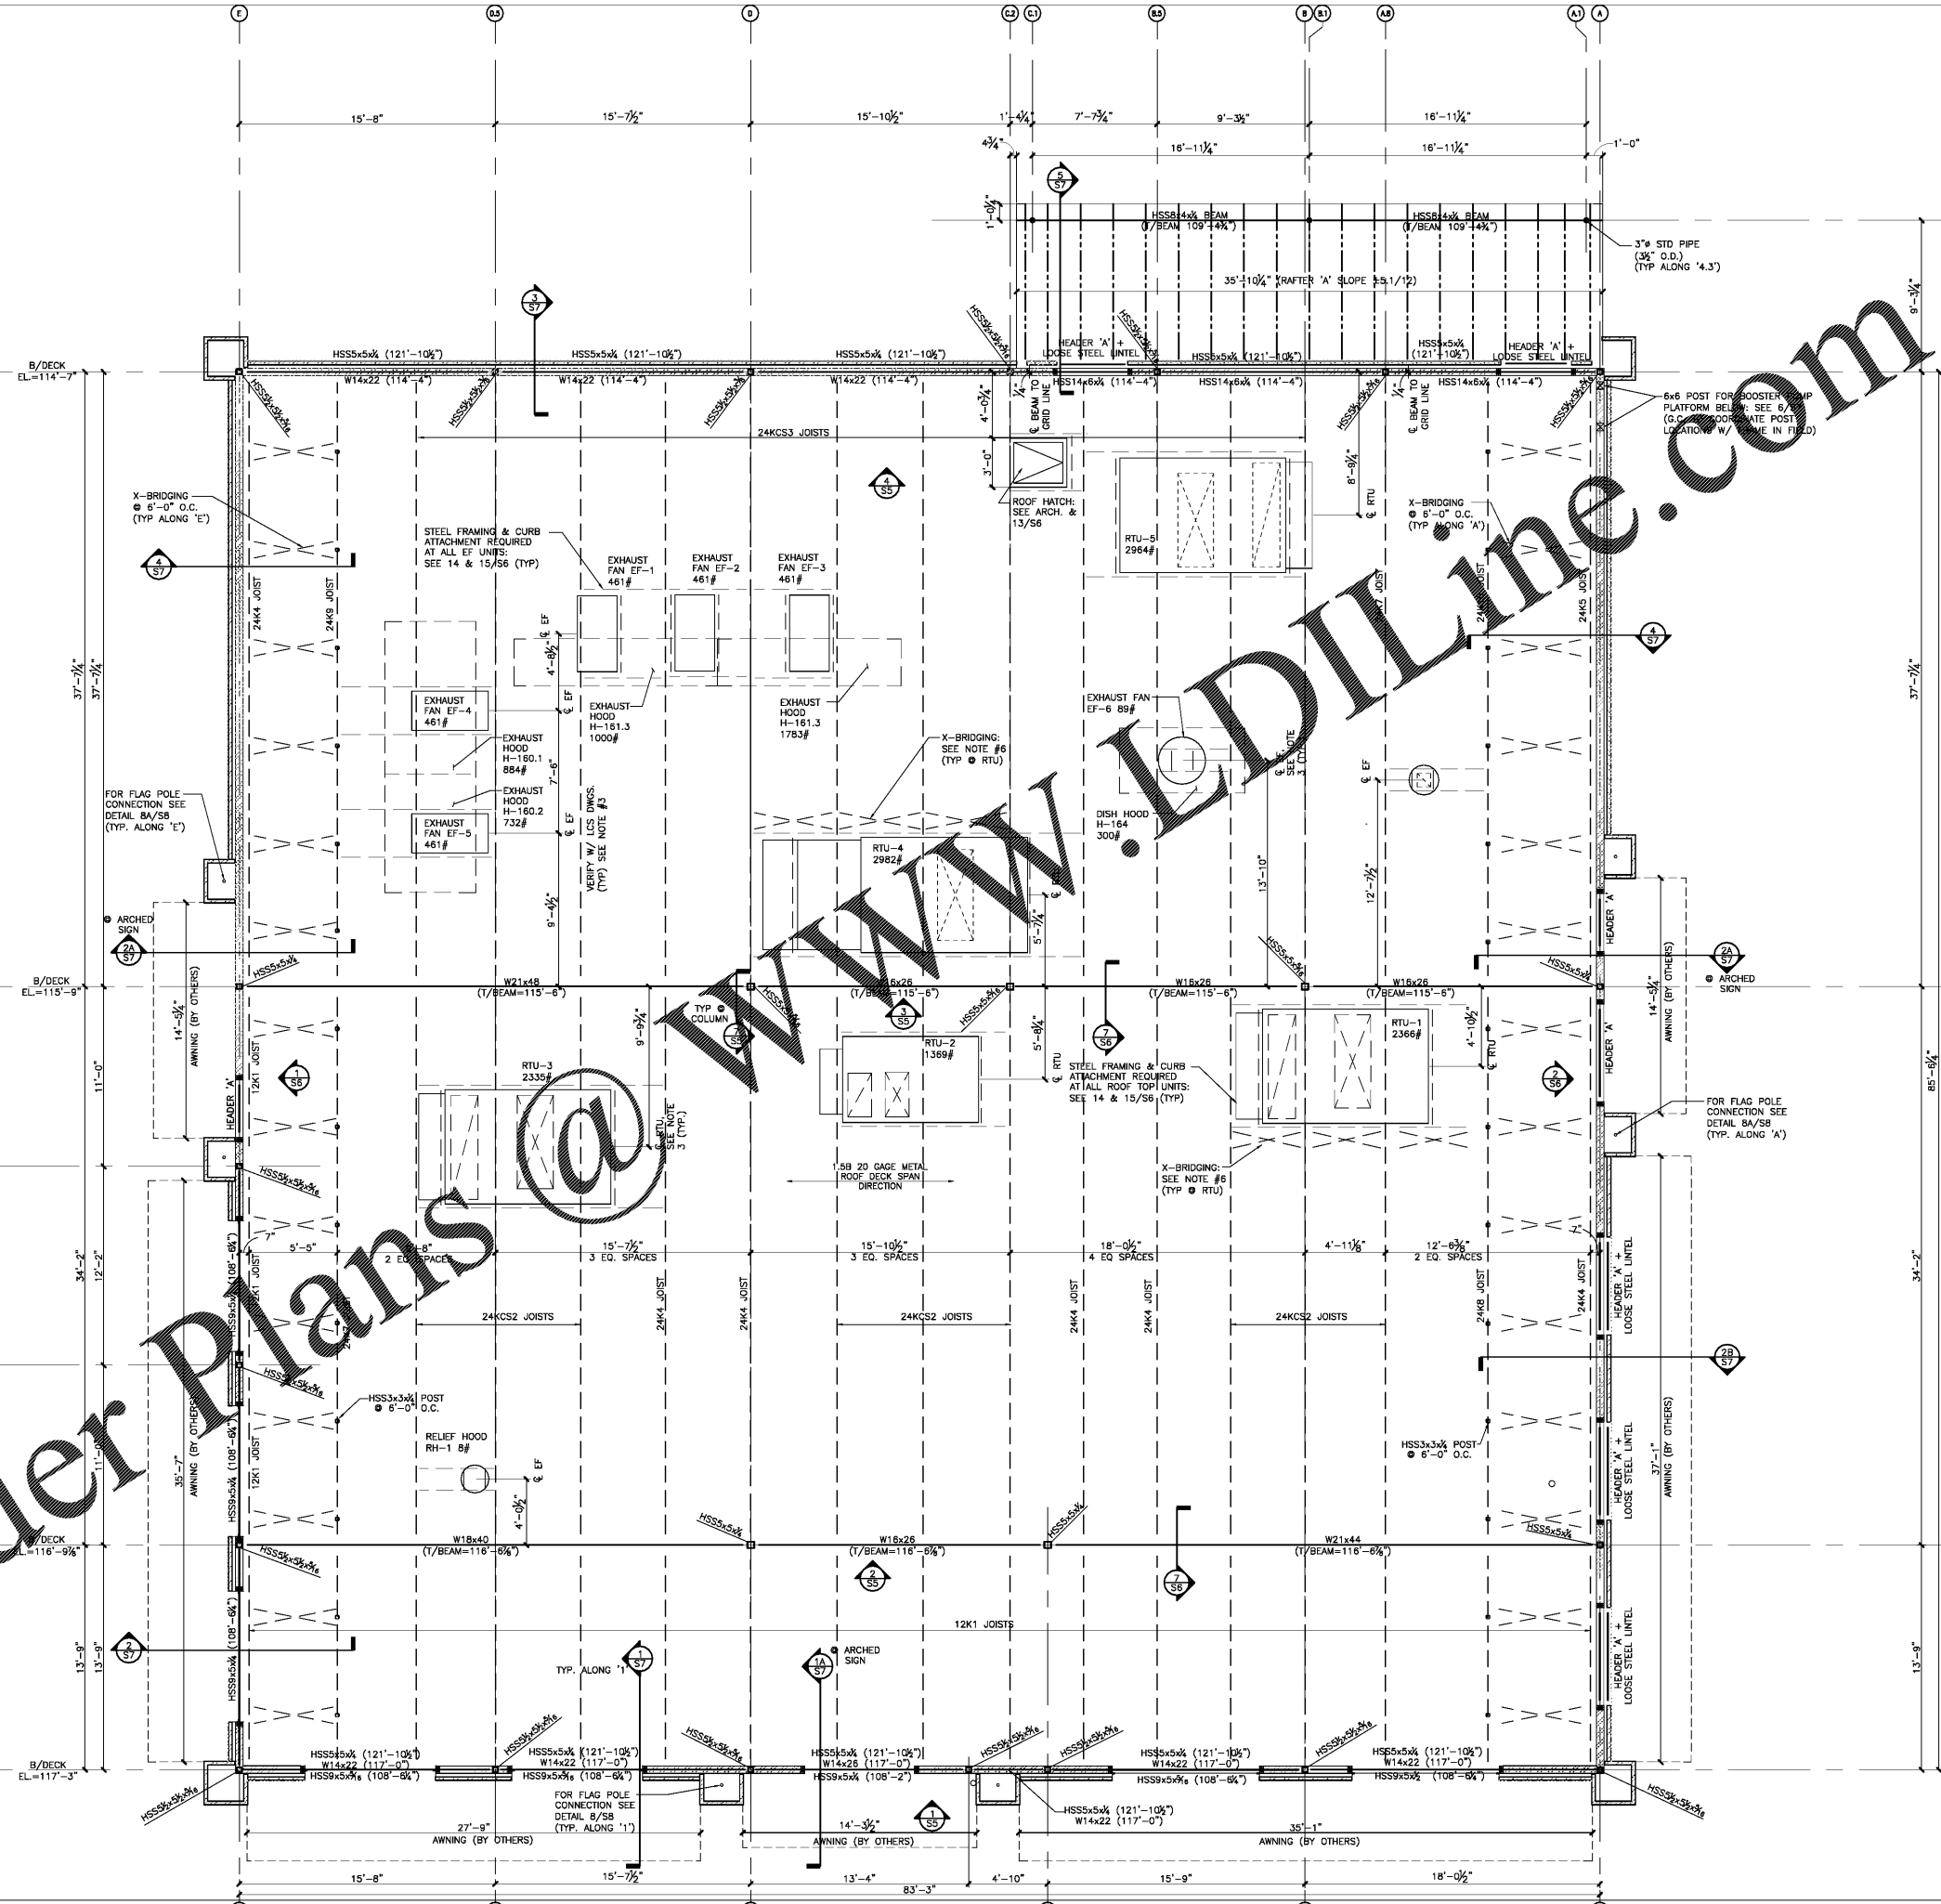
- SEE SHEET S1 FOR GENERAL NOTES & ADDITIONAL INFO.
- FOR WOOD FRAMED RAFTERS & HEADER INFO: SEE WOOD FRAMING SCHEDULE ON SHEET S3.
- THE SIZE & DIMENSIONS OF MECHANICAL EQUIPMENT (RTU's, EF, ETC.) SHALL BE VERIFIED WITH MECHANICAL & LCS DWGS. & SPECIFICATIONS.
- FOR RTU, MECHANICAL EQUIPMENT FRAMING DETAILS: SEE DETAILS 14 & 15/S6. (G.C. TO VERIFY & COORDINATE W/ MFCOR. IF ADDITIONAL REQUIREMENTS.)
- NET UPLIFT ON STEEL ROOF JOIST = 13 psf.
- JOIST BRIDGING SHALL BE PROVIDED IN ACCORDANCE WITH THE SJI SPECIFICATION. IF THE CROSS BRIDGING, HORIZONTAL BRIDGING OR/AND UPLIFT BRIDGING IS INTERRUPTED BY AN OBSTRUCTION, ADDITIONAL BRIDGING SHALL BE PLACED PER DIRECTION OF THE JOIST SUPPLIER.
- METAL ROOF DECK SHALL BE 36" WIDE 1 1/2" DEEP, 20 GAGE (PAINTED) TYPE B WIDE RIB ROOF DECK. DECK ATTACHMENT SHALL BE PER ROOF DIAPHRAGM SCHEDULE ON SHEET S5.
- FOR TYPICAL WOOD FRAMING DETAILS: SEE SHEET S7.
- FOR LOOSE STEEL LINTEL DETAIL: SEE 6/S8.

WOOD ROOF FRAMING SCHEDULE

MEMBER	SYP #2	DF #2
RAFTER 'A'	2x8 @ 24" O.C.	2x8 @ 24" O.C.
HEADER 'A'	3-2x10	3-2x10

NOTE: STRUCTURAL STEEL IS OWNER SUPPLIED.

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1 ROOF FRAMING PLAN
 SCALE: 1/4"=1'-0"

PROFESSIONAL SEAL

PROFESSIONAL IN CHARGE
 E. SCHWARTZ
PROJECT MANAGER
 M. HAS
QUALITY CONTROL
 M. HAS
DRAWN BY
 C. YLA

PROJECT NAME
BUBBA'S 33

GASTONIA
NORTH CAROLINA
 3287 E. FRANKLIN BLVD



PROJECT NUMBER
 20181046.0

SHEET TITLE
ROOF FRAMING PLAN

SHEET NUMBER
S3