


FOUNDATION LEGEND	
FOOTING OR FOUNDATION	
1ST LEVEL WALLS	
LOW WALLS	
COLUMN	

BASE PLATE SCHEDULE	
BP10	200X107 A36 STEEL PLATE, W/ (4) #9 ANCHOR BOLTS, EMBEDDED INTO CONC. W/ 5" SETBACK
BP100	12" X 12" X 1/2" A36 STEEL PLATE, W/ (4) ANCHOR BOLTS, EMBEDDED INTO CONC. W/ 5" SETBACK
BP1414	14" X 14" X 1/2" A36 STEEL PLATE, W/ (4) ANCHOR BOLTS, EMBEDDED INTO CONC. W/ 5" SETBACK

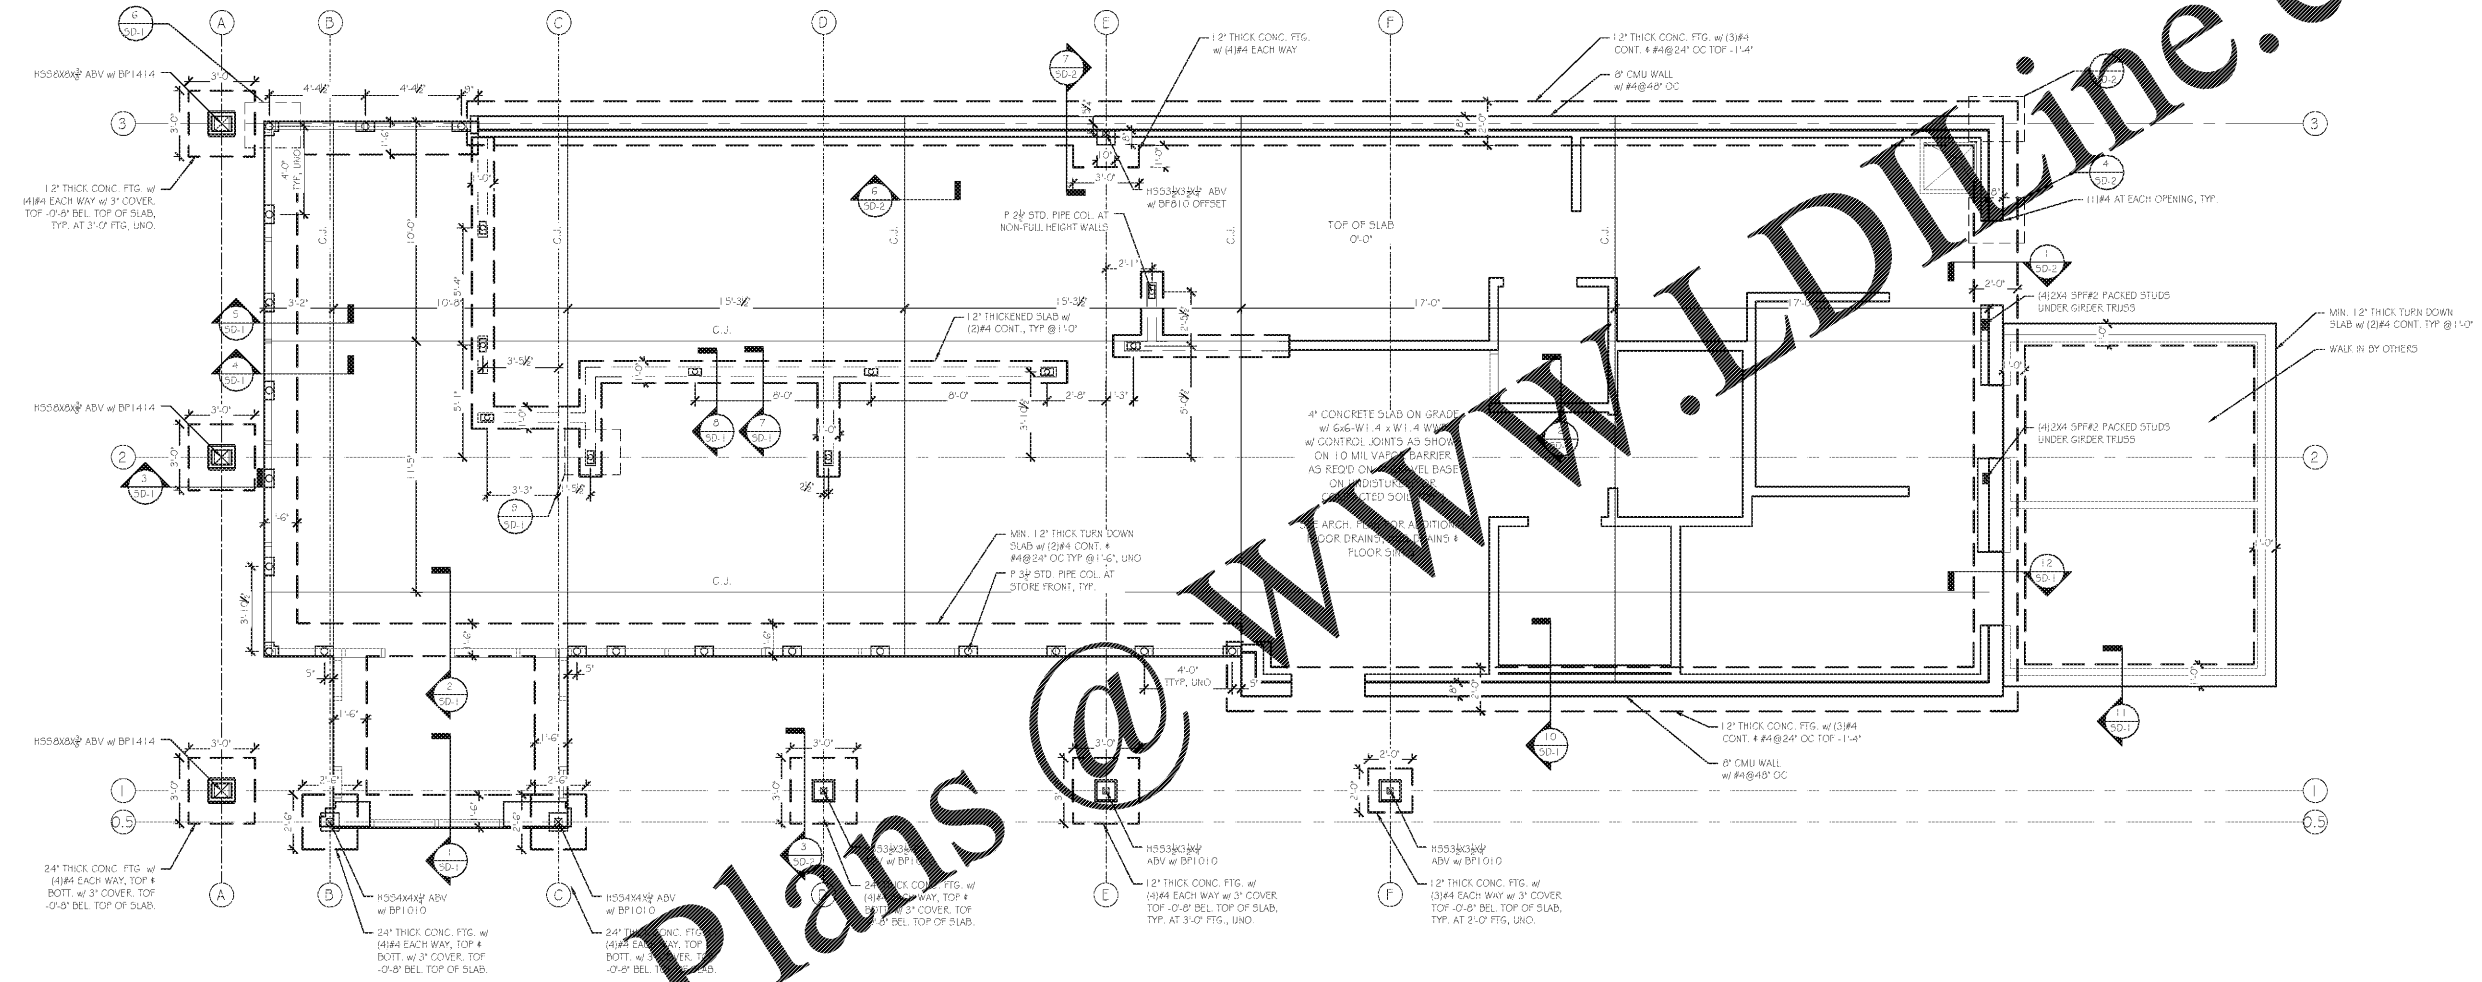

Order Plans

1 FOUNDATION PLAN
5-1 SCALE: 1/4" = 1'-0"

- FOUNDATION NOTES:**
- FOUNDATION DESIGNED BASED ON 2500 PSF ALLOWABLE SOIL BEARING CAPACITY PER GEOTECHNICAL REPORT. CONTRACTOR TO REVIEW GEOTECH REPORT.
 - SOLE/SILL PLATES TO BE ANCHORED TO THE FOUNDATION WITH #9 ANCHOR BOLTS @ A MAXIMUM OF 4'-0" OC. UNO. MINIMUM (2) BOLTS PER PLATE SECTION AND (1) BOLT WITHIN 12" FROM END OF PLATE SECTION. MINIMUM 6" EMBEDMENT INTO MASONRY OR CONCRETE.
 - SEE SHEET 5-0 FOR ADDITIONAL NOTES.
 - ALL DIMENSIONS LABELED ON PLAN ARE TO BE CONFIRMED BY ARCHITECT PRIOR TO CONSTRUCTION.
- RELEASED FOR CONSTRUCTION

KOBLASZ & KENNISON
ENGINEERING, P.C.
232 CREEKSTONE RIDGE WOODSTOCK, GA 30188
404 | 860 | 2600

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HUDDLE HOUSE
EVO 2000 RESTAURANT
40 US HWY 84 CAIRO, GA
GRADY CO. 39828

SUBMITTALS:	
DATE	DESCRIPTION
04-18-2019	STRUCTURAL DESIGN ISSUED

SHEET TITLE:
FOUNDATION PLAN

JOB NUMBER: 19102
ENGINEER: LHK
CHECKED BY: LHK



SHEET NUMBER:
S-1