


Order Plans @ www.LDOnline.com

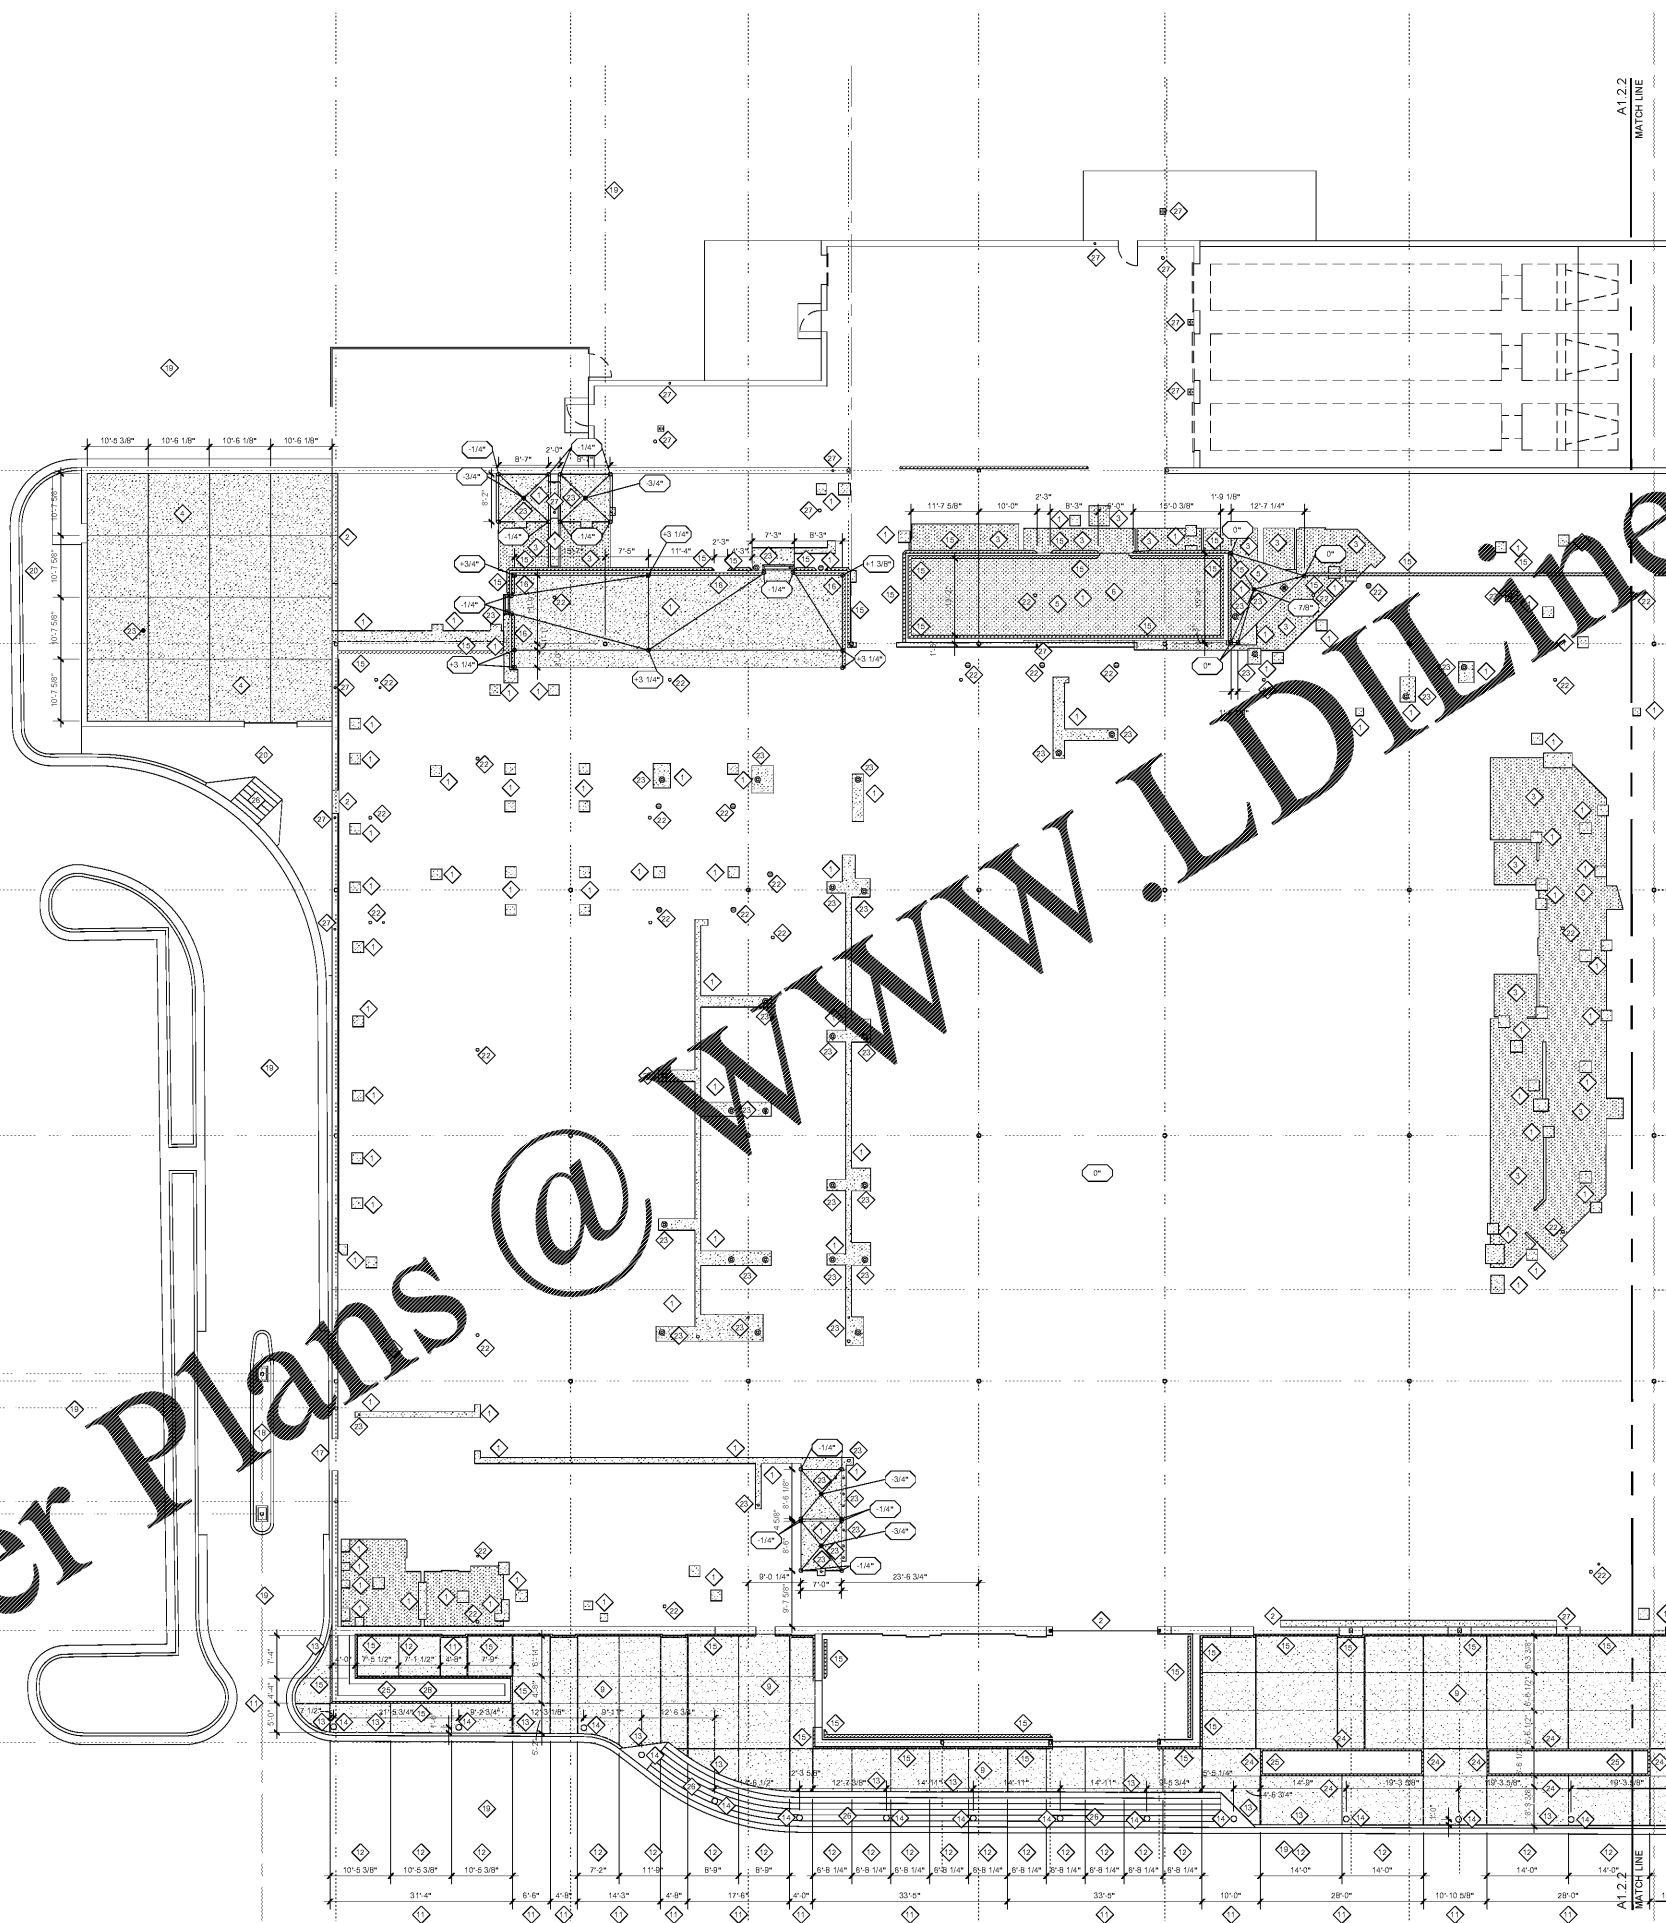

- LEGEND, SYMBOLS AND NOTES APPLY TO BOTH A1.2.1 AND A1.2.2 SHEETS, SOME ITEMS MAY NOT APPEAR ON THIS SHEET
- SYMBOL LEGEND**
- NEW CONCRETE CURB
 - CONCRETE ELEVATION
 - NEW SMOOTH FINISHED CONCRETE PATCH OR SLAB
 - NEW ANTI SLIP CONCRETE
 - NEW CONCRETE OVERLAY
 - NEW EQUIPMENT PAD
 - NEW EXTERIOR SIDEWALK
- NEW PLUMBING EQUIPMENT SEE PLUMBING DRAWINGS
- FLOOR DRAIN
 - HUB DRAIN
 - TRENCH DRAIN
 - FLOOR CLEAN OUT

- GENERAL NOTES**
1. SMOOTH FLOOR SLAB ELEVATION AT 0'-0".
 2. GENERAL CONTRACTOR SHALL BE RESPONSIBLE FOR THE COORDINATION OF ALL UNDERGROUND INSTALLATION WORK IN ORDER TO DETERMINE THE REQUIRED AMOUNT OF SAW CUTTING AND PATCHING. CONTRACTOR SHALL COORDINATE PLUMBING AND ELECTRICAL WORK IN A COMMON TRENCH, WHERE FEASIBLE. A PRECONSTRUCTION MEETING WITH ALL TRADES AND KROGER PROJECT MANAGER IS TO BE SCHEDULED BY THE GENERAL CONTRACTOR TO ENSURE COORDINATION OCCURS PRIOR TO THE COMMENCEMENT OF THE WORK.
 3. PATCH AND REPAIR ANY CHIPS OR HOLES IN EXISTING CONCRETE SLAB THAT ARE EXISTING TO REMAIN.
 4. BACK FILL ALL ABANDONED AND NEW TRENCHES, CORES, PENE TRATIONS AND UTILITIES WITH HIGH EARLY STRENGTH GRAY CONCRETE. OVERLAY AS NECESSARY TO PROVIDE A SMOOTH, CLEAN AND LEVEL FLOOR AREA FLUSH WITH THE NEW FLOOR FINISH.
 5. REPAIR DAMAGED CONTROL AND EXPANSION JOINTS IN AREAS OF WORK IN SALES FLOOR.
 6. SAWCUT BETWEEN EXISTING CONTROL JOINTS WHERE POSSIBLE. NEW JOINTS ARE TO BE CREATED IF LESS THAN 1/2" OF THE EXISTING JOINT IS TO BE REMOVED. MINIMUM DISTANCE BETWEEN JOINTS TO BE 10'-0".
 7. ALL EXISTING FLOOR PENE TRATIONS AND FLOOR UTILITIES IN AREAS THAT ARE TO BE POLISHED ARE TO BE CORED AND PATCHED OR LOWERED AS NECESSARY TO ALLOW THE COVER TO BE FLUSH WITH THE NEW FLOOR FINISH. PROVIDE A SMOOTH, CLEAN AND LEVEL FLOOR AREA AROUND EACH CORDED PENE TRATION AND UTILITY.
 8. ALL ABANDONED FLOOR PENE TRATIONS AND UTILITY TRENCHES ARE TO BE CAPPED AND SEALED BELOW THE FLOOR SLAB.
 9. WHEN BACKFILLING TRENCHES DO NOT MAKE A JOINT AT THE SAWCUT LINE. OVERLAY THE TRENCH SLAB AND GRIND DOWN THE EXCESS FLUSH WITH THE EXISTING SLAB.
 10. THE GENERAL CONTRACTOR IS TO PROVIDE A SEQUENCING PLAN FOR THE EXTERIOR CONCRETE POURS.
 11. GENERAL CONTRACTOR SHALL BE RESPONSIBLE FOR THE COORDINATION OF ALL UTILITIES PRIOR TO INSTALLATION OF SITE PAVING.
 12. REFER TO AS 1 SERIES FOR ARCHITECTURAL STANDARD DETAILS (ASDs) AND GENERAL INSTALLATION DETAILS (GIDs).

- KEYED NOTES**
1. NEW CONCRETE SLAB WHERE NEW TRENCHING AND OR DEMOLITION WAS REQUIRED FOR UNDERGROUND UTILITIES, STRUCTURAL CHAIR, ETC. PER ASD-60 BACKFILL AS REQUIRED BY INDUSTRY STANDARDS WITH HIGH EARLY STRENGTH CONCRETE.
 2. PATCH CONCRETE SLAB WHERE MASONRY WALL WAS REMOVED. PROVIDE A SMOOTH AND LEVEL TRANSITION TO MATCH EXISTING ADJACENT FLOORING.
 3. NEW HIGH STRENGTH CONCRETE OVERLAY TO BE FLUSH WITH ADJACENT FLOOR SLAB. OVERLAY TO BE POLISHED OR SEALED AS INDICATED.
 4. 4" SLAB ON GRADE WITH FIBER REINFORCING. PROVIDE CONTROL JOINTS IN NEW CONCRETE SLAB, EQUALLY SPACED JOINTS BE TWEEN EACH COLUMN BAY. REFER TO ASD-15 AND STRUCTURAL DRAWINGS.
 5. PROVIDE ANTI SLIP FINISH TO MATCH TEXTURE OF #120-150 GRIT SANDPAPER.
 6. INSTALL INSULATED SLAB UNDER THE EXPANDED FREEZER PER ASD-15A. INSTALL THE UNDER SLAB HEATING PER ELECTRICAL DRAWINGS.
 7. INSTALL NEW CONCRETE EQUIPMENT PROTECTION PAD. RE: ASD-22.
 8. TRANSFORMER PAD PER UTILITY REQUIREMENTS OR 2" THICK CONCRETE WITH 6X6 42 LB (W2.9 X W2.9) WELDED WIRE FABRIC WITH A NON-SLIP MEDIUM TO FINE BROOM FINISH ON 4" AGGREGATE BASE.
 9. 2" THICK CONCRETE WITH 6X6 42 LB (W2.9 X W2.9) WELDED WIRE FABRIC WITH A NON-SLIP MEDIUM TO FINE BROOM FINISH ON 4" AGGREGATE BASE.
 10. CUT 1/4" WIDE GROOVE FOR FLASHING PARALLEL TO THE BACK OF THE CASES PER GID-14.
 11. EXPANSION JOINT PER 03AA.4.1.4.
 12. CONTROL JOINT PER 03AA.4.1.4.
 13. PAVEMENT JOINT PER 03CA.4.1.4.
 14. DECORATIVE CONCRETE BOLLARD PER ASD-161.
 15. NEW CONCRETE CURB PER ASD-6.
 16. NEW CONCRETE CURB PER ASD-6A.
 17. NEW PHARMACY CONCRETE CURB PER ASD-6 AND CIVIL DRAWINGS.
 18. NEW CONCRETE ISLAND PER CIVIL DRAWINGS.
 19. REFER TO CIVIL DRAWINGS FOR DRIVE LANE AND PARKING PAVEMENT.
 20. REFER TO CIVIL DRAWINGS FOR GENERAL SIDEWALKS AND RAMPS.
 21. NEW GREASE INTERCEPTOR. SEE PLUMBING DRAWINGS. E
 22. EXISTING RAISED LOWERED PLUMBING CLEANOUT OR DRAIN PER AD-1.3 AND AD-1.4.
 23. NEW PLUMBING FIXTURE. RE: PLUMBING DRAWINGS.
 24. NEW ROLLUP CURB PER CSD-1(CS.2 IN THE CIVIL DRAWINGS).
 25. NEW LANDSCAPE BED RE: LANDSCAPE DRAWINGS.
 26. NEW SIDEWALK RAMP PER CIVIL DRAWINGS.
 27. EXISTING PLUMBING DRAIN OR VENT TO REMAIN.

KROGER
STORE #473

2013 UNIVERSITY AVENUE
OXFORD, MISSISSIPPI 38655

A DEVELOPMENT OF
THE KROGER COMPANY

naos
Naos Design
Group Of
Mississippi,
PLLC.

MARC BREETZ,
ARCHITECT

645 Lakeland East Drive
Suite 101
Flowood, Mississippi 39232
(p) 303.759.5777
(f) 720.360.4281

ARCHITECT OF RECORD

CDS
COMMERCIAL DESIGN SYSTEMS,
INC.

13225 SW GALBREATH DRIVE
SHERWOOD, OREGON 97140
503.855.7000 (P) 503.625.5902

INTERIOR DECOR

Pickering Firm, Inc.
Architecture - Engineering
Planning - Surveying

6775 Lenox Center Court, Suite 300
Memphis, TN 38115
901.726.0810

ENGINEER OF RECORD:
STRUCTURAL
MECHANICAL
ELECTRICAL
CIVIL ENGINEER

V-SOFT
INFRASTRUCTURE

1500 CHESTER ROAD
CINCINNATI, OH 45216
T: 513-670-3009

LOW VOLTAGE

telgian
TELGIAN CORPORATION
10230 SOUTH 50TH PLACE
SUITE 100
PHOENIX, AZ 85044
T: (677) 836-4426
HTTP://WWW.TELGIAN.COM
FIRE PROTECTION

ISSUE LOG


NO.	REV.	DESCRIPTION	DATE
1		PERMIT SET	12/05/18
2		BID SET	03/21/19

JOB: 2018041 SCALE: 3/32" = 1'-0"

SHEET NO. **A1.2.1**
PARTIAL CONCRETE PLACEMENT PLAN WEST

**PARTIAL CONCRETE
01 PLACEMENT PLAN WEST**

SCALE: 3/32" = 1'-0"

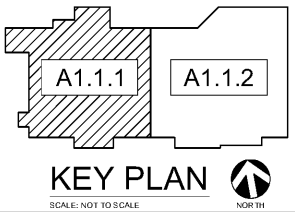

COPYRIGHT © 2018 KROGER DESIGN GROUP OF MISSISSIPPI, PLLC. THESE DRAWINGS OR PARTS THEREOF MAY NOT BE REPRODUCED, COPIED, EITHER WHOLLY OR IN PART, BY ANY MEANS, WITHOUT THE WRITTEN CONSENT OF KROGER DESIGN GROUP OF MISSISSIPPI, PLLC.