

LIGHTING PLAN CONSTRUCTION NOTES:

- 1. OCCUPANCY SENSOR SWITCHES IN SLEEPING ROOMS SHALL BE PLACED IN VACANCY MODE.
- 2. PROVIDE PHOTOCELL AND TIMECLOCK FOR CONTROL OF EXTERIOR FIXTURES.

LIGHTING PLAN KEYED NOTES:

- ① #10 AWG ENTIRE CIRCUIT. PROVIDE PHOTOCELL AND TIME CLOCK TO CONTROL TYPES J, K, AND M ON THIS CIRCUIT.
- ② PARALLEL OCCUPANCY SENSORS IN THIS ROOM.
- ③ CONTINUE CIRCUIT TO MEZZANINE LIGHTING.
- ④ PROVIDE EMERGENCY BACKUP INVERTER DUAL-LITE LED OR APPROVED EQUAL. LOCATE ON MEZZANINE. COORDINATE LOCATION WITH OWNER.

1980
Johnson, Labchober & Associates, P.C.
Augusta, GA • Mt. Pleasant, SC
Tel: (706) 724-5736 • Tel: (843) 619-4656
Fax: (706) 724-3935
www.thejlagroup.com

CLIENT: AUGUSTA, GA
535 TELFAIR STREET, AUGUSTA, GA 30901

PROJECT NAME: FIRE STATION #20

PROJECT LOCATION: 2820 OLD HIGHWAY 1, HEPHIZIBAH, GEORGIA 30815

REV	DATE	BY	DESCRIPTION
0	12/21/18	FAK	ISSUED FOR BID


PROJECT NO: 3042.1604
DRAWN BY: JAP/JFP
CHECKED BY: FAK
DATE: 8/10/18

SHEET TITLE: LIGHTING PLAN


SCALE: AS NOTED
DRAWING NO: E-101

REV: 0

This document is the property of Johnson, Labchober & Associates, P.C. The unauthorized reproduction, copying or otherwise use of this document is strictly prohibited and any infringement thereupon may be subject to legal action.

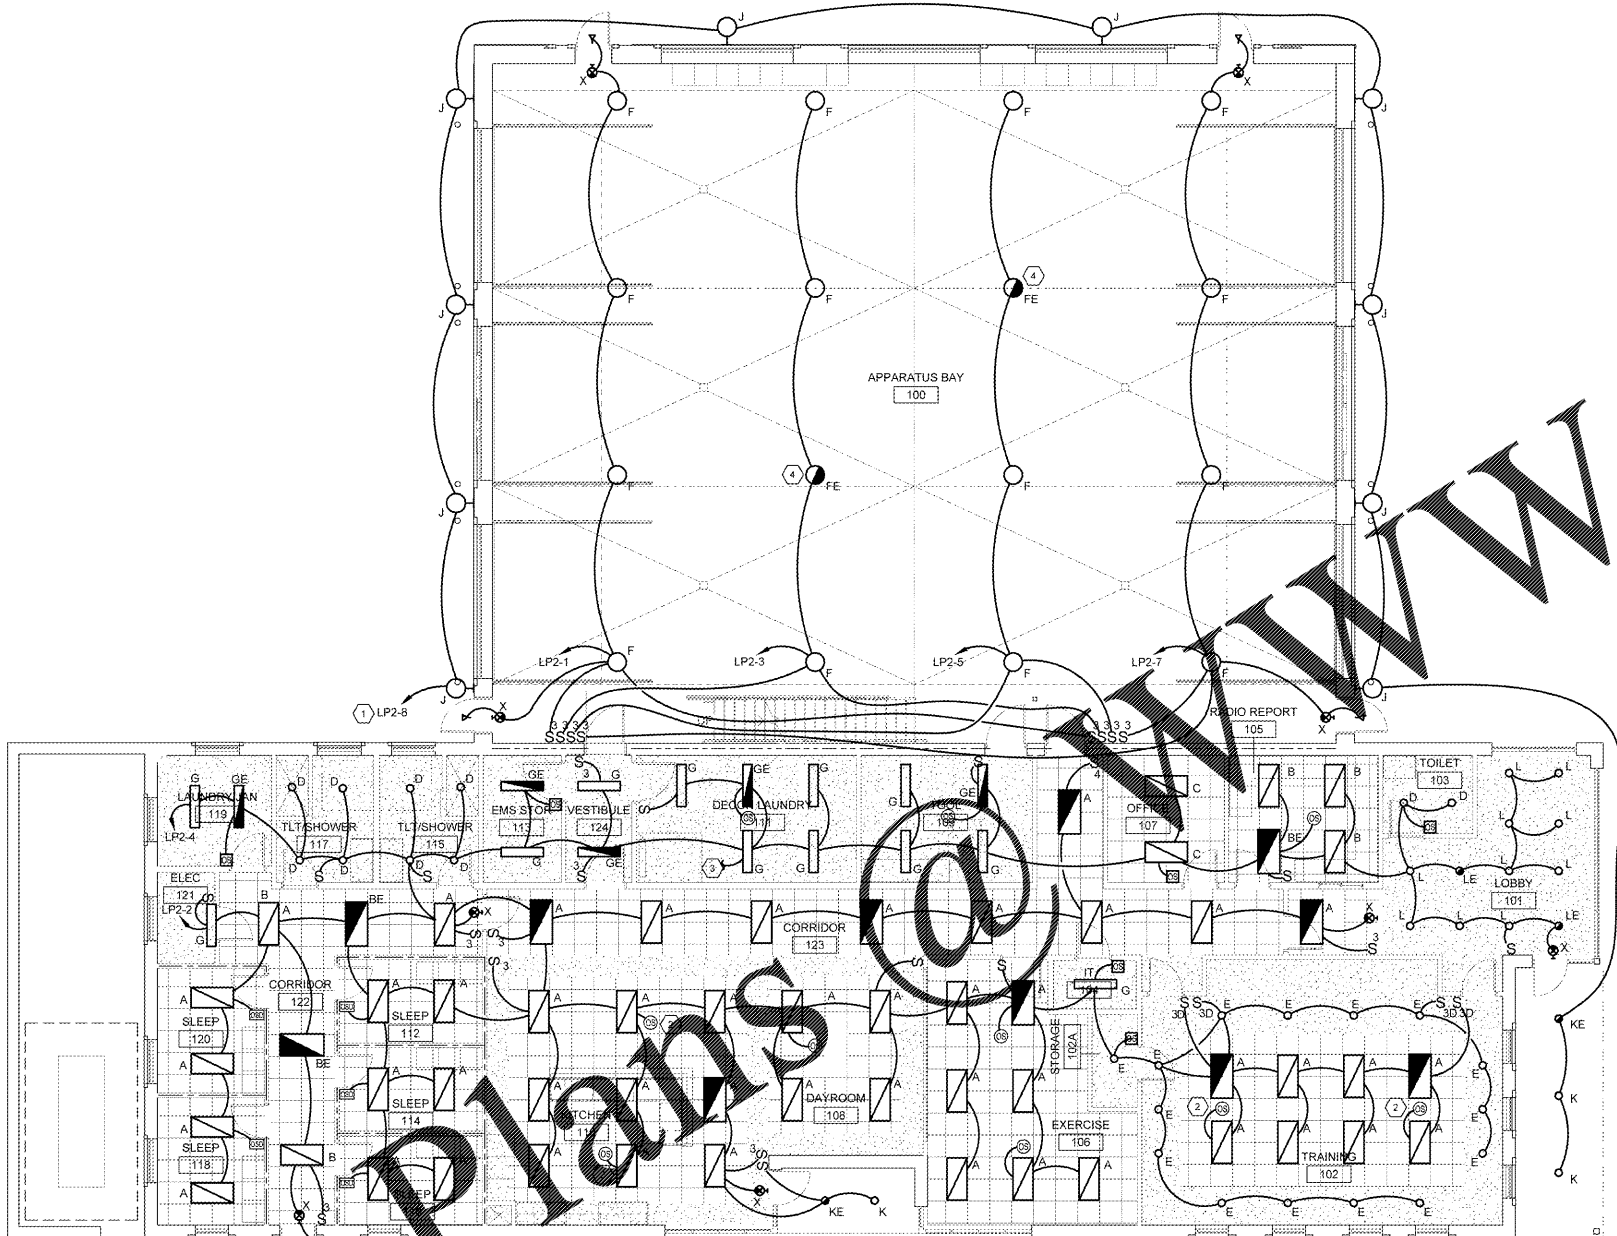

1 LIGHTING PLAN
E-101 SCALE: 1/8" = 1'-0"

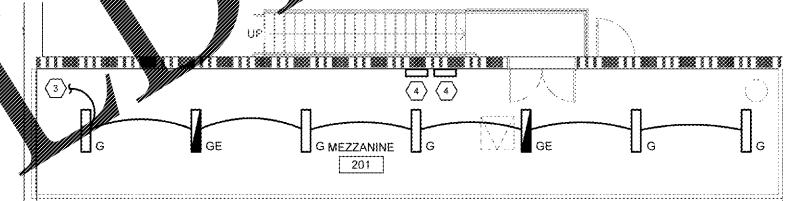

2 MEZZANINE LIGHTING PLAN
E-101 SCALE: 1/8" = 1'-0"

Order Plans

www.LDILine.com