


**ALTERNATE #1**  
 ROOF FRAMING FOR THE HIGH ROOF (APPARATUS BAY) TO BE LIGHT GAUGE METAL TRUSSES SPACED AT 4'-0" O.C.

**ALTERNATE #2**  
 STRUCTURAL METAL DECK AND RIGID INSULATION WILL BE REPLACED BY STRUCTURAL INSULATED PANELS (SIP) (R20ci). STANDING SEAM METAL ROOF WILL BE REPLACED WITH A 35 YEAR ARCHITECTURAL SHINGLE ROOF. THESE SUBSTITUTIONS ARE FOR BOTH THE HIGH AND THE LOW ROOF.

**ALTERNATE #3**  
 MEZZANINE FRAMING WILL CHANGE FROM AN ELEVATED SLAB SUPPORTED BY BAR JOISTS TO 12" LIGHT GAUGE JOISTS, SPACED AT 1'-0" O.C., WITH A DOUBLE LAYER OF 3/4" TONGUE AND GROOVE PLYWOOD.

1 ROOF FRAMING PLAN  
 SCALE: 1/8" = 1'-0"

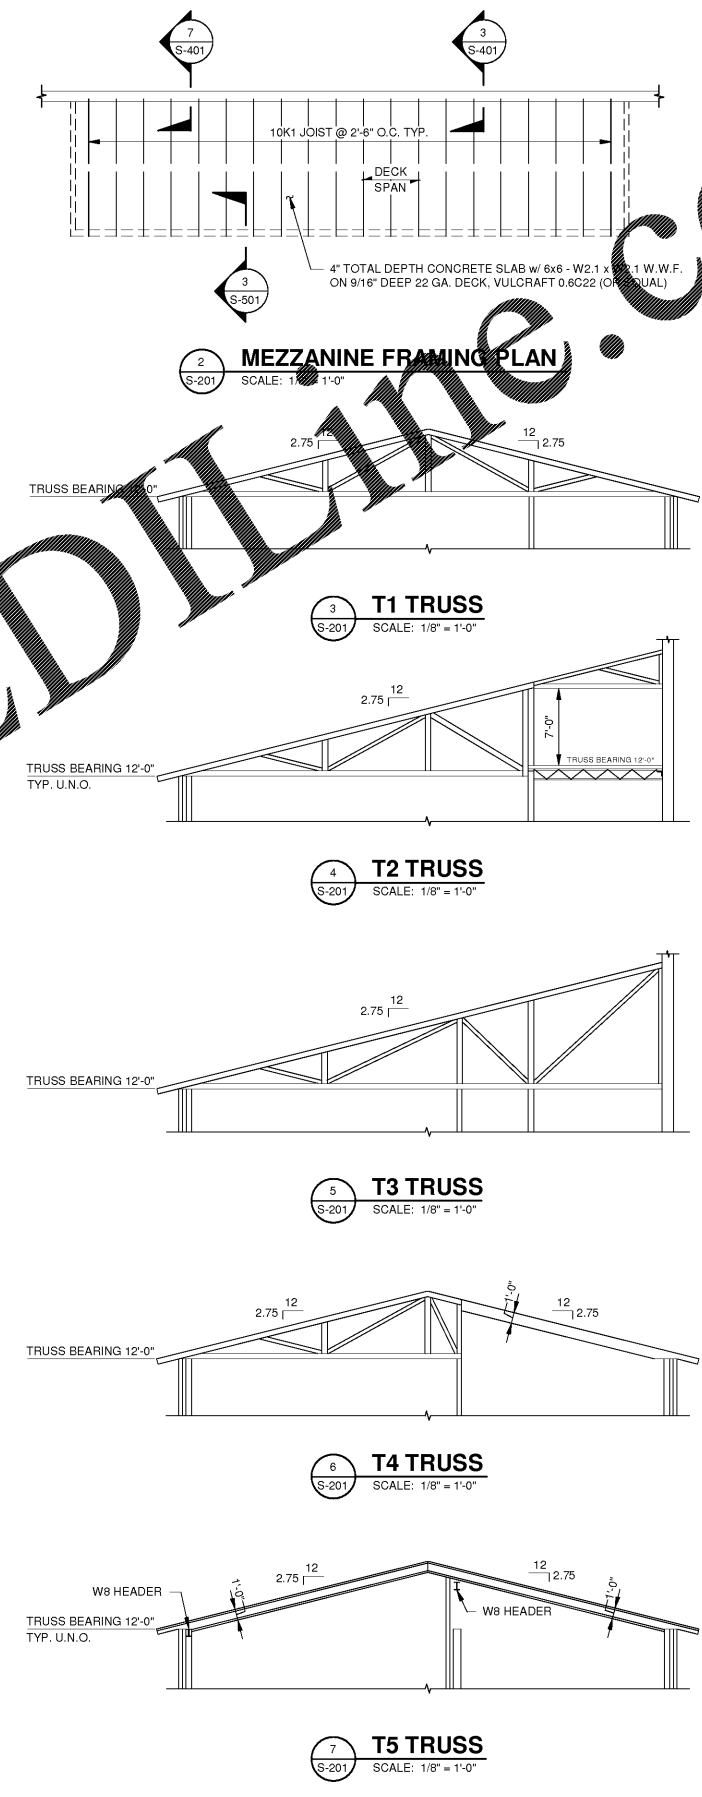

2 MEZZANINE FRAMING PLAN  
 SCALE: 1/8" = 1'-0"

3 T1 TRUSS  
 SCALE: 1/8" = 1'-0"

4 T2 TRUSS  
 SCALE: 1/8" = 1'-0"

5 T3 TRUSS  
 SCALE: 1/8" = 1'-0"

6 T4 TRUSS  
 SCALE: 1/8" = 1'-0"

7 T5 TRUSS  
 SCALE: 1/8" = 1'-0"

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PROJECT NAME: **FIRESTATION #3**

PROJECT LOCATION: 2649 GORDON HWY., AUGUSTA, GA 30909

| REV | DATE     | BY  | ISSUED FOR BID | DESCRIPTION |
|-----|----------|-----|----------------|-------------|
| 0   | 12/21/18 | MWL |                |             |

PROJECT NO. 3042.1604  
 DRAWN BY: CB  
 CHECKED BY: MWL  
 DATE: 10/08/18

SHEET TITLE:  
**ROOF FRAMING PLAN**

SCALE: AS NOTED

DRAWING NO. **S-201** REV. **0**

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