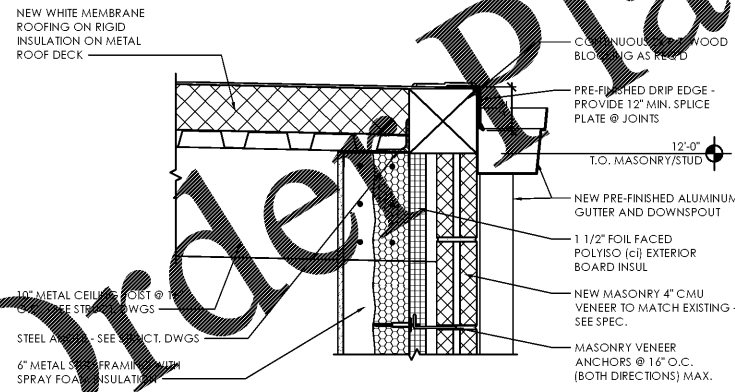
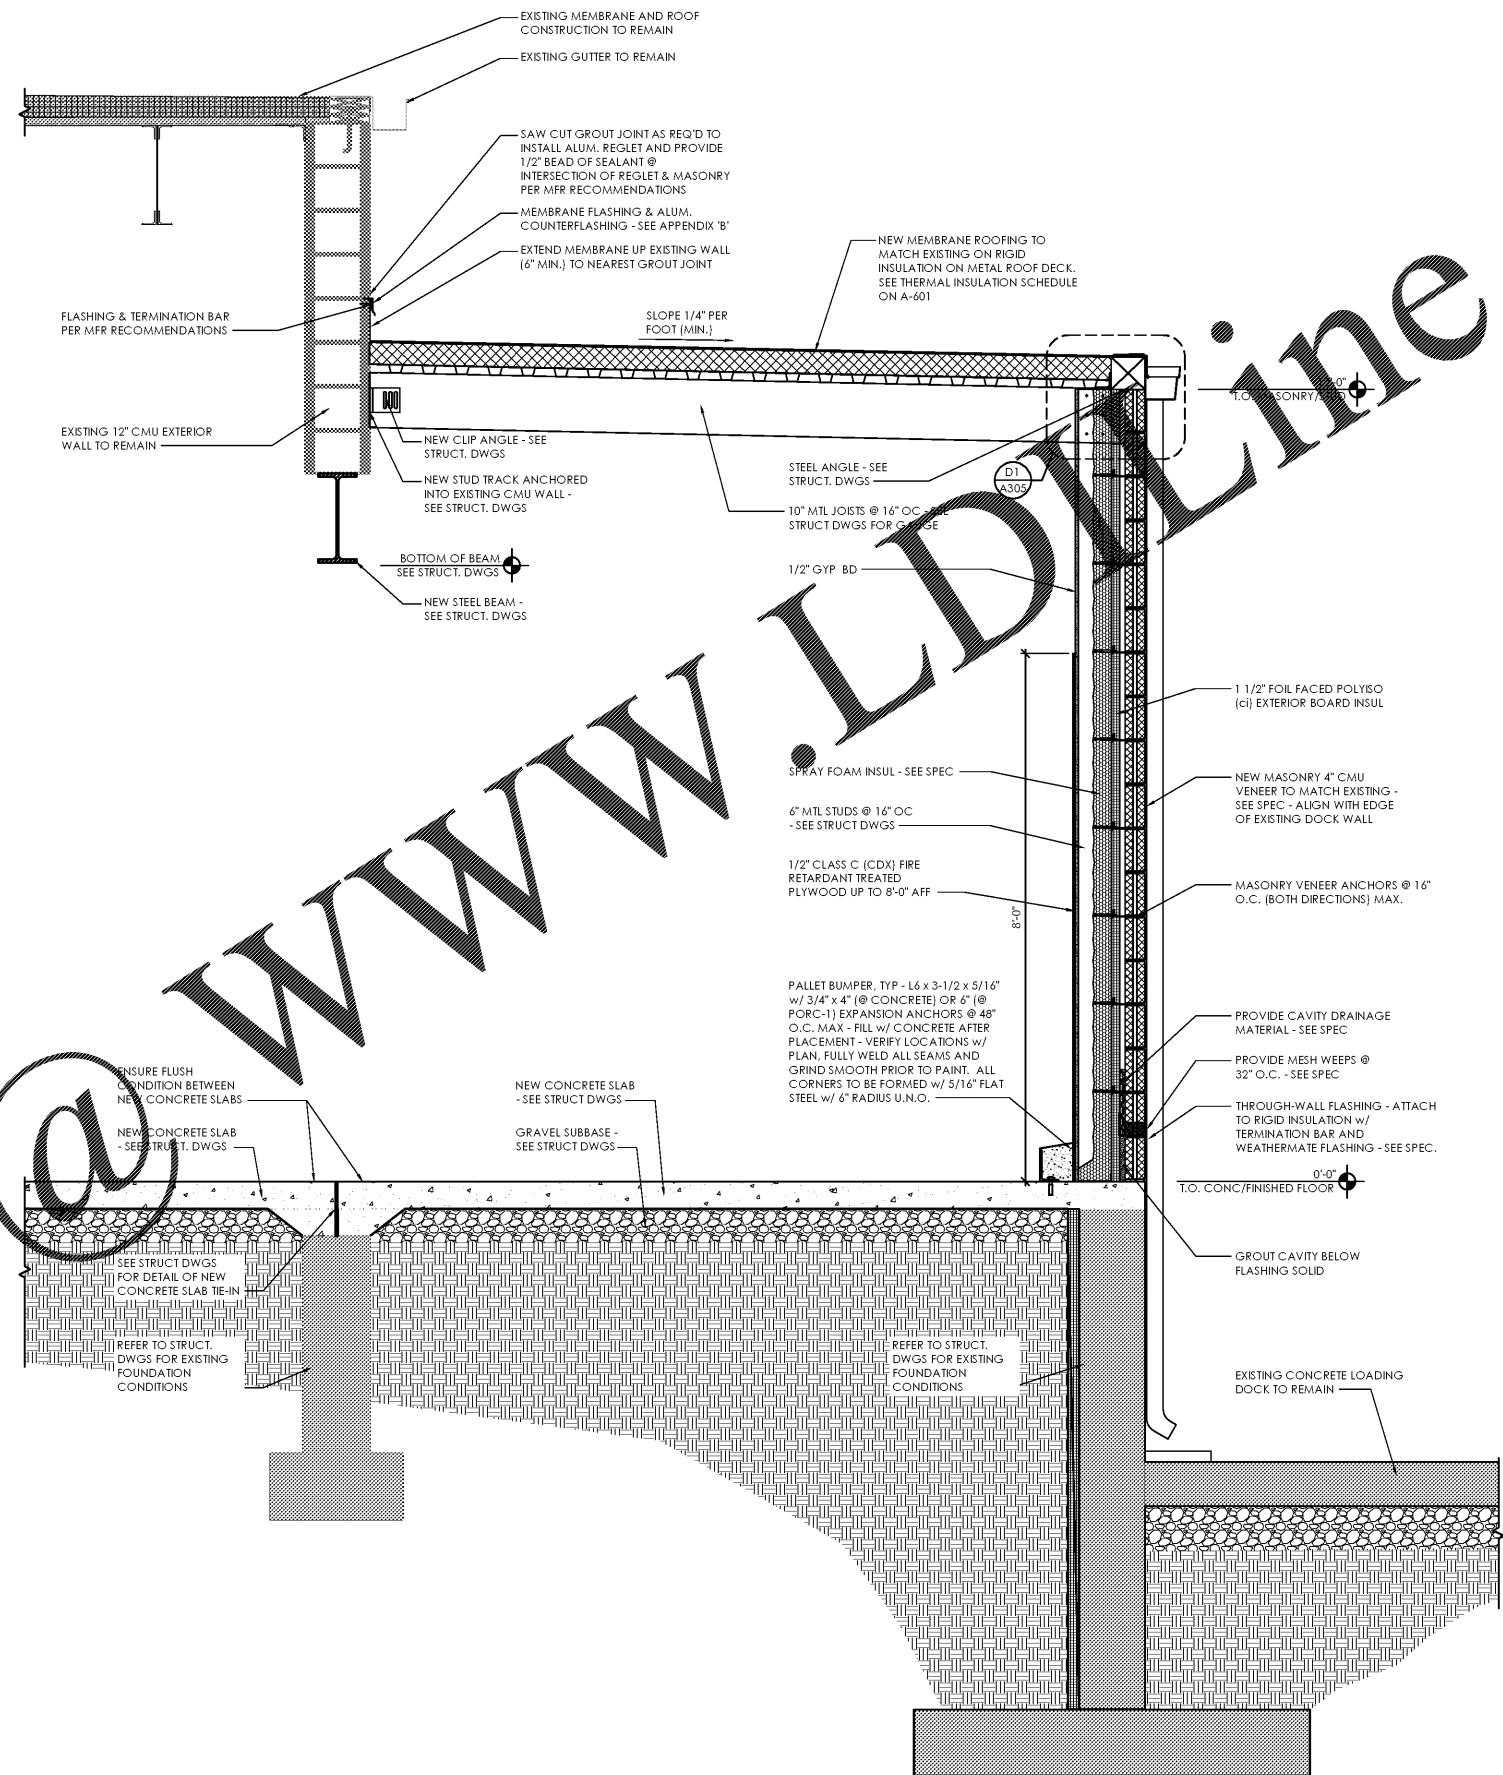


NOTE: ALL WOOD BLOCKING AND SHEATHINGS TO BE FRT PER TYPE IIB CONSTRUCTION

- NOTES:
- REFER TO SCHEDULES ON DRAWING A-603 FOR ALL FINISH AND INSULATION CALL-OUTS.
  - WRB TO BE SEALED AND TAPED PER MFR RECOMMENDATION. WRB TO WRAP INSIDE OPENINGS AND ALL JOINTS LAPPED PER MFR INSTALLATION REQMT.
  - PROTECT ALL EXTERIOR SHEATHING DURING CONSTRUCTION, AS REQUIRED BY MFR.
  - PROVIDE TRIM-TEX TEAR AWAY L-BEAD MOLDING (FINISHABLE EDGE) AT ALL EXPOSED GYPSUM BOARD EDGES (EXCEPT TOP OF WALLS AT ROOF IN THE BACK ROOM).
  - WRAP WEATHER RESISTIVE BARRIER (WRB) INTO ALL OPENINGS PER MFR'S INSTALLATION INSTRUCTIONS.
  - INSTALL COUNTER FLASHINGS AT BASE OF WALLS OVER SELF-ADHERING FLASHING EXTENDING TO FOUNDATION WALL. LAP WRB OVER COUNTERFLASHING TYP.
  - ATTACH PLYWOOD WALL SHEATHING & CONTINUOUS INSULATION PANELS TO METAL STUD FRAMING, USING FASTENERS AND PATTERN SUFFICIENT TO ACCOMMODATE 4LB/SF DEAD LOAD OF THE FIBER CEMENT WALL PANEL SYSTEM AND THE DESIGN PRESSURES INDICATED ON S-001.
  - PROVIDE VAPOR RETARDER ON THE INTERIOR OF SIDE EXTERIOR METAL STUD WALLS BEHIND THE GYP BD IN ZONES 5, 6, 7, 8 AND MARINE 4.



Exterior Section Detail - Roof Edge at Loading Dock

D1 SCALE: 1 1/2" = 1'-0"

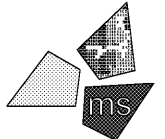
Wall Section - Loading Dock

A1 SCALE: 3/4" = 1'-0"

Issued:	Date:
A Client Review Set	02/15/19
B Bid Set	03/08/19
C	
D	
Revisions:	Date:
1	
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Wall Sections	
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Prototype Rls.	Project No.
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	A-305
Scale: As Noted	Drawing No.