


Issued:	Date:
A Client Review Set	02/15/19
B Bid Set	03/08/19
C	
D	

Revisions:	Date:
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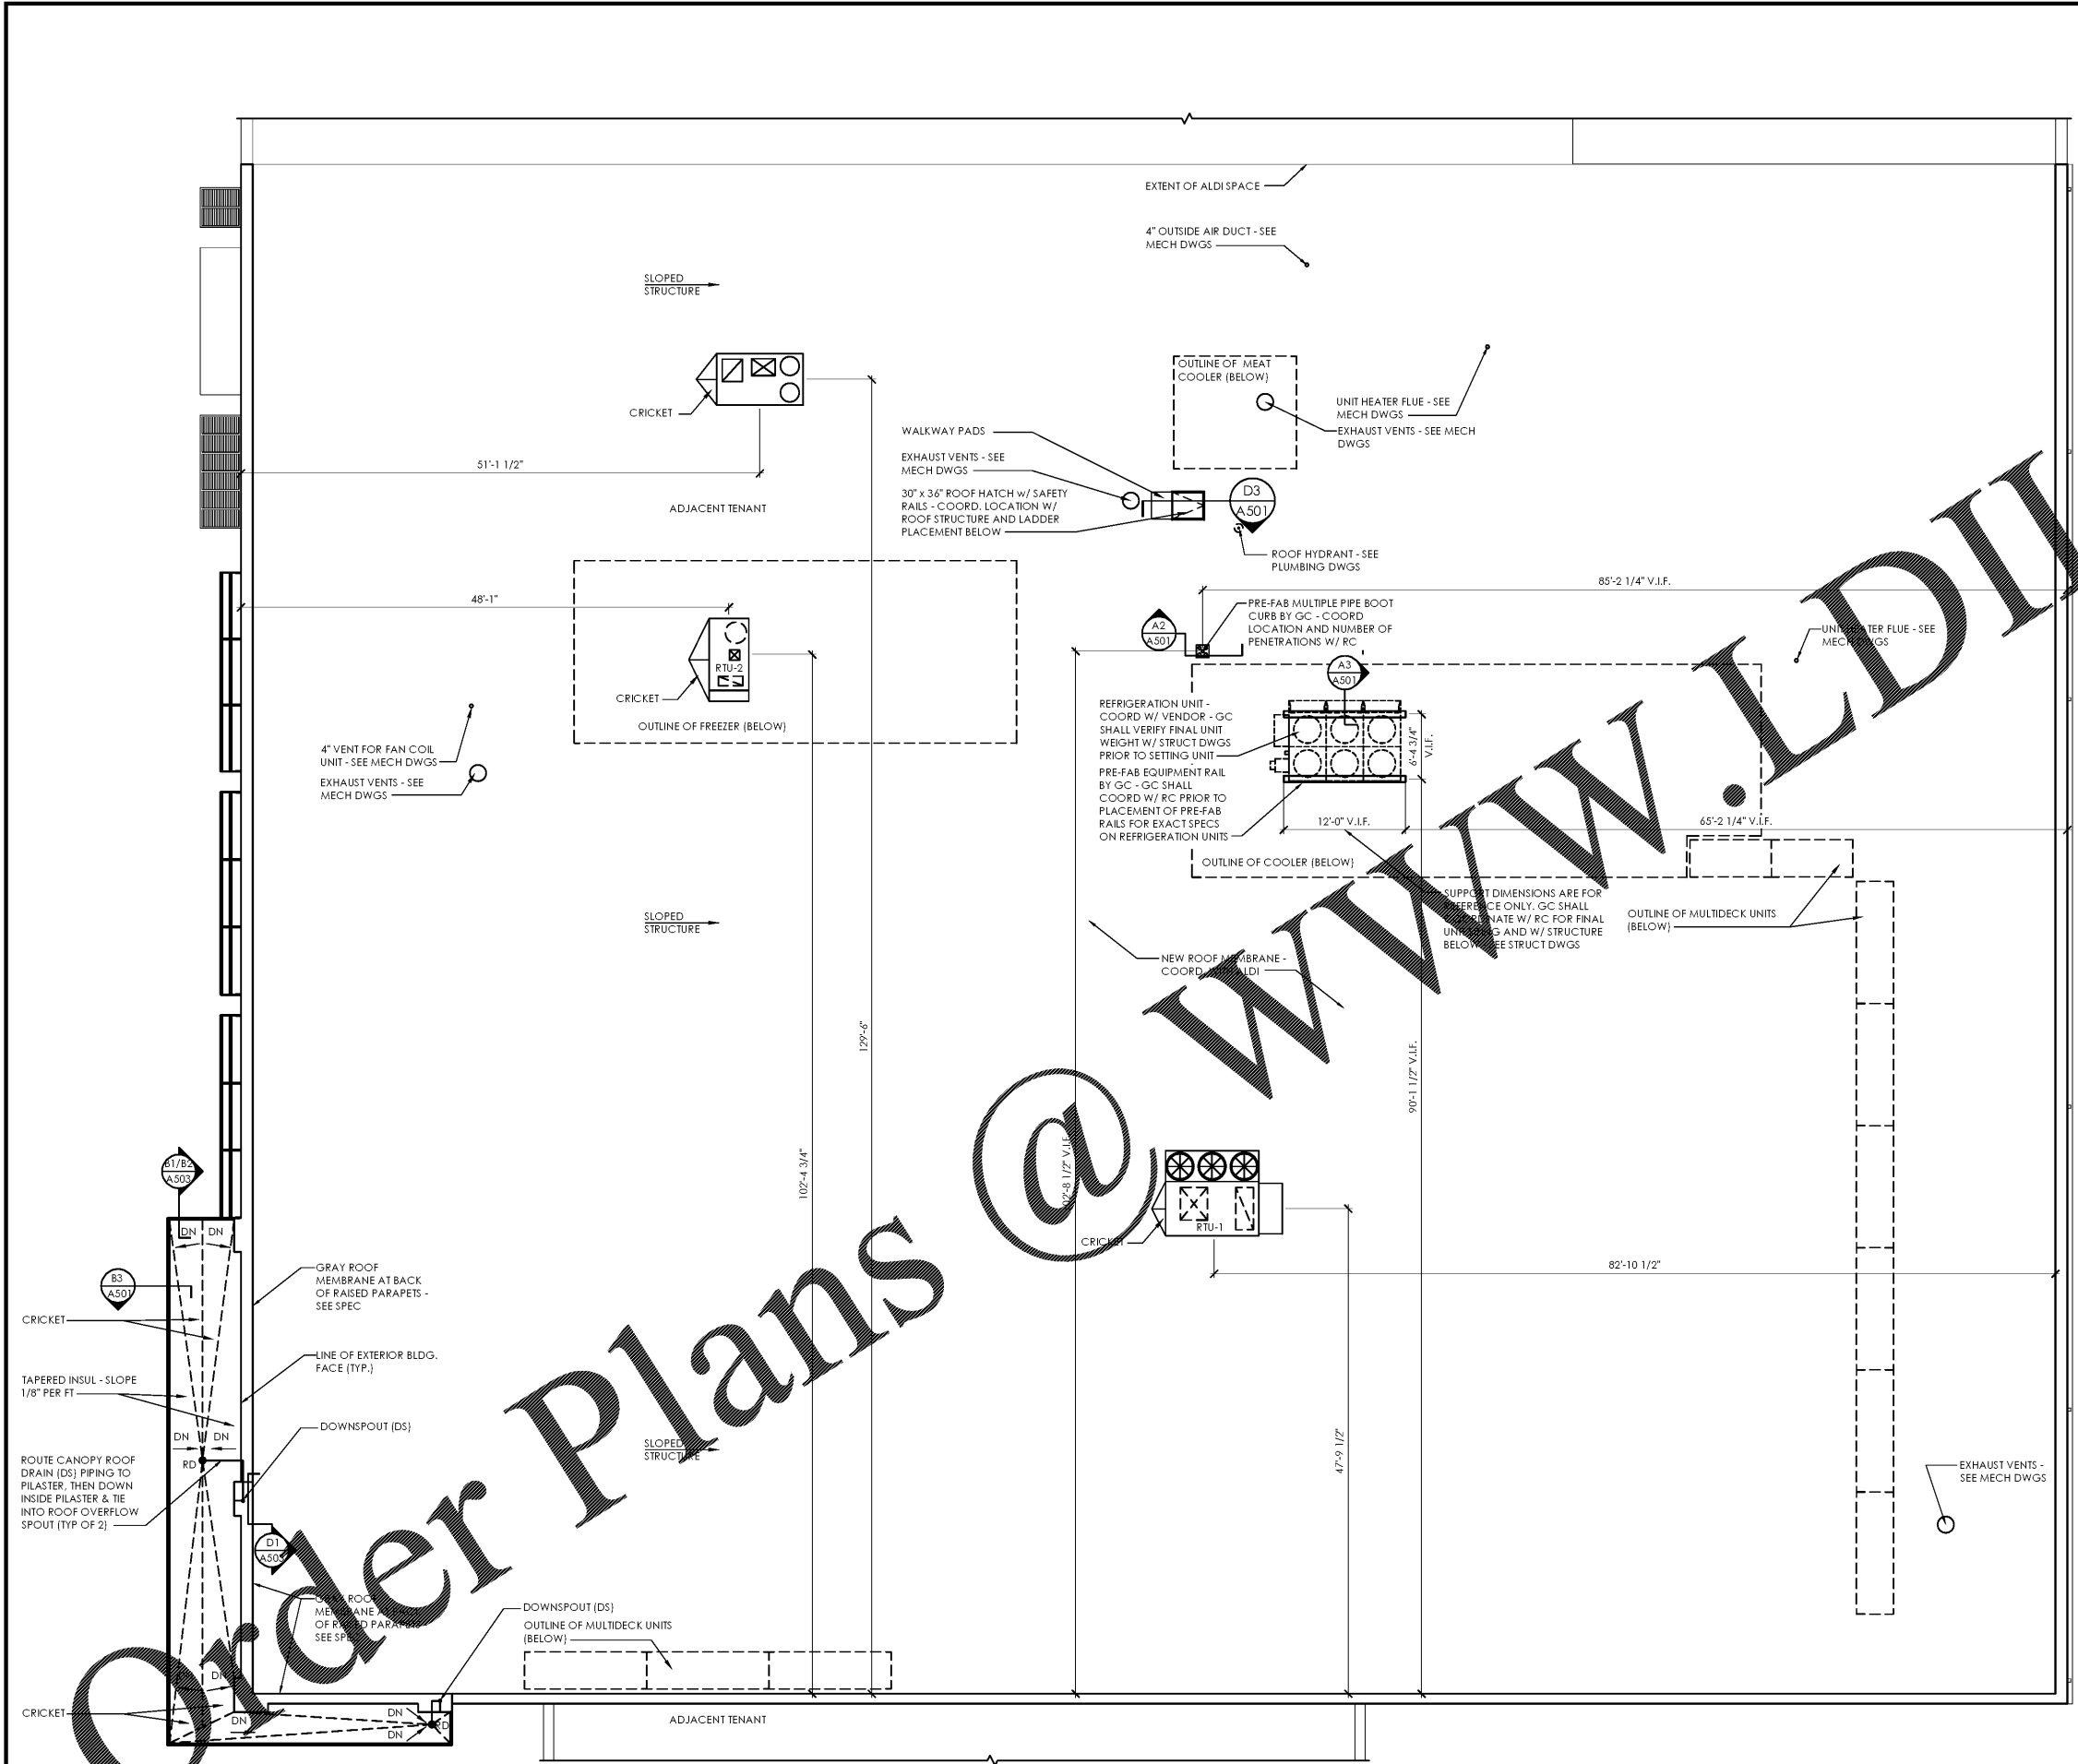
Seal

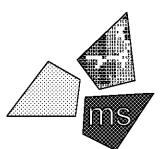

ALDI Inc. Store #: 59  
 Cary, NC  
 1315 Kildaire Farm Rd  
 Cary, NC 27511  
 Wake County  
 Project Name & Location:

Roof Plan	
Drawing Name:	Prototype Rls. Project No.
	40452-25
Type: V7.1	A-121
Scale: As Noted	Drawing No.

- NO. 1. ROOFTOP EQUIPMENT, SCUPPER AND ROOF DRAIN LOCATION DIMENSIONS REFER TO EXTERIOR FACE OF MASONRY @ FINISHED FLOOR.
2. G.C. SHALL SUPPLY ALL NECESSARY BLOCKING, NAILERS, MISC. LUMBER, AND FASTENERS FOR ROOF TOP INSTALLATIONS TO ENSURE ITEMS ARE PLUMB, LEVEL AND SECURED AS RECOMMENDED BY ITEMS MANUFACTURER.
3. ROOF SYSTEM PERFORMANCE REQUIREMENTS
- A. ACCELERATED WEATHERING: ROOFING SYSTEM SHALL WITHSTAND 2000 HOURS OF EXPOSURE WHEN TESTED ACCORDING TO ASTM G 152, ASTM G 154, OR ASTM G 155.
  - B. IMPACT RESISTANCE: ROOFING SYSTEM SHALL RESIST IMPACT DAMAGE WHEN TESTED ACCORDING TO ASTM D 3746 OR ASTM D 4272.
  - C. ROOFING SYSTEM DESIGN: TESTED BY A QUALIFIED TESTING AGENCY TO RESIST THE FOLLOWING COMPONENT & CLADDING PRESSURES INDICATED ON SHEET S-001 FOR THE FOLLOWING:
    - 1.1. CORNER UPLIFT PRESSURE
    - 1.2. PERIMETER UPLIFT PRESSURE
    - 1.3. FIELD-OF-ROOF UPLIFT PRESSURE
4. ROOF MEMBRANE COLORS:  
 GRAY - BACK OF ALL RAISED PARAPETS, HIGH TOWER ROOF (FIELD & FLASHING), CANOPY ROOF (FIELD & FLASHING), AND ALL OTHER VERTICAL FLASHING  
 WHITE - MAIN ROOF FIELD



1 Roof Plan  
 SCALE: 3/32" = 1'-0"



Plot Date: 3/7/2019