


Drawing name: L1237002 - Mullis Properties, LLC - Bojangles - Stockbridge, GA CADDDCONSTR1237002 - 03 - EASC-6wg EROSION CONTROL PHASE 3 - Sep. 28, 2018 10:22am by: frank subbanks

Order Plans @

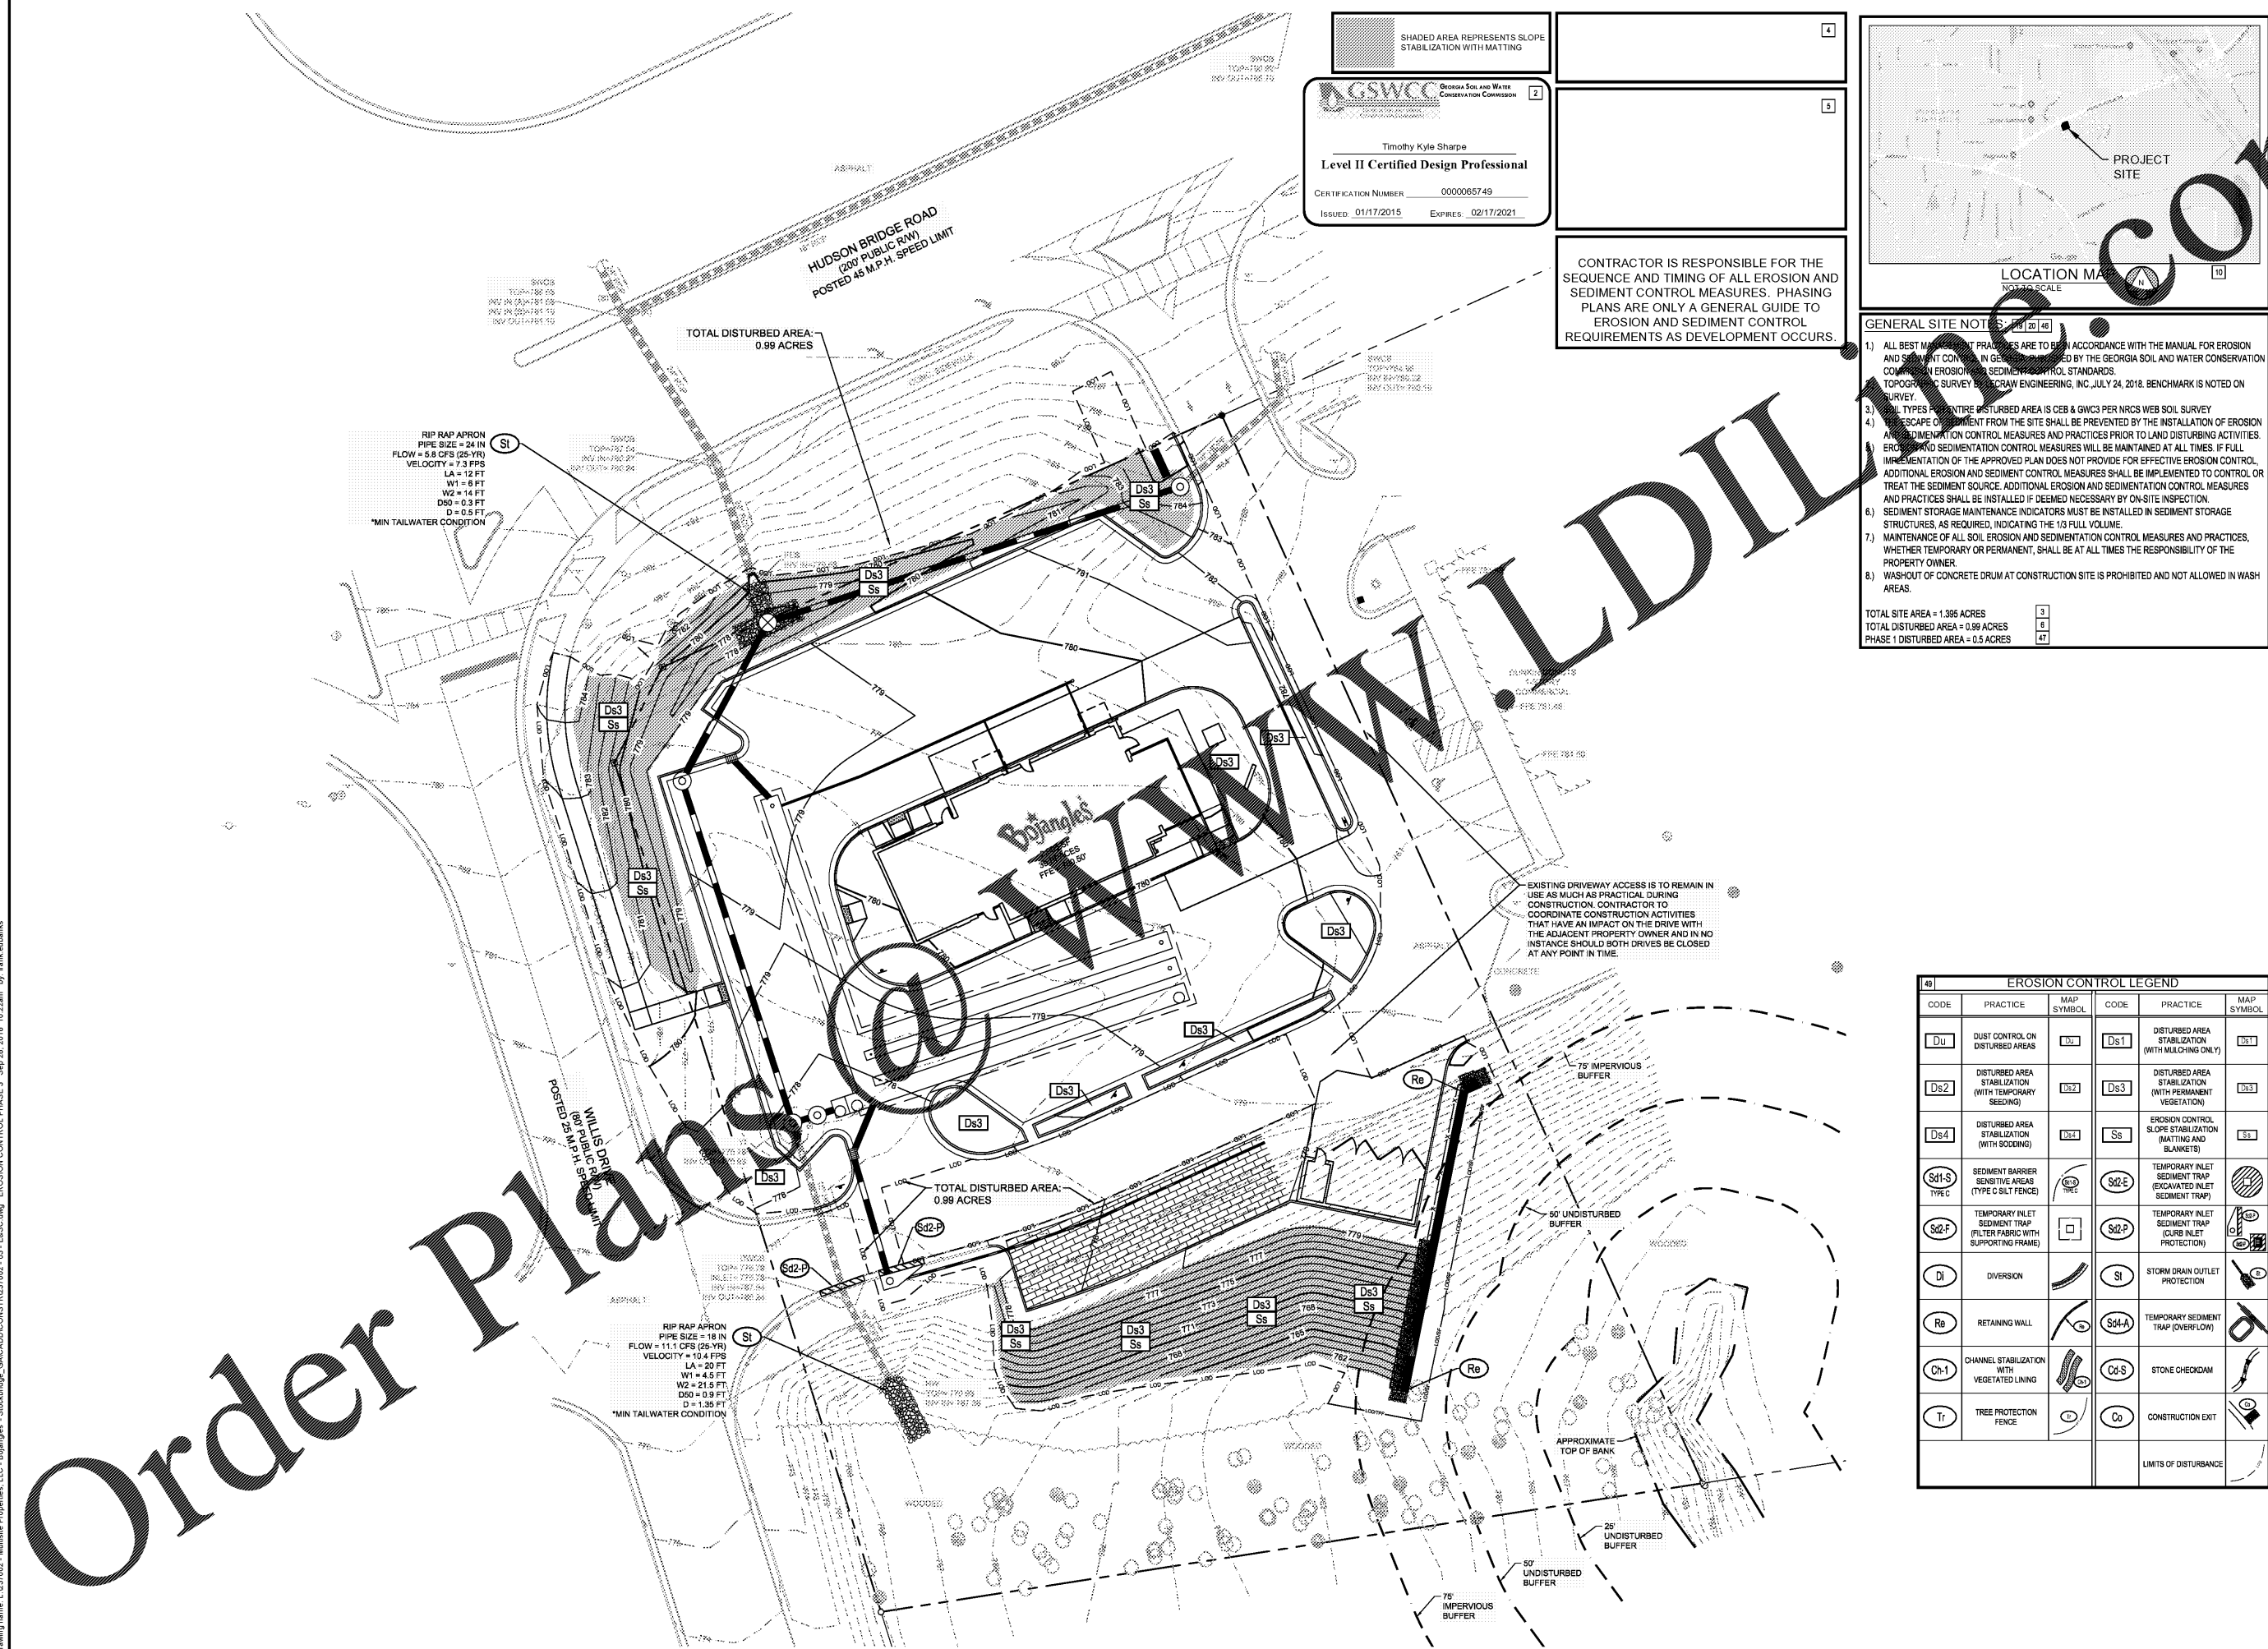


GSWCC Georgia Soil and Water Conservation Commission

Timothy Kyle Sharpe
Level II Certified Design Professional

CERTIFICATION NUMBER: 0000065749
ISSUED: 01/17/2015 EXPIRES: 02/17/2021

CONTRACTOR IS RESPONSIBLE FOR THE SEQUENCE AND TIMING OF ALL EROSION AND SEDIMENT CONTROL MEASURES. PHASING PLANS ARE ONLY A GENERAL GUIDE TO EROSION AND SEDIMENT CONTROL REQUIREMENTS AS DEVELOPMENT OCCURS.

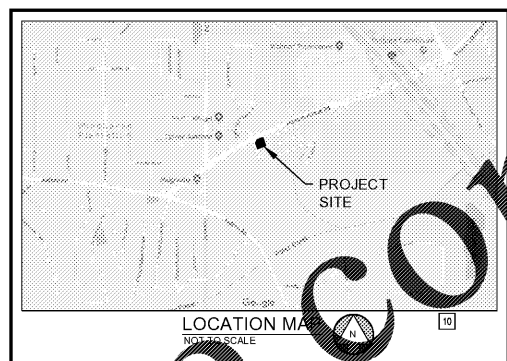

- GENERAL SITE NOTES:**
- ALL BEST MANAGEMENT PRACTICES ARE TO BE IN ACCORDANCE WITH THE MANUAL FOR EROSION AND SEDIMENT CONTROL AS REQUIRED BY THE GEORGIA SOIL AND WATER CONSERVATION COMMISSION EROSION AND SEDIMENT CONTROL STANDARDS.
 - TOPOGRAPHY SURVEY BY LEICRAW ENGINEERING, INC. JULY 24, 2018. BENCHMARK IS NOTED ON SURVEY.
 - SOIL TYPES FOR ENTIRE DISTURBED AREA IS CEB & GWCS PER NRCS WEB SOIL SURVEY.
 - THE ESCAPE OF SEDIMENT FROM THE SITE SHALL BE PREVENTED BY THE INSTALLATION OF EROSION AND SEDIMENTATION CONTROL MEASURES AND PRACTICES PRIOR TO LAND DISTURBING ACTIVITIES. EROSION AND SEDIMENTATION CONTROL MEASURES WILL BE MAINTAINED AT ALL TIMES. IF FULL IMPLEMENTATION OF THE APPROVED PLAN DOES NOT PROVIDE FOR EFFECTIVE EROSION CONTROL, ADDITIONAL EROSION AND SEDIMENTATION CONTROL MEASURES SHALL BE IMPLEMENTED TO CONTROL OR TREAT THE SEDIMENT SOURCE. ADDITIONAL EROSION AND SEDIMENTATION CONTROL MEASURES AND PRACTICES SHALL BE INSTALLED IF DEEMED NECESSARY BY ON-SITE INSPECTION.
 - SEDIMENT STORAGE MAINTENANCE INDICATORS MUST BE INSTALLED IN SEDIMENT STORAGE STRUCTURES, AS REQUIRED, INDICATING THE 1/3 FULL VOLUME.
 - MAINTENANCE OF ALL SOIL EROSION AND SEDIMENTATION CONTROL MEASURES AND PRACTICES, WHETHER TEMPORARY OR PERMANENT, SHALL BE AT ALL TIMES THE RESPONSIBILITY OF THE PROPERTY OWNER.
 - WASH-OUT OF CONCRETE DRUM AT CONSTRUCTION SITE IS PROHIBITED AND NOT ALLOWED IN WASH AREAS.
- TOTAL SITE AREA = 1.395 ACRES
TOTAL DISTURBED AREA = 0.99 ACRES
PHASE 1 DISTURBED AREA = 0.5 ACRES

EROSION CONTROL LEGEND			
CODE	PRACTICE	MAP SYMBOL	MAP SYMBOL
Du	DUST CONTROL ON DISTURBED AREAS	Du1	Ds1
Ds1	DISTURBED AREA STABILIZATION (WITH MULCHING ONLY)	Ds2	Ds3
Ds2	DISTURBED AREA STABILIZATION (WITH PERMANENT SEEDING)	Ds3	Ss
Ds3	DISTURBED AREA STABILIZATION (WITH SOODING)	Ss	Sd1-S
Ss	EROSION CONTROL SLOPE STABILIZATION (MATTS AND BLANKETS)	Sd1-S	Sd1-E
Sd1-S	SEDIMENT BARRIER SENSITIVE AREAS (TYPE C SILT FENCE)	Sd1-E	Sd1-P
Sd1-E	TEMPORARY INLET SEDIMENT TRAP (EXCAVATED INLET SEDIMENT TRAP)	Sd1-P	SI
Sd1-P	TEMPORARY INLET SEDIMENT TRAP (CURB INLET PROTECTION)	SI	Sd4-A
SI	STORM DRAIN OUTLET PROTECTION	Sd4-A	Cd-S
Sd4-A	TEMPORARY SEDIMENT TRAP (OVERFLOW)	Cd-S	Co
Cd-S	STONE CHECKDAM	Co	
Co	CONSTRUCTION EXIT		
	LIMITS OF DISTURBANCE		

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DULUTH, GA 30096
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WWW.LEICRAWENGINEERING.COM
PEF005198

PROJECT
BOJANGLES - STOCKBRIDGE
HUDSON BRIDGE ROAD & WILLIS DRIVE
LAND LOT 21, DISTRICT 6, PARCEL 032-01012001
HENRY COUNTY, GA

DESIGN TEAM:
DRAWN BY: FDE
DESIGNED BY: FDE
REVIEWED BY: TKS

SCALE & NORTH ARROW:
SCALE: 1"=20'
NORTH ARROW

DATE: JULY 30, 2018
JOB #: 237002
EROSION CONTROL PHASE 3

C-2.2