

LIGHT GAUGE METAL STUD SCHEDULE		
LEVEL	LOCATION	MEMBER ID
1	INTERIOR LOAD BEARING WALLS	600S162-67 @ 12" O.C.
1	EXTERIOR LOAD BEARING WALLS	600S162-68 @ 16" O.C.
1	EXTERIOR NON-LOAD BEARING WALLS	600S162-54 @ 16" O.C.
1	POOL ENCLOSURE	600S162-43 @ 16" O.C.
2	INTERIOR LOAD BEARING WALLS	600S162-67 @ 16" O.C.
2	EXTERIOR LOAD BEARING WALLS	600S162-54 @ 16" O.C.
2	EXTERIOR NON-LOAD BEARING WALLS	600S162-43 @ 16" O.C.
3	INTERIOR LOAD BEARING WALLS	600S162-68 @ 16" O.C.
3	EXTERIOR LOAD BEARING WALLS	600S162-54 @ 16" O.C.
3	EXTERIOR NON-LOAD BEARING WALLS	600S162-43 @ 16" O.C.
4	INTERIOR LOAD BEARING WALLS	600S162-43 @ 16" O.C.
4	EXTERIOR LOAD BEARING WALLS	600S162-43 @ 16" O.C.
4	EXTERIOR NON-LOAD BEARING WALLS	600S162-33 @ 16" O.C.
4	INTERIOR LOAD BEARING WALLS	600S162-33 @ 16" O.C.
5	EXTERIOR LOAD BEARING WALLS	600S162-33 @ 16" O.C.
5	EXTERIOR NON-LOAD BEARING WALLS	600S162-33 @ 16" O.C.


COLUMN SCHEDULE		
ID	MEMBER	BASE PLATE
C1	HSS8X6X1/4	BPI
C2	HSS8X6X3/8	BPI
C3	HSS8X6X1/2	BPI
C4	HSS8X6X5/8	BPI
C5	HSS8X6X1/4	BPI

HEADER SCHEDULE		
ID	MEMBER	END SUPPORTS
H1	(2) 3628162-33	SP2
H2	(2) 600S162-33	SP2
H3	(3) 600S162-33	SP2
H4	(2) 1000S162-54	SP3

NOTE: SP2 IS A (2) STUD PACK  
 SP3 IS A (3) STUD PACK  
 STUDS TO MATCH WALLS

mcmilian  
 pazdan  
 smith  
 ARCHITECTURE

DEVITA  
 ATLANTA CHARLOTTE GREENVILLE  
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 Project: 17239  
 NC Reg. License # C-0819  
 Checked By: BV8

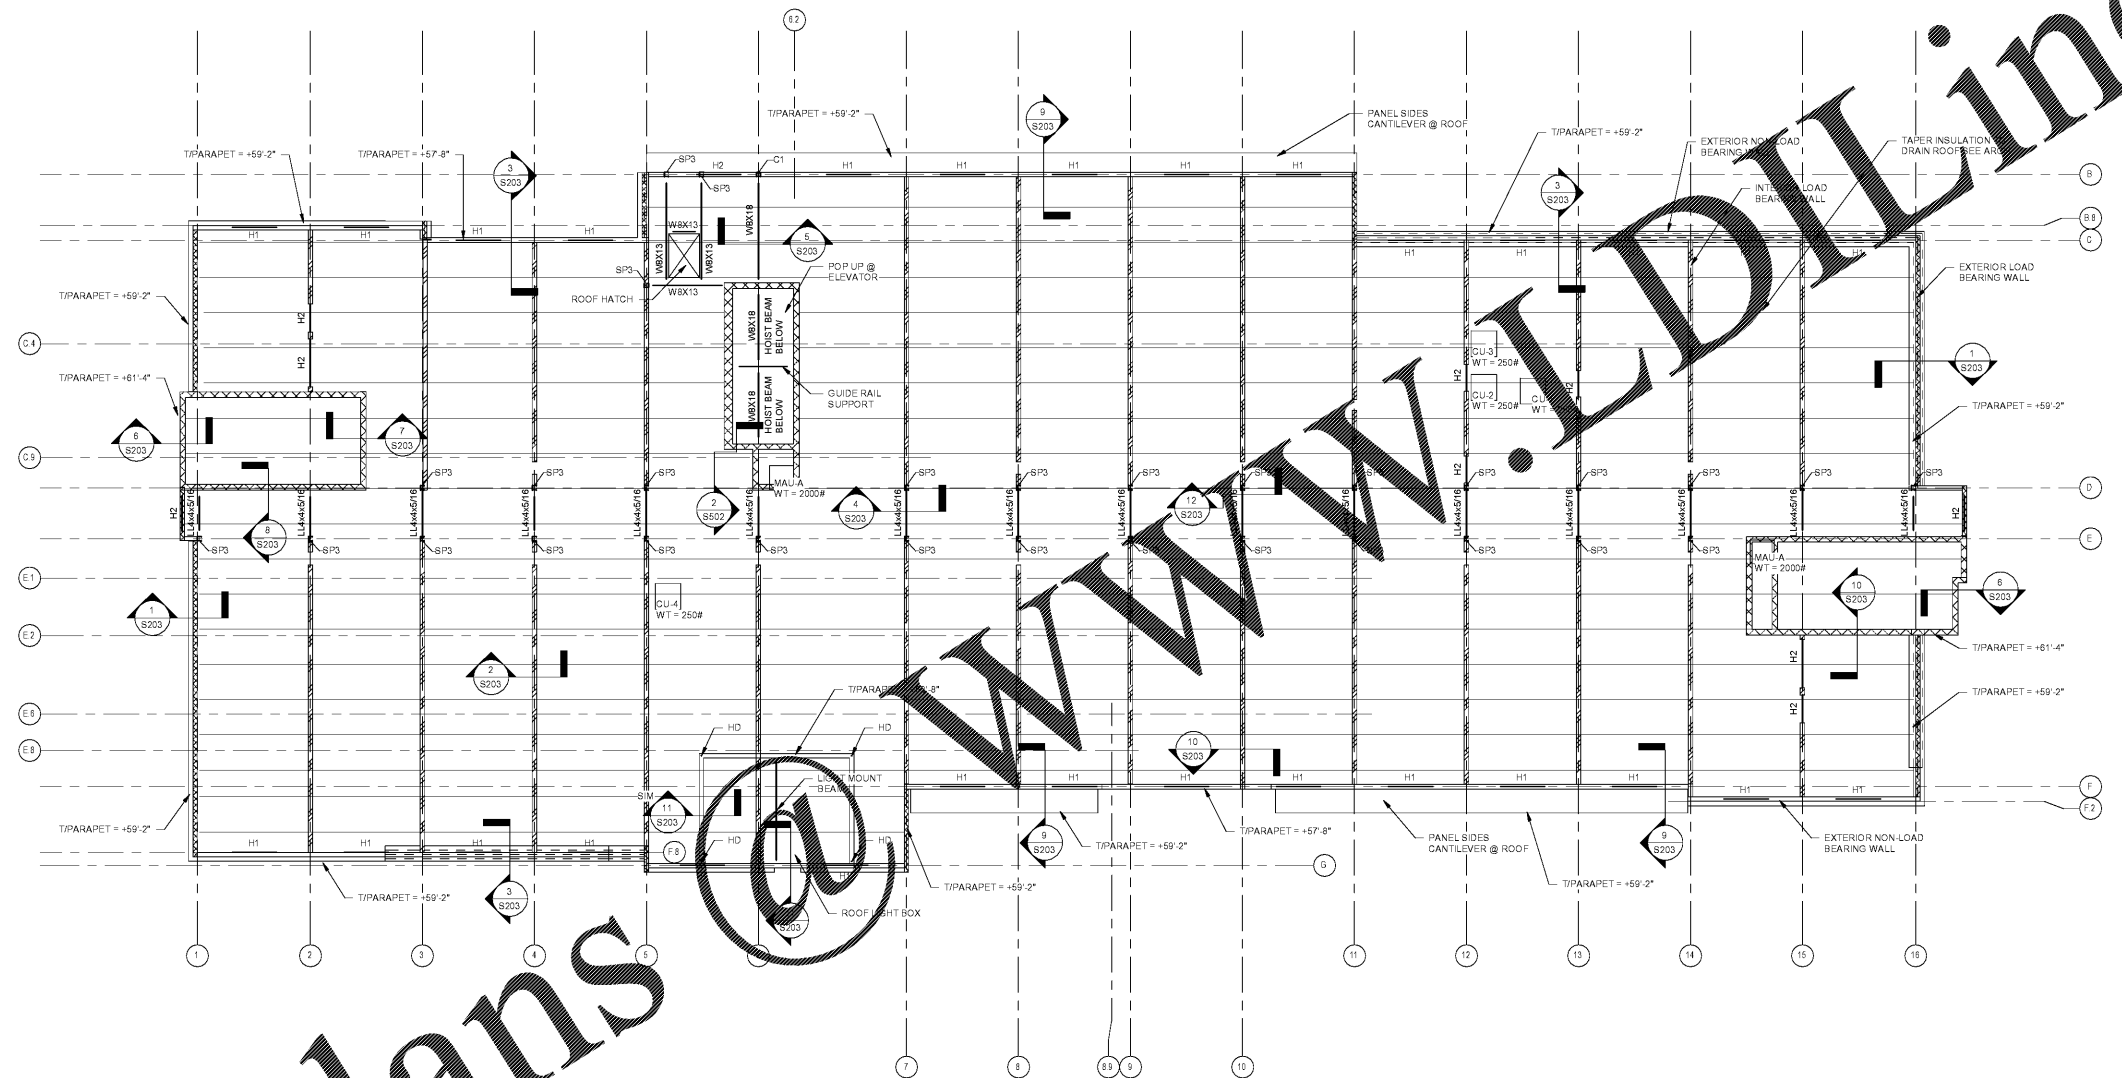

1 ROOF FRAMING PLAN  
 S106 SCALE: 1/8" = 1'-0"

- NOTES
1. ROOF STRUCTURE TO BE 6" PRECAST HOLLOWCORE PLANK CONSTRUCTION DESIGNED BY SPECIALTY ENGINEER. REFER TO GENERAL NOTES FOR DESIGN LOADS
  2. T/STEEL = +54'-8" U.N.O.
  3. T/PLANK = +56'-4"
  4. INTERIOR WALLS AT COLUMN LINES 2-16 ARE CONSIDERED LOAD BEARING INTERIOR WALLS
  5. SEE SCHEDULE FOR LIGHT GAUGE METAL STUD WALL CONSTRUCTION
  6. TAPER INSULATION TO DRAIN ROOF (SEE ARCH)
  7. REFER TO GENERAL NOTES FOR SYMBOLS AND ABBREVIATIONS EXCEPT AS NOTED BELOW
- SP - LIGHT GAUGE STUD PACK SEE SCHEDULE  
 C - STRUCTURAL STEEL COLUMN SEE SCHEDULE  
 H - LIGHT GAUGE HEADER SEE SCHEDULE  
 HD - HOLD-DOWN SEE SCHEDULE  
 CMU - CMU WALLS  
 I - INTERIOR LOAD BEARING WALLS  
 E - EXTERIOR LOAD BEARING WALLS

SHEET ISSUE:  
 07/30/18  
 FOR CONSTRUCTION

Revisions		
Number	Description	Date

PRINCIPAL IN CHARGE:  
 PROJECT ARCHITECT:  
 DRAWN BY:  
 SHEET TITLE:  
**ROOF FRAMING PLAN**

SHEET NO. PROJ. NO.  
 017878.00

S106

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