

LIGHT GAUGE METAL STUD SCHEDULE		
LEVEL	LOCATION	MEMBER ID
1	INTERIOR LOAD BEARING WALLS	605S162-67 @ 12" O.C.
1	EXTERIOR LOAD BEARING WALLS	605S162-68 @ 16" O.C.
1	EXTERIOR NON-LOAD BEARING WALLS	605S162-54 @ 16" O.C.
1	POOL ENCLOSURE	605S162-43 @ 16" O.C.
2	INTERIOR LOAD BEARING WALLS	605S162-67 @ 16" O.C.
2	EXTERIOR LOAD BEARING WALLS	605S162-54 @ 16" O.C.
2	EXTERIOR NON-LOAD BEARING WALLS	605S162-43 @ 16" O.C.
3	INTERIOR LOAD BEARING WALLS	605S162-68 @ 16" O.C.
3	EXTERIOR LOAD BEARING WALLS	605S162-54 @ 16" O.C.
3	EXTERIOR NON-LOAD BEARING WALLS	605S162-43 @ 16" O.C.
4	INTERIOR LOAD BEARING WALLS	605S162-43 @ 16" O.C.
4	EXTERIOR LOAD BEARING WALLS	605S162-33 @ 16" O.C.
4	EXTERIOR NON-LOAD BEARING WALLS	605S162-33 @ 16" O.C.
5	INTERIOR LOAD BEARING WALLS	605S162-33 @ 16" O.C.
5	EXTERIOR LOAD BEARING WALLS	605S162-33 @ 16" O.C.
5	EXTERIOR NON-LOAD BEARING WALLS	605S162-33 @ 16" O.C.


COLUMN SCHEDULE		
ID	MEMBER	BASE PLATE
C1	HSS8X6X1/4	BPI
C2	HSS8X6X3/8	BPI
C3	HSS8X6X1/2	BPI
C4	HSS8X6X3/4	BPI
C5	HSS8X6X1/4	BPI

HEADER SCHEDULE		
ID	MEMBER	END SUPPORTS
H1	(2) 3628162-33	SP2
H2	(2) 605S162-33	SP2
H3	(3) 605S162-33	SP2
H4	(2) 1005S162-54	SP2

NOTE: SP2 IS A (2) STUD PACK
 SP3 IS A (3) STUD PACK
 STUDS TO MATCH WALLS

mcmilian
 pazdan
 smith
 ARCHITECTURE

ATLANTA CHARLOTTE GREENVILLE
 877.4.DEVITA
 devita.com
 Project: 17239
 NC Reg. License # C-0819
 Checked By: BV8

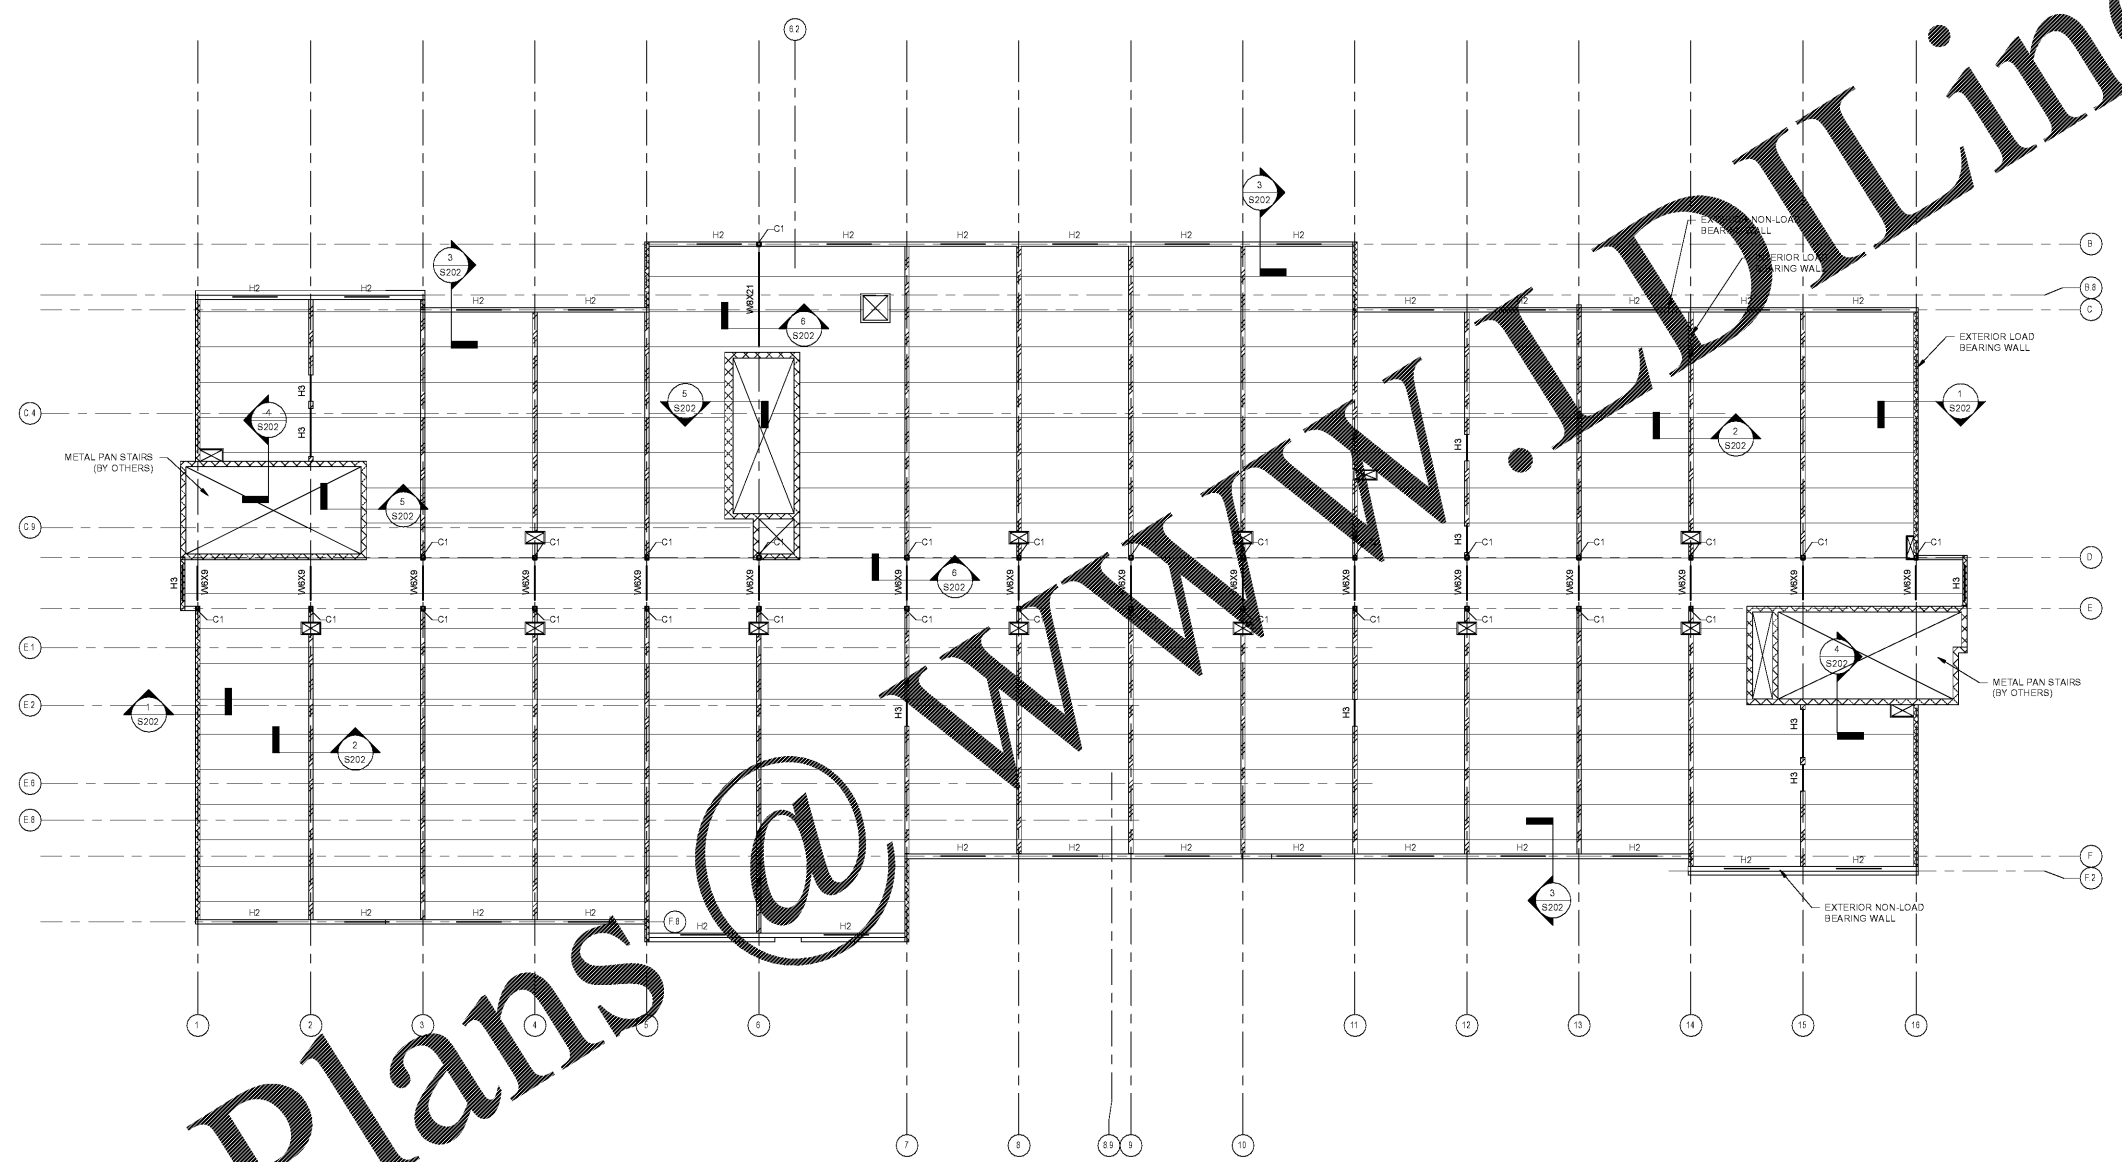

1 3RD FLOOR FRAMING PLAN
 S103 SCALE: 1/8" = 1'-0"

- NOTES
- FLOOR STRUCTURE TO BE 8" PRECAST HOLLOW CORE PLANK CONSTRUCTION WITH A 3/4" TOPPING SLAB DESIGNED BY SPECIALTY ENGINEER. REFER TO GENERAL NOTES FOR DESIGN LOADS.
 - 18" STEEL = +23'-2" U.O.D.
 - TOP OF PLANK = +23'-4"
 - INTERIOR WALLS AT COLUMN LINES 2-15 ARE CONSIDERED LOAD BEARING INTERIOR WALLS. SEE SCHEDULE FOR LIGHT GAUGE METAL STUD WALL CONSTRUCTION.
 - REFER TO GENERAL NOTES FOR SYMBOLS AND ABBREVIATIONS EXCEPT AS NOTED BELOW.
- SP - LIGHT GAUGE STUD PACK. SEE SCHEDULE.
 C - STRUCTURAL STEEL COLUMN. SEE SCHEDULE.
 H - LIGHT GAUGE HEADER. SEE SCHEDULE.
 CMU - CMU WALLS.
 IWB - INTERIOR LOAD BEARING WALLS.
 EWB - EXTERIOR LOAD BEARING WALLS.

Order Plans @

WINDSOR AUGHTRY
 HOME2 ASHEVILLE
 380 AIRPORT RD.
 ARDEN, NC 28704

SHEET ISSUE:
 07/30/18
 FOR CONSTRUCTION

Revisions		
Number	Description	Date

PRINCIPAL IN CHARGE:
 PROJECT ARCHITECT:
 DRAWN BY:
 SHEET TITLE:
 3RD FLOOR
 FRAMING PLAN

SHEET NO. PROJ. NO.
 S103 017878.00

S103