

**ROOF DRAINAGE CALCS**

- MAX 1 HOUR RAINFALL BASED ON NC PC TABLE 1106 1" 3" PER HOUR
- MAX 15 MINUTE RAINFALL BASED ON NC PC TABLE 1106 16" 6" PER HOUR
- MAX ROOF AREA PER DRAIN = 2,000 SF
- BASED ON NC PC TABLE 1106.2(1)
- MAIN ROOF DRAINS TO BE 3.5" MIN
- EMERGENCY OVERFLOW ROOF DRAINS TO BE 4.5" MIN

**ROOF PLAN NOTES**

1. PROVIDE 4'-0" X 4'-0" ACCESS DOORS ON BACK SIDE OF ALL PARAPETS WHERE SIGNAGE OCCURS

mcmillan  
pazdan  
smith  
ARCHITECTURE

CONSULT LOG

SCALE



WINDSOR AUGHTRY

HOME2 ASHEVILLE

390 AIRPORT RD.  
ASHEVILLE, NC 28704

SHEET ISSUE:  
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FOR CONSTRUCTION


Revisions		
Number	Description	Date

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SHEET TITLE:  
ROOF PLAN

SHEET NO. PROJ. NO.  
017378.00

A106

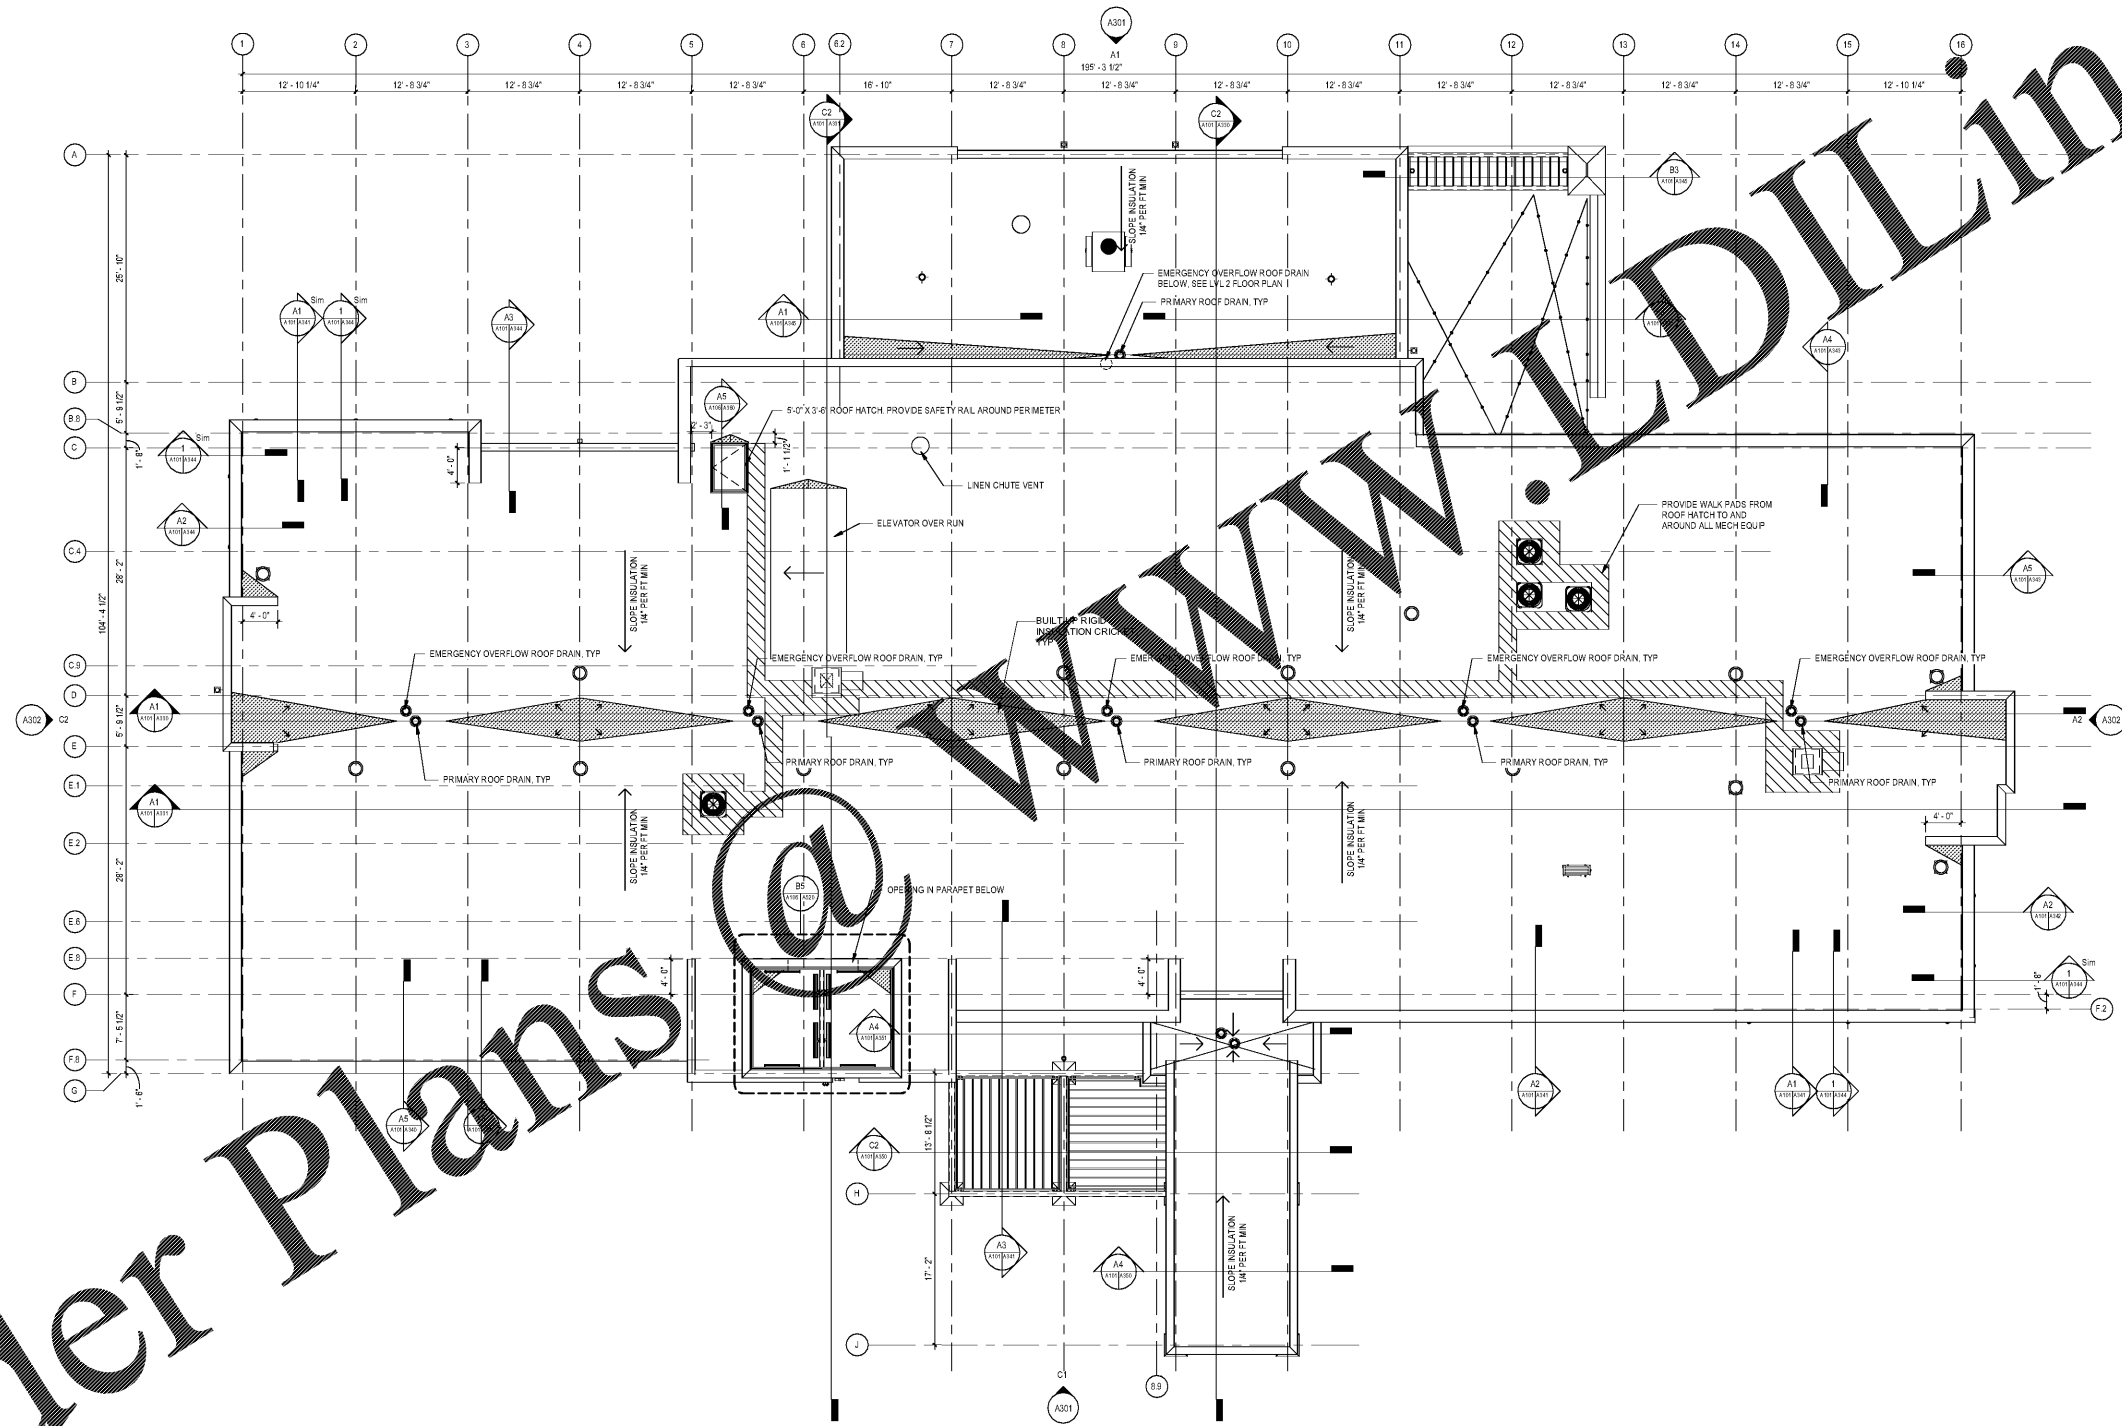

Order Plans

ROOF PLAN

1/8" = 1'-0"

ALL DIMENSIONS SHOWN ON THIS DRAWING ARE UNLESS OTHERWISE SPECIFIED. THE CONTRACTOR SHALL BE RESPONSIBLE FOR OBTAINING ALL NECESSARY PERMITS AND APPROVALS FROM THE LOCAL, STATE AND FEDERAL AGENCIES. THE CONTRACTOR SHALL BE RESPONSIBLE FOR OBTAINING ALL NECESSARY PERMITS AND APPROVALS FROM THE LOCAL, STATE AND FEDERAL AGENCIES. THE CONTRACTOR SHALL BE RESPONSIBLE FOR OBTAINING ALL NECESSARY PERMITS AND APPROVALS FROM THE LOCAL, STATE AND FEDERAL AGENCIES.