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ISSUED FOR PERMIT
ROOF FRAMING PLAN
EXTENDED STAY OF AMERICA
POOLER, GA

COMMISSION NO: 18-120-00
DRAWING NO: S204

ROOF FRAMING PLAN NOTES:

- SEE SHEET S205 FOR SHEARWALL PLAN. WOOD TRUSS SUPPLIER TO COORDINATE TRUSS LAYOUT W/ SHEAR WALL LOCATIONS.
- SEE DETAIL 1/S401 FOR STANDARD WOOD FRAMING DETAILS & STANDARD STEEL FRAMING DETAILS.
- AT LOCATIONS WHERE PARAPET HEIGHT EXCEEDS CAPACITY OF TRUSS TAILS TRUSS SUPPLIER TO FRAME DIAGONAL BRACE INTO THE TRUSS PROFILE. ROOFING TO SLOPE UP TRUSS PROFILE.
- REINFORCE 8" CMU WALLS W/ #5 VERTS @ 2'-8" O.C.
- "L1" DENOTES 1L3/4x3/4x3/4 (LVL) CMU LINTEL. S.D. 9/S401.
- ALL STRUCTURAL PARTY WALLS TO BE STAGGERED 2x4's @ 8" O.C. WITH 2x6 PLATES.

PLAN KEYNOTES


MARK	NOTE
1	ROOF TRUSSES @ 2'-0" O.C. PROVIDE 1/4" PER FOOT MIN SLOPE. SEE ARCH ROOF PLAN. MINIMUM TRUSS DEPTH TO BE 20".
2	2x10 JOISTS @ 1'-4" O.C.
3	W8x18 HOST BEAM RATED FOR 7500LB CONCENTRATED LOAD. CONTACT ENGINEER F LOADS NEED TO BE INCREASED. SEE DETAIL 10/S401 FOR STEEL BEAM BRG @ CMU WALL.
4	ROOF HATCH OPENING. TRUSS SUPPLIER TO PROVIDE G.T.'S, HEADERS AND CONNECTIONS FOR FRAMED OPENINGS.
5	MED. EQUIPMENT. SEE MED. WEIGHT FOR DISTRIBUTION AND DIMENSIONS. TRUSS SUPPLIER TO PROVIDE G.T.'S, HEADERS, AND CONNECTIONS FOR FRAMED OPENINGS.
6	TRUSS SUPPLIER TO PROVIDE FRAMED OPENING AT MECHANICAL OPENING. VERIFY SIZE & LOCATION WITH MECHANICAL.

WOOD HEADER SCHEDULE

MARK	SIZE	JACK STUDS	KING STUDS	COMMENTS
H1	(2) 2x8	(1) 2x6	(1) 2x6	-
H2	(2) 2x8	(2) 2x6	(1) 2x6	-
H3	(3) 2x10	(2) 2x6	(1) 2x6	-
H4	(3) 1 1/2"x8 1/2" LVL	(3) 2x6	(1) 2x6	-
H5	(3) 1 1/2"x7 1/2" LVL	(3) 2x6	(1) 2x6	-
H6	(3) 1 1/2"x11 1/2" LVL	(4) 2x6	(2) 2x6	-
H7	(3) 2x10	(2) 2x6	(1) 2x6	-

WOOD BEAM SCHEDULE

MARK	SIZE	COMMENTS
B1	STAR BEAM	SEE DETAIL
B2	(3) 2x10	(1) 2x6 EACH END
B3	(3) 1 1/2"x8 1/2" LVL	(2) 2x6 EACH END
B4	(3) 1 1/2"x8 1/2" LVL	(3) 2x6 EACH END
B5	(3) 1 1/2"x8 1/2" LVL	(4) 2x6 EACH END
B6	(3) 1 1/2"x21" LVL	-

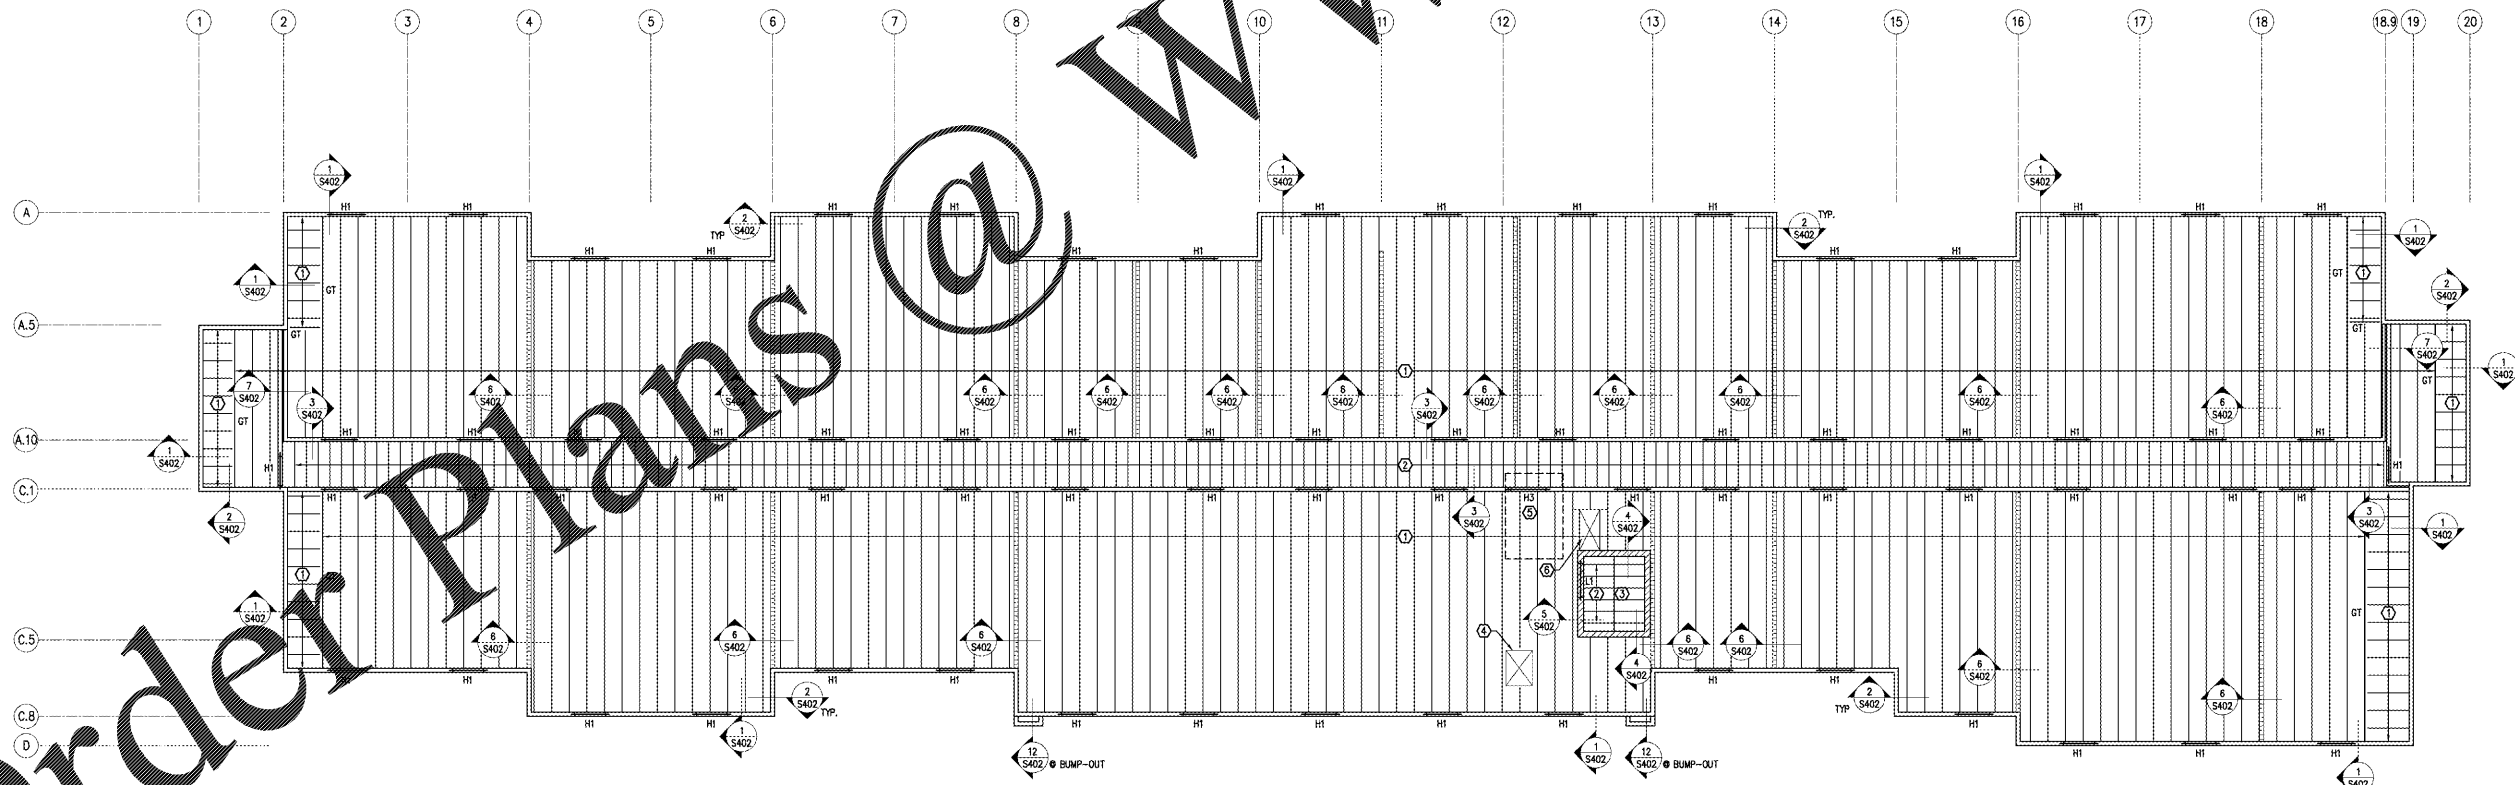

ROOF FRAMING PLAN

1/8" = 1'-0"

ROOF-TRUSS BRG EL. = 41'-8 1/4"



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