
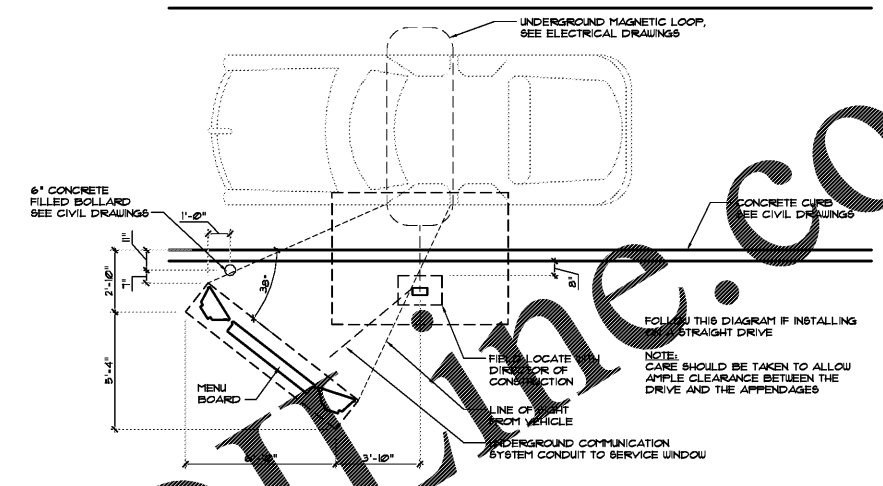


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**A DRIVE THRU PLAN - LINEAR**  
SCALE: 1/4" = 1'-0"

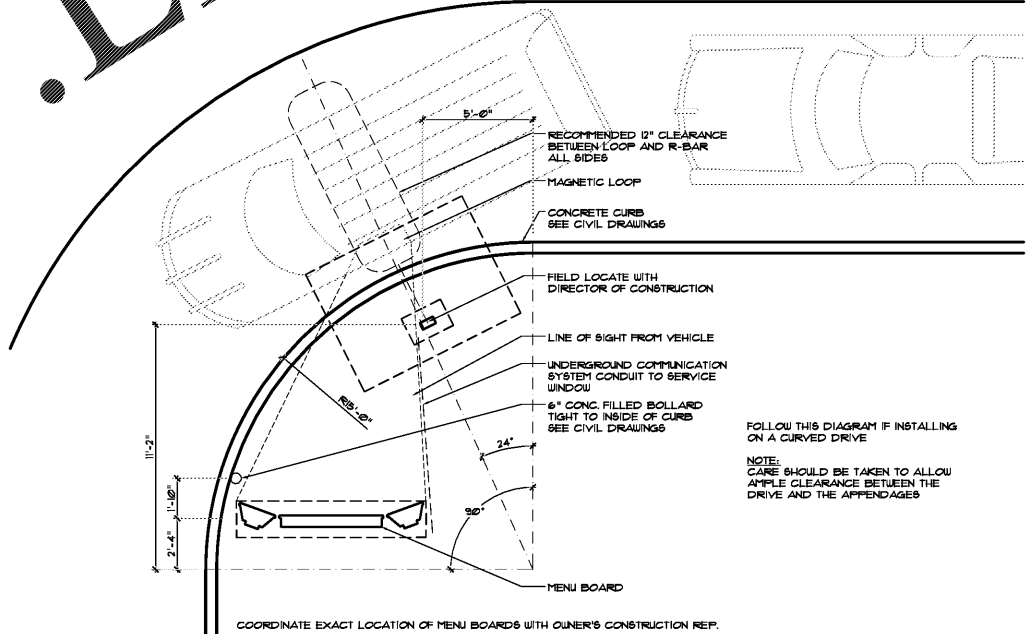

**B DRIVE THRU PLAN - CURVED**  
SCALE: 1/4" = 1'-0"

**OUTDOOR DRIVE THRU MENU SYSTEM**

**BASIC CONSTRUCTION:**  
 LIGHT BOX: ROTO MOLDDED POLYETHYLENE ENCLOSURE  
 DOOR: FORMED SHEET METAL, POWDER PAINTED, HINGED DOWN  
 ENTIRE LENGTH WINDOWS ARE NON-GLARE ACRYLIC  
 1/8" THICK WITH ALLEN WRENCH MOUNTED SCREWS.  
 MENU PANEL: FABRICATED HEAT AND LIGHT RESISTANT ACRYLIC  
 PLASTIC  
 DOOR: ROTO-MOLDDED POLYETHYLENE BASE  
 SEE MANUFACTURER'S INSTALLATION INSTRUCTIONS (BY HOWARD  
 COMPANY, INC.)

**NOTE:** MENU BOARD SUPPLIED BY OWNER ASSEMBLED AND  
 INSTALLED BY G.C.  
**BOARD SPECIFICATIONS:**  
 OVERALL LIGHT BOX SIZE: 21-1/8"W X 850"D X 48-1/4"H  
 OVERALL SIZE WITH BASE: 18-1/8"W (BASE) X 17" X 12"H  
 SHIPPING WEIGHT: 65 LBS. (PREVIEW BOARD)  
 23 LBS. / 11 LBS (POLE MOUNT/BASE FOR  
 POLE) 15 LBS. (BRACKET MOUNT)

**NOTE:**  
 THE DRIVE THRU CANOPY SYSTEM IS A PRE-FABRICATED UNIT. THE  
 CANOPY WILL BE PROVIDED BY OTHER AND INSTALLED BY THE  
 GENERAL CONTRACTOR. THE GENERAL CONTRACTOR SHALL  
 PROVIDE THE CONCRETE FOUNDATION. COORDINATE THE EXACT  
 LOCATION WITH THE SITE PLAN AND STRUCTURAL DRAWINGS. THE  
 GENERAL CONTRACTOR SHALL PROVIDE ALL REQUIRED CONDUIT  
 FOR POWER/COMMUNICATION WIRING AND MAKE ALL FINAL  
 CONNECTIONS TO THE CANOPY.  
 THESE ARE TYPICAL MENU BOARD DETAILS. THEY HAVE BEEN  
 SUPPLIED BY ARBY'S RESTAURANT GROUP FOR INFORMATIONAL  
 PURPOSES ONLY. THEY DO NOT TAKE THE PLACE OF SHOP  
 DRAWINGS THAT SHOULD BE SUBMITTED BY THE  
 CONTRACTOR/MANUFACTURER THAT IS RESPONSIBLE FOR THE SITE  
 SPECIFIC PROJECT. ALL PROJECT SPECIFIC INFORMATION NEEDS TO  
 BE COORDINATED WITH THE G.C., CIVIL ENGINEER, OWNER AND THE  
 SOILS INVESTIGATION REPORT.

**SYSTEM BASICS:**  
 1. THE SYSTEM IS COMPRISED OF ONE LIGHT BOX WITH THE OPTION  
 OF MOUNTING IT THREE DIFFERENT WAYS. IT CAN BE MOUNTED AS  
 A FREE-STANDING PREVIEW BOARD WITH OPTIONAL PEDESTAL  
 BASE AS AN APPENDAGE PREVIEW BOARD WITH AVAILABLE  
 HARDWARE OR AS A WALL MOUNTED PREVIEW BOARD.  
 2. EACH SYSTEM IS DESIGNED FOR EASY TRANS-LITE REMOVAL  
 USING TWO SEPARATE DOORS. THE PANEL OPTIONS, (TWO MINI  
 TRANSPARENCIES OR ONE LARGE TRANSPARENCY PANEL) LIFT  
 AND DROP INTO THE CABINET WITH EASE.  
 3. TRANS-LITE SIZES: FULL TRANS-LITE IS 15.75"W X 21.87"H  
 MINI TRANS-LITE IS 15.50"W X 10.50"W  
**ELECTRICAL INFORMATION:**  
 THE SYSTEM IS POWERED BY 120 VOLTS, 60 HERTZ ON A BASIC 15 AMP  
 CIRCUIT.  
 BALLAST REPLACEMENT: (1) POWER LIGHTING 100/300/400 RAPID START  
 80/200/16 AMP'S  
 LAMP REPLACEMENT: (2) F42T12/D/HO/42- 55 WATT FLUORESCENT

REVISIONS	BY

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NOT FOR  
 CONSTRUCTION

Case No. 18-0000002  
 New Building for  
**ARBY'S**  
 Store #8149  
 1058 Dunlawton Ave.  
 Port Orange, Florida

Date: 08.14.18  
 Project Mgr: DM  
 Drawn: JDS  
 Job: 18-082  
 Sheet  
**AS2**