


- ROOF PLAN NOTES:**
1. SEE SHEET S0.1 FOR GENERAL NOTES AND S0.2 FOR SCHEDULES.
 2. SEE SHEET S5.0 FOR TYPICAL FRAMING SECTIONS AND DETAILS.
 3. TRUSS BEARING ELEVATION = 14'-4"
 4. SEE ARCHITECTURAL DRAWINGS FOR TRUSS PROFILES, HEEL HEIGHTS, AND ROOF SLOPES.
 5. COORDINATE FINAL SIZE AND LOCATION OF OPENINGS, EQUIPMENT AND ROOF DRAINS WITH MECHANICAL AND PLUMBING CONTRACTORS.
 6. ALL EXTERIOR WOOD BEARING WALLS TO BE TYPE W1 UNLESS NOTED OTHERWISE.
 7. ALL HEADERS AND BEAMS TO BE DROPPED UNO.

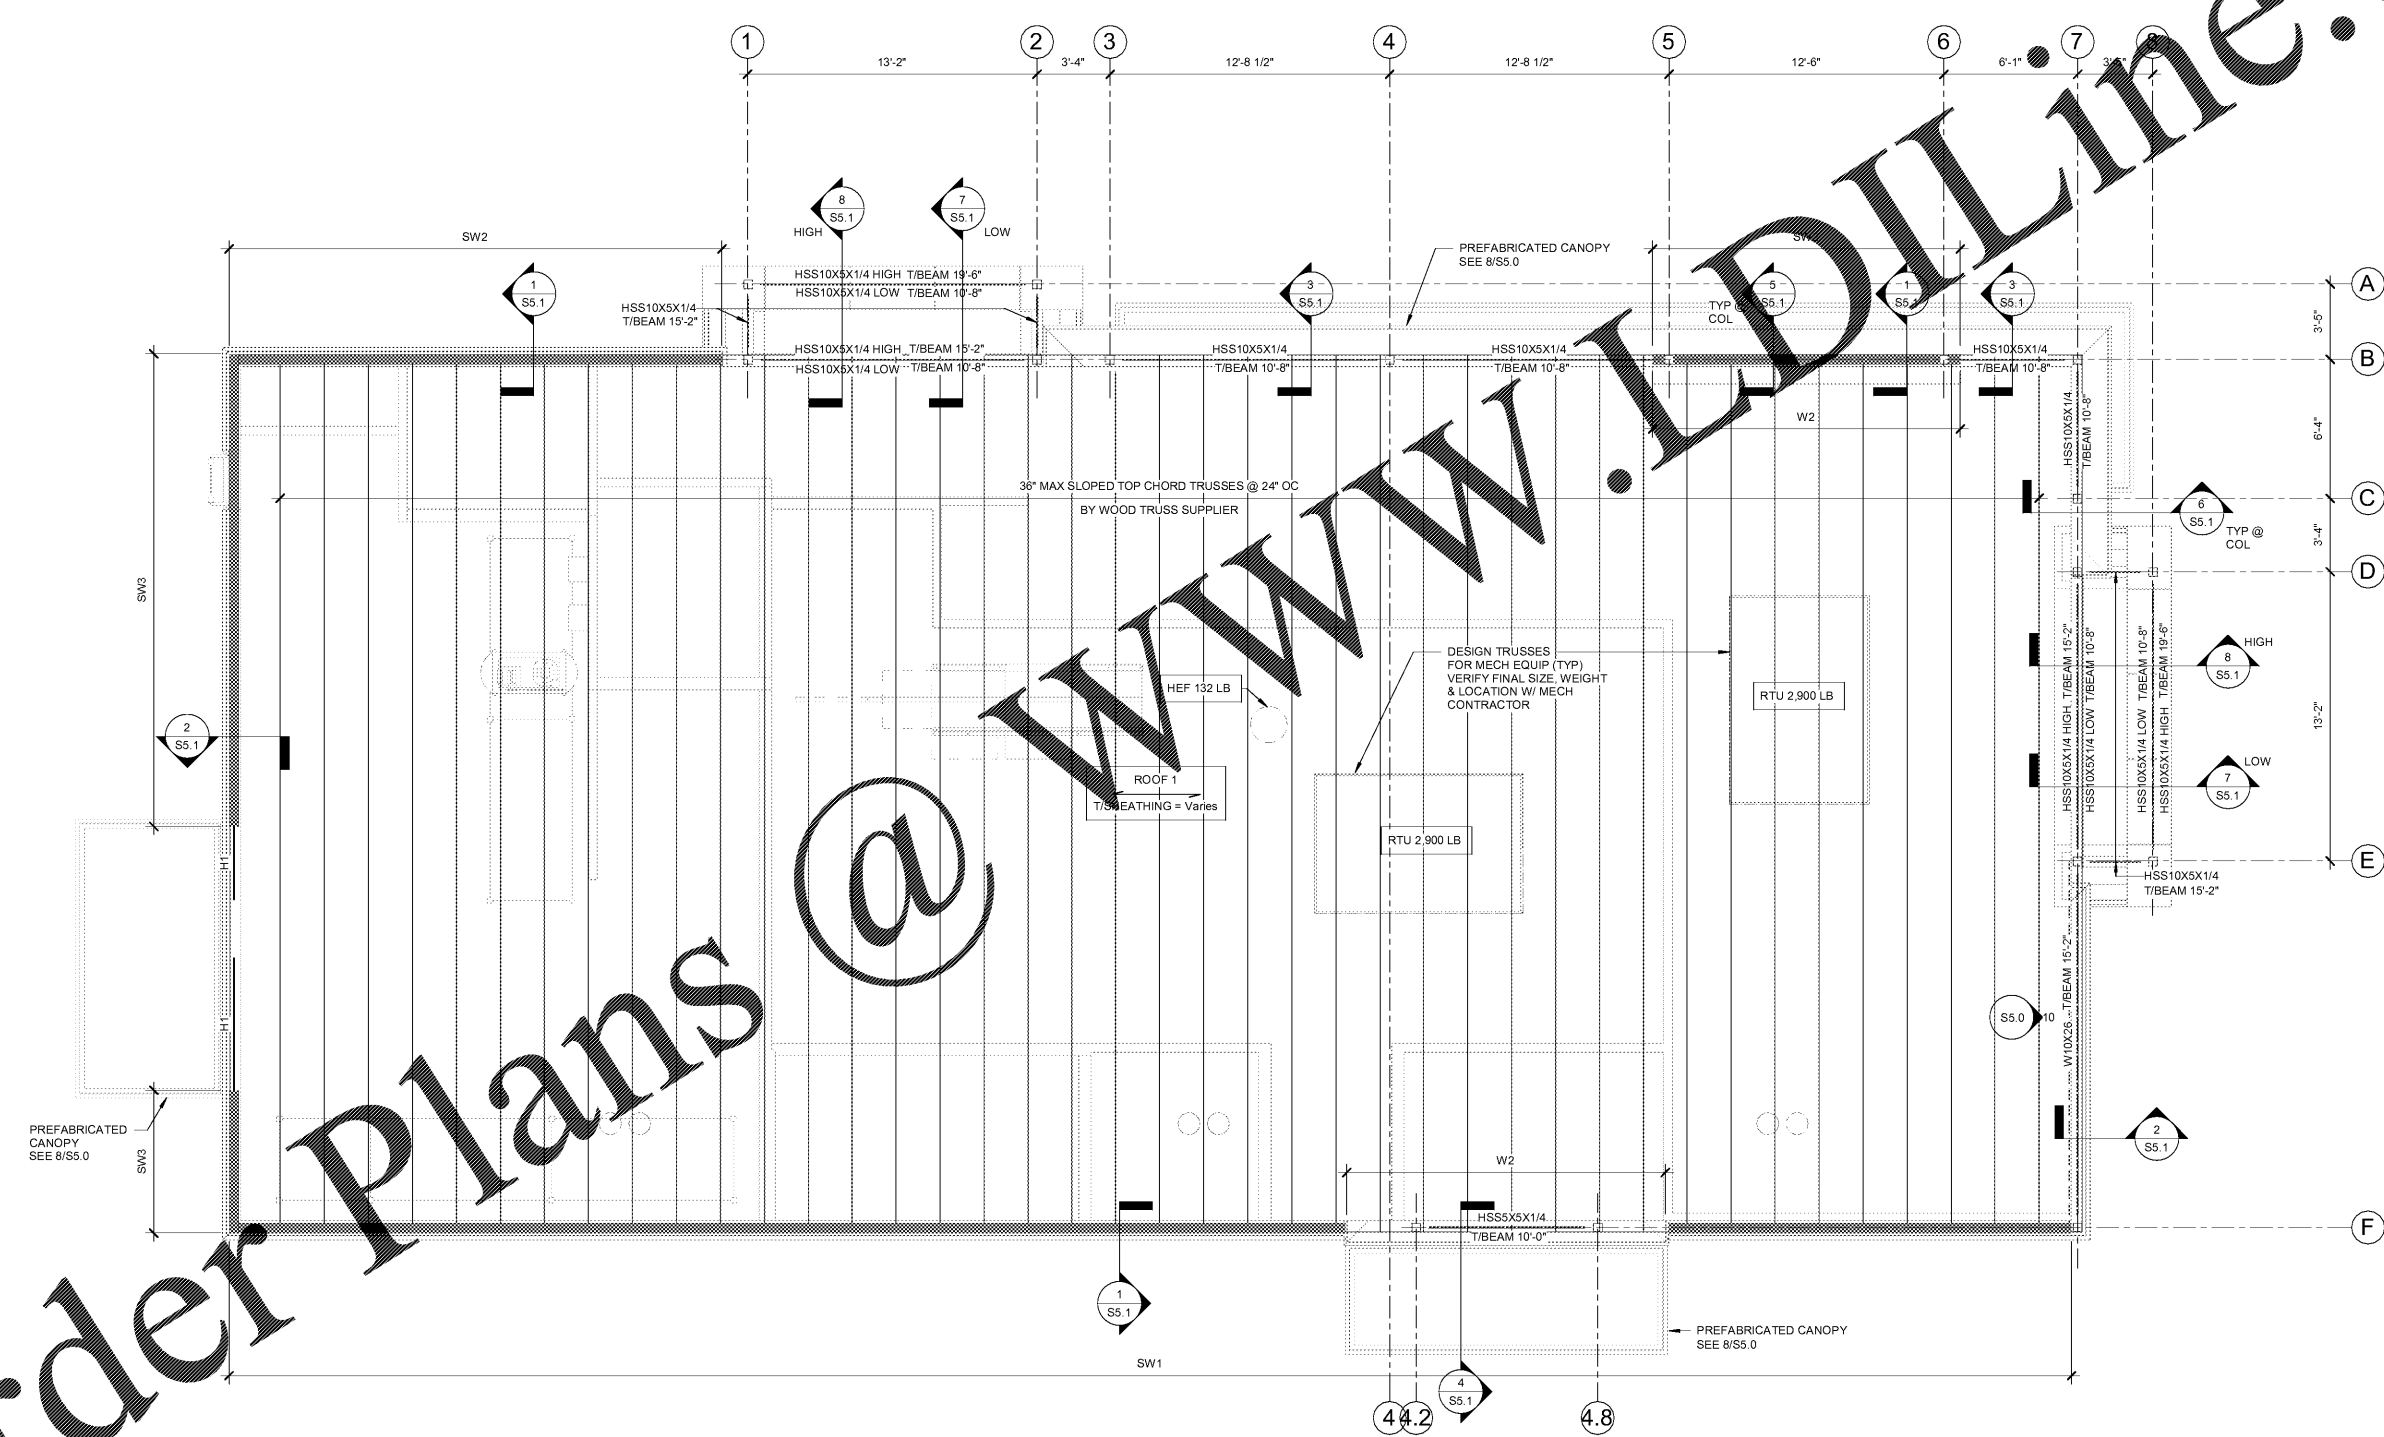


1 ROOF FRAMING PLAN
 SCALE: 1/4" = 1'-0"

GEORGE SARFATY, IA
 800 Olsen Blvd, Suite 415, Broomfield, Illinois 60010
 708.400.1100 | www.georgesarfaty.com | Copyright © 2018

CORE engineering
 Client-focused | Creative
 Collaborative | Communicative |
 12308 N. Corporate Pkwy, Suite 300
 Mequon, WI 53092 | 262.236.9372
 CAE Project #: 18040

KRISPY KREME DOUGHNUTS
 1730 EAST 9 MILE ROAD
 PENSACOLA, FL 32514

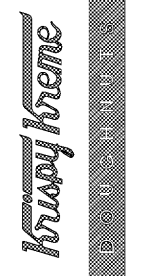

SEAL:	
DATE:	08/01/18
PROJECT NO.:	18-004
CHECKED BY:	Checker
DRAWN BY:	Author
SHEET TITLE:	ROOF FRAMING PLAN
SHEET NO.:	

S1.2