

WALL SECTION NOTES

- 1 5 RIB V-GROOVE METAL ROOF
- 2 3/4" TONGUE AND GROOVE APA RATED EXT. PLYWOOD SHEATHING, SEE STRUCT.
- 3 RAFTERS - SEE STRUCT.
- 4 CONTINUOUS STORMGUARD WATER & ICE SHIELD UNDER ENTIRE METAL ROOFING & UP PARAPET WALL. SECURE UNDER METAL COPING.
- 5 EXTEND WALL UP TO SHEATHING BETWEEN EACH RAFTER
- 6 DRIP EDGE
- 7 5/4" CEDAR FASCIA - PAINT GREEN
- 8 1/2" CEDAR SOFFIT, PRE-FINISHED STAIN
- 9 PAINT BLACK
- 10 WINDOW, SEE WINDOW SCHEDULE
- 11 3/4" PLYWOOD FULL WIDTH OF LADDER, FULL HEIGHT OF WALL
- 12 BRICK ROWLOCK SILL - SLOPE FOR POSITIVE DRAINAGE
- 13 METAL FLASHING
- 14 TYVEK DRAINWRAP UP TO 9'-0" A.F.F. TAILOR W/ VENT & WATERSHIELD ABOVE. LAP OVER TYVEK 4" AT TRANSITION
- 15 1/2" PLYWOOD
- 16 BRICK VENEER, RUNNING BOND
- 17 WEEPS, SEE SPECIFICATIONS
- 18 GROUT SOLID
- 19 PRESSURE TREATED MINIMAL 2X FLOOR FRAMING AT 24" O.C.
- 20 3/4" PLYWOOD SHEATHING, GLUE & SCREWED
- 21 FLOOR FINISH MATERIAL, SEE ROOM FINISH SCHEDULE
- 22 WALL BASE, SEE ROOM FINISH SCHEDULE, SHEET A-610
- 23 1/2" GYP. IM BOND
- 24 1X8 BEVEL CEDAR SIDING, WITH 6" EXPOSURE, STAIN
- 25 SIGNAGE, SEE SIGN DRAWINGS
- 26 FOUNDATION INSULATION NOTE
- 27 NOMINAL 1X4 FURRING AT 24" O.C.
- 28 BLOCKING
- 29 FOUNDATION INSULATION, 2" AT FOOTING, 1" AT FOUNDATION THERMAL BREAK
- 30 WALL FINISH, SEE FFE SHEETS
- 31 NOMINAL 2X4 FRAMING AT 16" O.C.
- 32 METAL RIDGE FLASHING
- 33 1/2" PLYWOOD ROUGH SAWN FINISH, BATTEN STRIPS AT EACH JOINT
- 34 NOMINAL 2X CONTINUOUS LEDGER, SEE STRUCT.
- 35 WHITE LED - SEE SIGN DRAWINGS
- 36 5/4" X 6" CEDAR TRIM - PAINT GREEN
- 37 BLOCKING - SEE STRUCTURAL
- 38 METAL COPING CAP - GALVANIZED FLASHING PRIMED & PAINTED GREEN
- 39 VERTICAL CEDAR SIDING, STAIN
- 40 50 MIL SINGLE PLY PVC ROOF MEMBRANE - TURN UP WALL TO BOTTOM OF OVERHANG AND SECURE UNDER CAP FLASHING. AT WALLS HIGHER THAN 60" SECURE MEMBRANE WITH MECHANICAL FASTENERS PER MANUFACTURER.
- 41 WRAP BEAM WITH 5/4" CEDAR TRIM, STAIN
- 42 JOHNS MANVILLE ENR0Y3, 4" RIGID INSULATION
- 43 5/8" APA RATED EXT PLYWOOD SHEATHING
- 44 5/4" X 5" CEDAR WOOD TRIM
- 45 COLUMN, (PAINT ALL EXPOSED AREAS BLACK) - SEE STRUCT.
- 46 5/4" X 4" CEDAR WOOD TRIM
- 47 5/4" CEDAR WOOD TRIM
- 48 5" METAL GUTTER, COLOR TO MATCH WOOD TRIM
- 49 BEAM, (PAINT ALL EXPOSED AREAS BLACK) - SEE STRUCT.
- 50 26 GA. 2-1/2" EXPOSED CORRUGATED METAL PANELS, GALV.
- 51 2X8 PINE CAP (EASE EDGE)
- 52 LIGHT FIXTURE, SEE ELECTRICAL
- 53 WOOD TRUSS - SEE STRUCTURAL
- 54 NOMINAL 2X4 FIRESTOP AT CEILING LINE
- 55 ACOUSTICAL CEILING, SEE FINISH SCHEDULE
- 56 VAPOR BARRIER
- 57 DOOR, SEE DOOR SCHEDULE
- 58 SILICONE SEALANT
- 59 CONTINUOUS RIDGE VENT
- 60 5/4X4" CEDAR TRIM - PAINT GREEN
- 61 10"X10" VENTILATION LOUVER BEYOND AT EACH END
- 62 NOMINAL 2X JOISTS - SEE STRUCT.
- 63 6" KRAFT FACED BATT INSULATION, PAPER FACE TO BUILDING INTERIOR
- 64 4" WIDE X CONT. SOFFIT VENT WITH INSECT SCREEN
- 65 CONCRETE FOOTING - SEE STRUCT.
- 66 HEADER, SEE STRUCT.
- 67 NOMINAL 2X6 STUDS AT 16" O.C.
- 68 NOMINAL 2X4 STUDS AT 16" O.C.
- 69 THRESHOLD, SEE DOOR SCHEDULE
- 70 1/2" MOISTURE RESISTANT GYP. BD.
- 71 CERAMIC WALL TILE - SEE ROOM FINISH SCHEDULE, A-610
- 72 24X30 ACCESS OPENING WITH WALK OFF MAT-RUN UP & SECURE TO WALL WITH TERMINATION BAR
- 73 CONCRETE SLAB, SEE STRUCTURAL
- 74 BLOCKING FOR SEATING, LOCATE AS SHOWN ON FFE SHEETS
- 75 1/2" AIR GAP MAX.
- 76 BRICK ANGLE, SEE STRUCT.
- 77 FIBERGLASS REINFORCED PLASTIC (FRP) PANELS
- 78 4X8X16 SOLID BLOCK - SEE STRUCT.
- 79 DECORATIVE RAFTERS AT 24" O.C., SEE RCP
- 80 ADD BLOCKING AS REQUIRED FOR SUPPORT OF SURFACE MOUNTED TV - SEE EQ/FFE, SEE ELECT.
- 81 NEOPRENE JOINT FILLER
- 82 CONTINUOUS FLASHING AROUND SCUPPER
- 83 8"X12" METAL OVERFLOW SCUPPER
- 84 3"X8" SCUPPER OPENING, PROVIDE MEMBRANE FLASHING ALL SIDES
- 85 PROVIDE STAINLESS STEEL CAP AROUND ENTIRE OPENING AND ABOVE BRICK ROWLOCK
- 86 ROWLOCK COURSE
- 87 ACTUAL 6X6 TREATED CEDAR POST
- 88 1/2" CEMENT BOARD 18" HIGH
- 89 1 1/2" X 1/2" METAL FURRING CHANNELS
- 90 BRICK TIES
- 91 CONT. 6" METAL SLIP TRACK - SEE STRUCT.
- 92 6" METAL STUDS - SEE STRUCT.
- 93 NEW CONT. METAL STUD TRACK, SEE STRUCT.
- 94 8"X8"X16" SLIP TRACK CMU
- 95 BILCO "TYPE NB" 2'-6" X 3'-0" ROOF HATCH FURNISHED AND INSTALLED BY GC - PAINT BLACK
- 96 CURB WITH INTERGRAL CAP FLASHING
- 97 PROVIDE BLOCKING AS REQUIRED TO SECURE HATCH TO ROOF STRUCTURE
- 98 ROOF DRAIN, SEE PLUMBING FOR CONTINUATION.
- 99 1/2X2 1/2" STEEL LADDER BRACKETS - WELD TO SIDE RAILS & BOLT TO WALL WITH 2 3/8" DIA LAG BOLTS, BRACKET TO RUN IN.
- 100 3/4" DIA. STEEL RUNGS - WELD TO SIDE RAILS AT 12" O.C.
- 101 1/2" X 1/2" STEEL SIDE RAILS WITH EASED EDGES
- 102 SECURE LADDER TO FLOOR WITH 3"X3"X1/4" STEEL ANGLE WITH 3/4" DIA. EXPANSION BOLTS, 4" LONG
- 103 5/4"X4" CEDAR TRIM, PREFINISHED, STAIN
- 104 CONT. 2X6 DIAPHRAGM CHORD AROUND PERIMETER OR ROOF - SEE STRUCT.
- 105 NOMINAL 4X4 CEDAR SILL, CHAMFERED
- 106 6" THICK STYROFOAM TYPE IV INSULATION, SQUARE EDGE
- 107 SNO-GEN JR SNOW GUARDS, TYPICAL SLOPED ROOFS, SEE ROOF PLAN
- 108 NOMINAL 2X4 CROSS BRACING AT 16.0 C.
- 109 NOMINAL 2X10 CONTINUOUS



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BID SET 8/27/2018

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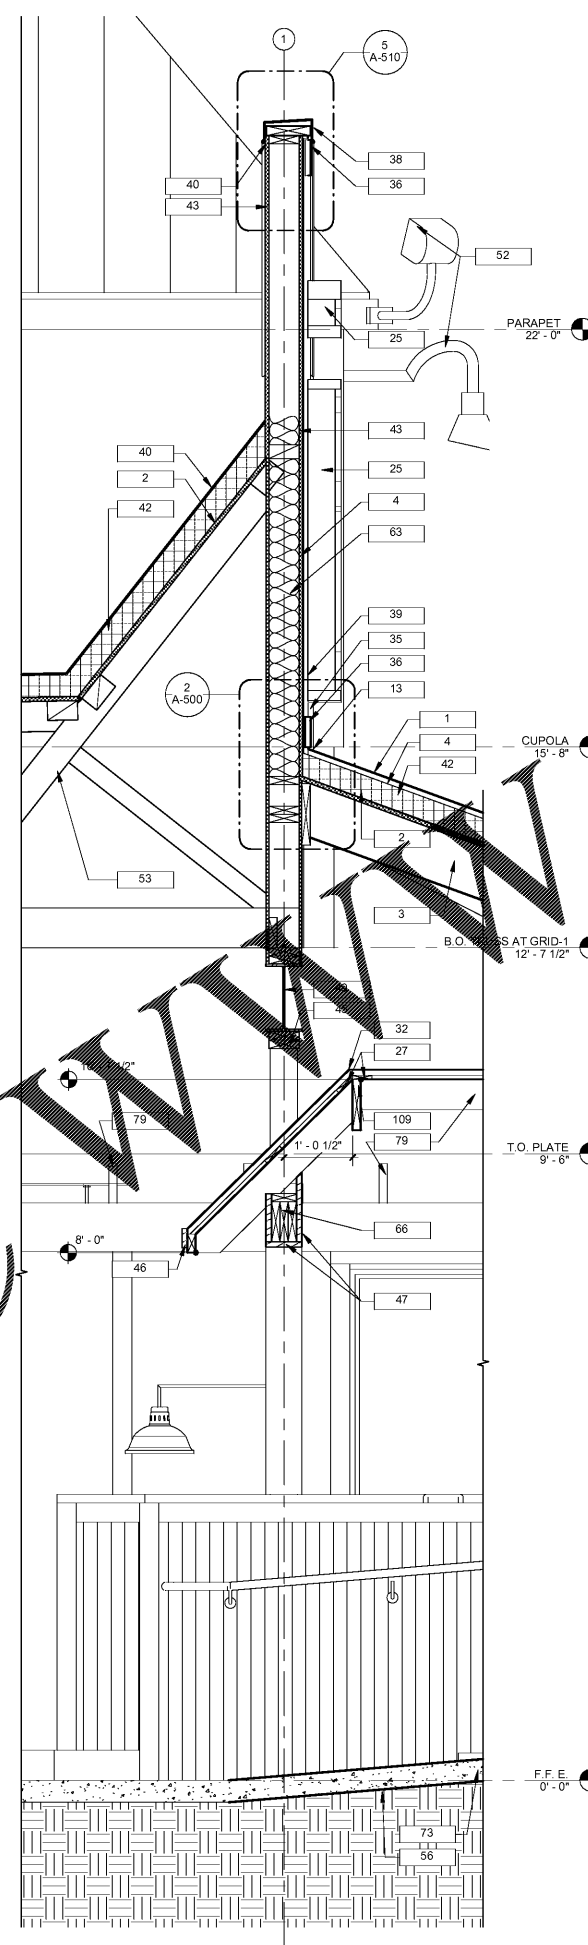
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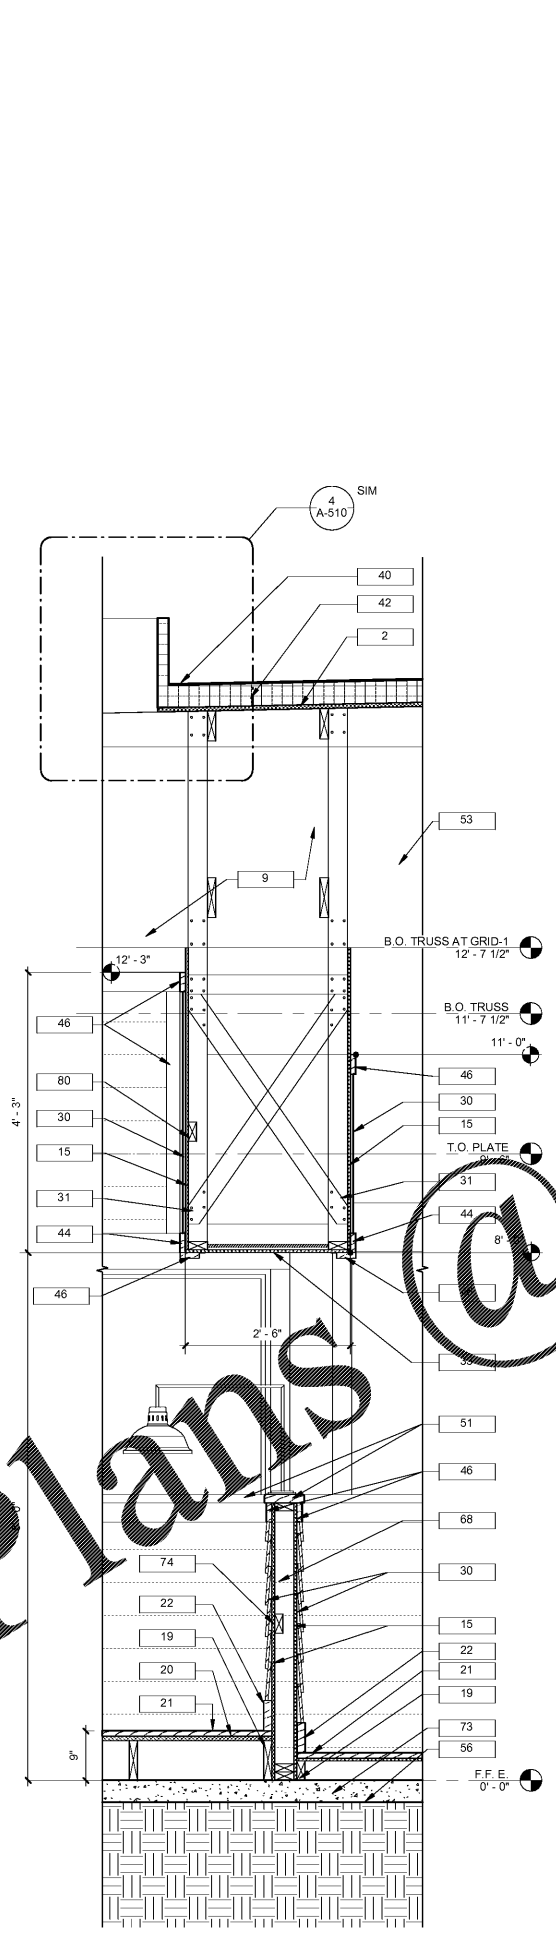
PROJECT INFORMATION BLOCK			
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SHEET TITLE	
WALL SECTIONS	
SHEET NUMBER	


A-310



2 WALL SECTION
3/4" = 1'-0"



3 WALL SECTION
3/4" = 1'-0"

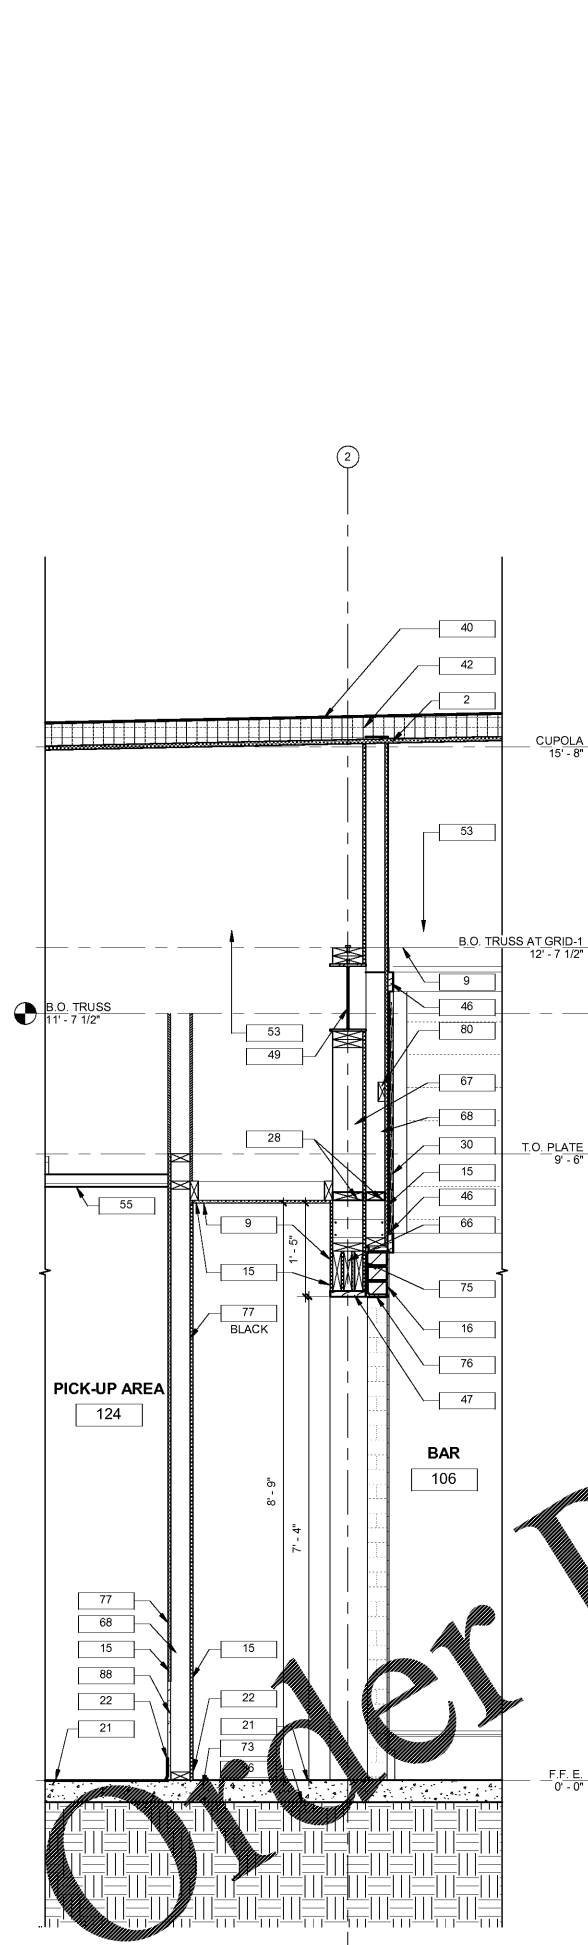

4 WALL SECTION
3/4" = 1'-0"

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