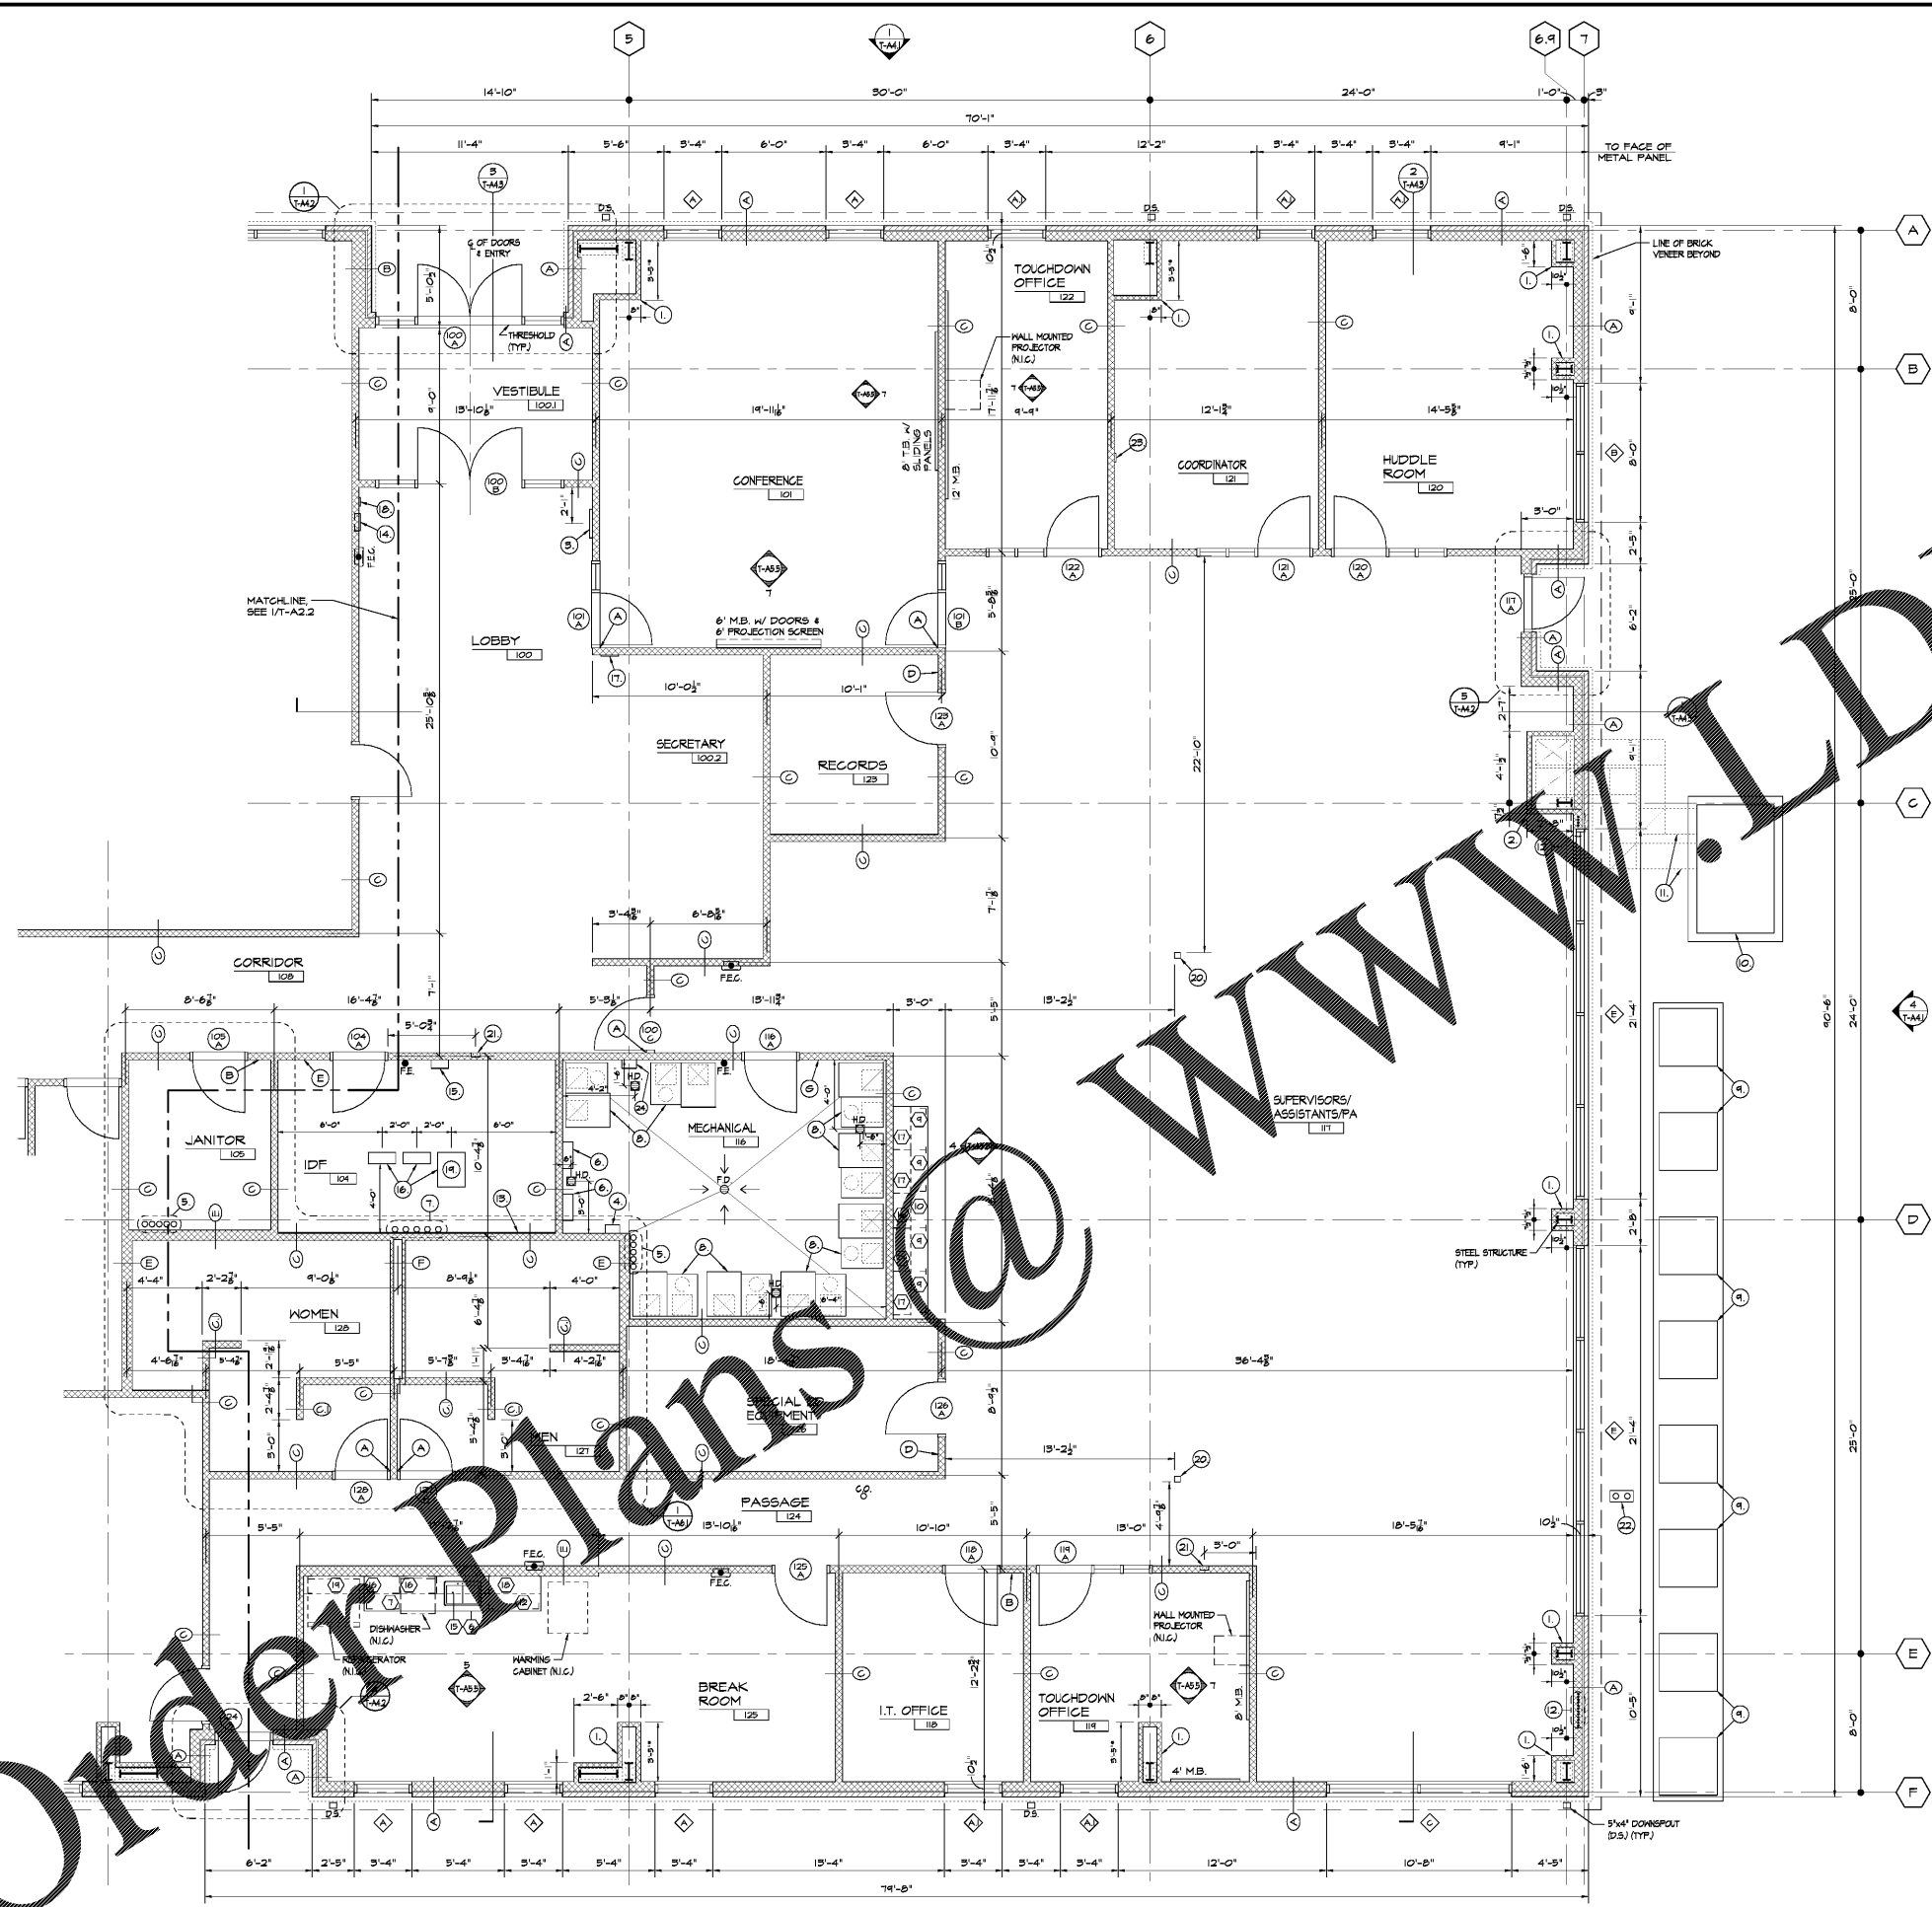


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GENERAL NOTES:
(THIS SHEET ONLY)


A. ALL EXTERIOR DIMENSIONS TAKEN FROM THE SUPERIOR FACE OF INSULATED METAL PANEL, UNLESS NOTED OTHERWISE.

B. SEE BUILDING SLAB PLAN FOR CONSTRUCTION JOINT LOCATIONS.

C. SEE REFLECTED CEILING PLANS FOR ADDITIONAL INFORMATION.

- NOTES:**
(THIS SHEET ONLY)
1. COLUMN PILASTER, SEE 4, 5 & 6/T-A5.1 FOR TYPICAL DETAIL. *ADJUST DEPTH AS NEEDED TO ENCLOSE TAPERED COLUMNS.
 2. CHASE, SEE 7/T-A5.1 FOR TYPICAL DETAIL. COORDINATE W/ DUCTWORK DIMENSIONS.
 3. PLAQUE, SEE 1/T-A5.2.
 4. HOT WATER CIRCULATING PUMP, SEE PLUMBING DRAWINGS.
 5. TPO, SEE PLUMBING DRAWINGS.
 6. WATER HEATER, SEE PLUMBING DRAWINGS.
 7. 4" DIA. PVC CONDUIT SLEEVE @ 12'-18" LONG, EVENLY SPACED AT CEILING. QUANTITY AS REQUIRED FOR NETWORKING, PLUS TWO (2) EMPTY FOR FUTURE. SEAL AT CEILING AND CAP ENDS. SEE ELECTRICAL DRAWINGS.
 8. VERTICAL FURNACE/COL. UNIT, SEE MECHANICAL DRAWINGS.
 9. CONDENSING UNIT ON CONCRETE PAD, SEE MECHANICAL DRAWINGS. VERIFY MANUFACTURER'S MINIMUM CLEARANCES.
 10. HVAC UNIT ON CONCRETE PAD, SEE MECHANICAL DRAWINGS. VERIFY MANUFACTURER'S MINIMUM CLEARANCES.
 11. DUCTWORK, SEE MECHANICAL DRAWINGS. TRIM & FLASHING PER PEMB MANUFACTURER STANDARDS. SEAL ALL AROUND PENETRATION.
 12. REFRIGERANT LINES, INSTALL WITHIN 6" METAL STUDS & RUN ABOVE CEILING. SEE MECHANICAL DRAWINGS.
 13. 3/4" GRADE A/V PLYWOOD PAINTED W/ (2) COATS OF FIRE RESISTANT PAINT, SEE ELECTRICAL DRAWINGS.
 14. FIRE ALARM ANNUNCIATOR PANEL, SEE ELECTRICAL DRAWINGS.
 15. FIRE ALARM CONTROL PANEL, SEE ELECTRICAL DRAWINGS.
 16. NETWORKING RACK, SEE ELECTRICAL DRAWINGS.
 17. ALPHON VIDEO INTERCOM MASTER SYSTEM, SEE SECURITY & ACCESS CONTROL SYSTEM DRAWINGS.
 18. INTRUSION DETECTION ALARM CONTROL KEYPAD, SEE SECURITY & ACCESS CONTROL SYSTEM DRAWINGS.
 19. INTRUSION DETECTION ALARM CONTROL PANEL ON NETWORKING RACK, SEE SECURITY & ACCESS CONTROL SYSTEM DRAWINGS. COORDINATE LOCATION W/ OWNER.
 20. POWER POLE, SEE ELECTRICAL DRAWINGS.
 21. 6"x6" RECESSED OUTLET FOR DRIVER TIME CLOCK, SEE ELECTRICAL DRAWINGS.
 22. YARD CLEANOUT, SEE PLUMBING DRAWINGS.
 23. VIDEO MANAGEMENT WORKSTATION, SEE SECURITY & ACCESS CONTROL SYSTEM DRAWINGS.
 24. CENTRAL ENERGY MANAGEMENT SYSTEM PANEL, SEE MECHANICAL DRAWINGS.

- LEGEND:**
- (A) SEE SHEET T-A2.2 FOR HALL OPENING OFFSET
 - (AS) SEE SHEET T-A5.1 FOR FINISH SCHEDULE
 - (AS.1) SEE SHEET T-A5.1 FOR HALL SCHEDULE
 - (AS.2) SEE SHEET T-A5.2 FOR DOOR SCHEDULE
 - (AS.4) SEE SHEET T-A5.4 FOR WINDOW SCHEDULE
 - (AS.5) SEE SHEET T-A5.5 FOR CASEWORK SCHEDULE
 - IM INSULATED METAL PANEL
 - DP DRYWALL PARTITIONS
 - DIMENSION TO CENTERLINE OF PARTITION/FITTURE
 - DIMENSION TO FACE OR CENTERLINE OF PARTITION/WINDOW/DOOR
 - DIMENSION TO COLUMN LINE

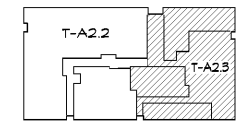

BUILDING KEY PLAN

1 SOUTH AREA PLAN
SCALE: 1/4" = 1'-0"

ST. RICHARDS, ARCHITECT, INC. MONROE, GEORGIA	NO.	DATE	REVISION
SOUTH TRANSPORTATION & MAINTENANCE FACILITY FACILITIES AND TRANSPORTATION SERVICES DEPARTMENT FULTON COUNTY, GEORGIA FULTON COUNTY BOARD OF EDUCATION			
SHEET TITLE SOUTH AREA PLAN			
DATE June 22, 2018			
DRAWN BY GL / KT			
SHEET T-A2.3			
OF 20 ISSUED FOR Proposal			