


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Revisions/Issues

06/21/18 PERMIT SET



Seal

Lazaro Alfonso, P.E. FL Reg. No.: 69782

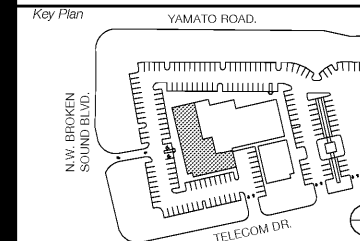Project Title
SOUTHERN PALM CROSSING
 BUILDING SHELL
 11001-11161 Southern Blvd.
 Royal Palm Beach, FL 33411

Job Number 017512.00 - 17M32


Drawing
ROOF FRAMING PLAN

Scale **AS NOTED**
 Drawing Date **06/21/18**

Drawing No.


S-211

Sheet Of

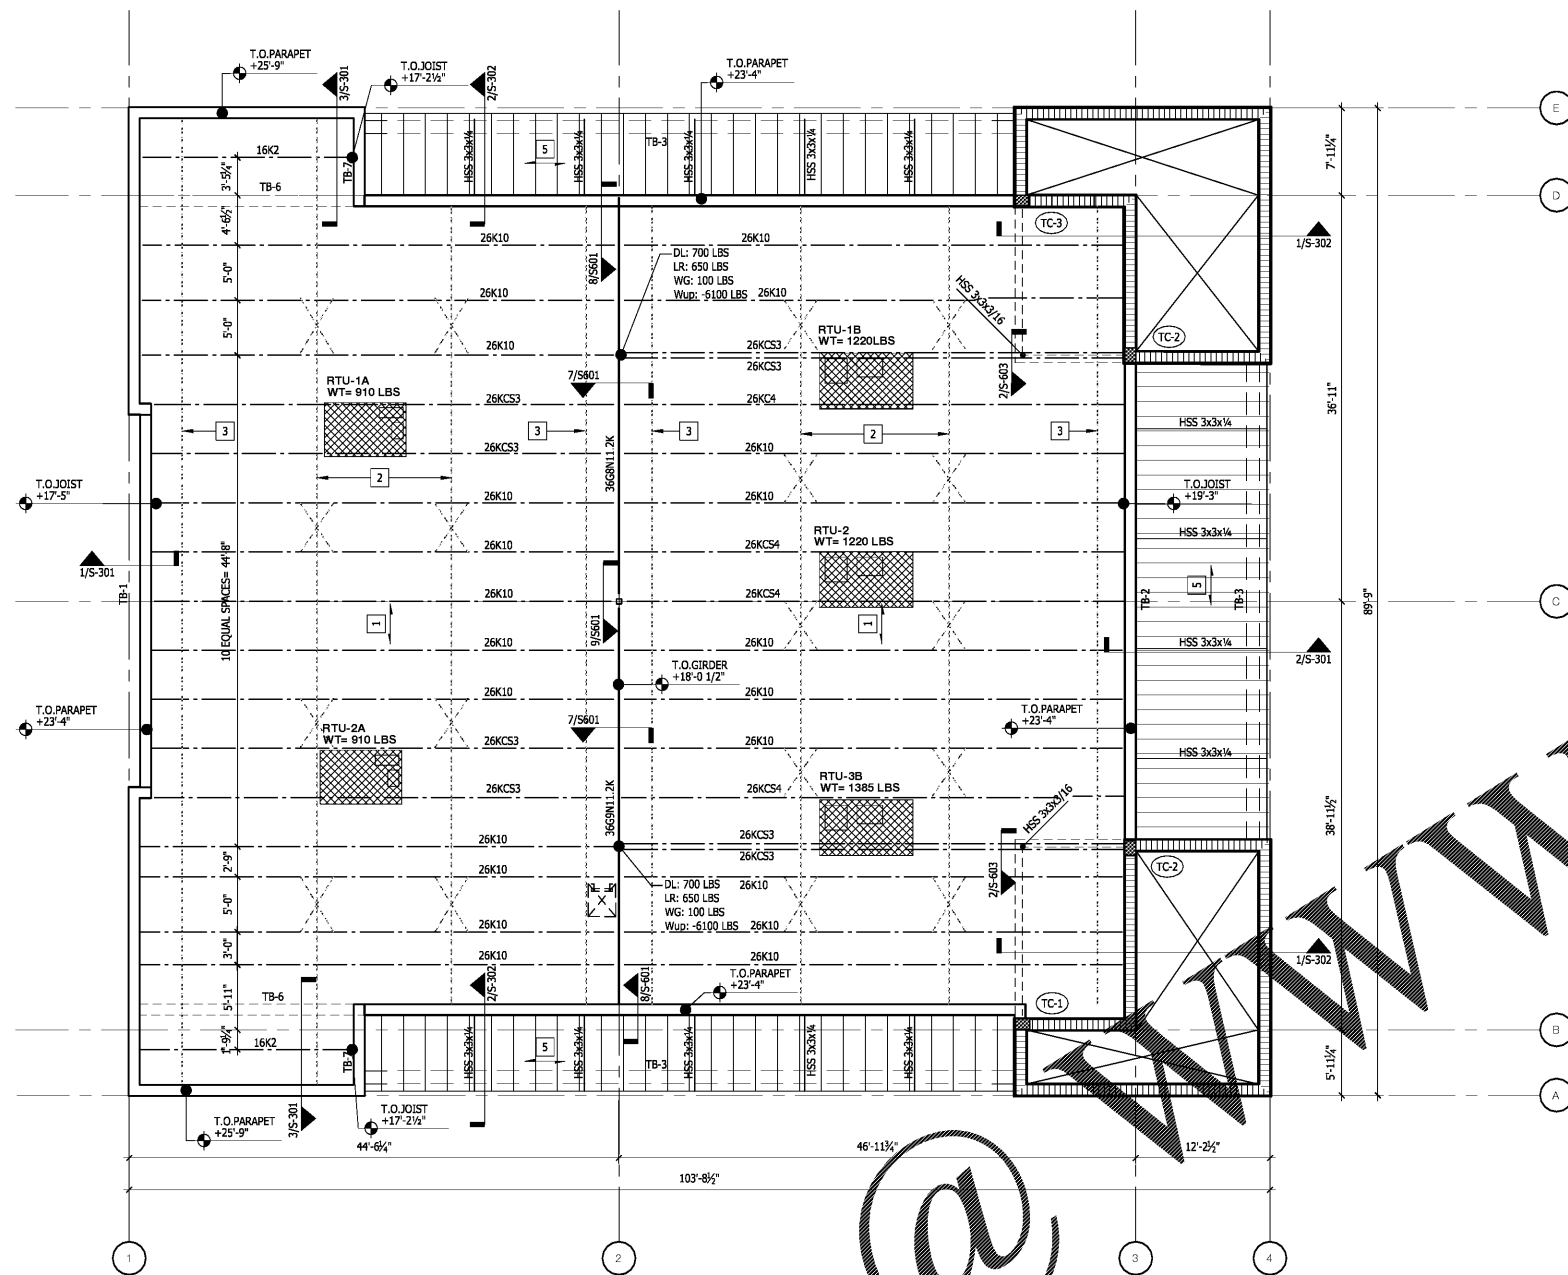

ROOF FLOOR PLAN

SCALE: 1/8"=1'-0"

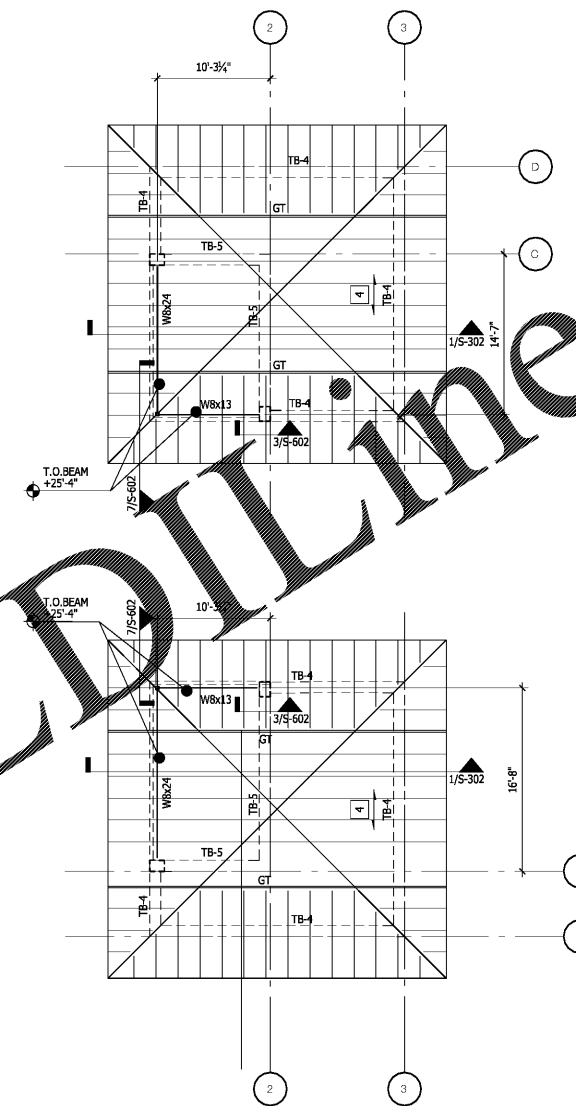

HIGH ROOF FLOOR PLAN

SCALE: 1/8"=1'-0"

KEY NOTES

1. ROOFING (SEE ARCHITECTURAL) ON 1 1/2" GAGE TYPE 'B' GALVANIZED DECK SUPPORTED BY STEEL BAR JOISTS FASTENED WITH 3/8" PUDDLE WELDS AND 2" SIDELAP FASTENERS PER SPAN.
2. TYPICAL BAR JOIST BRIDGING: 2x6x6x CONT. TOP AND BOTTOM CHORD (WELD TO EACH JOIST TOP AND BOTTOM CHORD), PROVIDE ADDITIONAL 'X' BRIDGING 2x6x6x AS SHOWN
3. TYPICAL JOIST UPLIFT BRIDGING: HORIZONTAL 2x6x6x CONT. AT FIRST BOTTOM CHORD PANEL POINT (WELD L TO EACH JOIST)
4. ROOFING (SEE ARCHITECTURAL) ON 1/2" FIRE RETARDANT PLYWOOD OVER COLD FORMED STEEL TRUSSES. FASTEN TO TRUSSES WITH HOT DIP GALVANIZED OR MECHANICALLY DEPOSITED ZINC COATED #10 SDS AT 6" O.C. IN FIELD AND AT 3" O.C. AT PANEL TO PANEL POINTS
5. ROOFING (SEE ARCHITECTURAL) ON 1/2" FIRE RETARDANT PLYWOOD OVER LG STUD FRAMING (SEE S-301 AND S-302. FASTEN TO TRUSSES WITH HOT DIP GALVANIZED OR MECHANICALLY DEPOSITED ZINC COATED #10 SDS AT 6" O.C. IN FIELD AND AT 3" O.C. AT PANEL TO PANEL POINTS

PLAN NOTES

1. DESIGN JOIST GIRDERS FOR ADDITIONAL LOADS SHOWN ON PLAN.
2. JOIST DESIGNER: USE A MAX DEAD LOAD OF 10 PSF FOR UPLIFT DESIGN USING THE LOAD COMBINATION OF .5 DL - 1.0 WL. SEE S-1.04 FOR WIND LOADS

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