

PARTITION TYPE: A							PARTITION TYPE: D													
STUD TO STRUCTURE (SEE DETAILS)	1 HR-RATED W/ GYP. BD. TO STRUCTURE	NON-RATED W/ GYP. BD. TO STRUCTURE	NON-RATED W/ GYP. BD. TO 6" ABOVE CEILING	STUD & GYP. BD. TO 6" ABOVE CEILING	STUD & GYP. BD. TO BOTTOM OF CEILING	METAL STUD SIZE	3-1/2"	2-1/2"	3-5/8"	3-5/8"	6"	6"	5/8"	5/8"	5/8"	5/8"	5/8"	5/8"	5/8"	5/8"
STUD TO STRUCTURE (SEE DETAILS)	FIRE-RATED W/ GYP. BD. TO STRUCTURE	NON-RATED W/ GYP. BD. TO STRUCTURE	NON-RATED W/ GYP. BD. TO 6" ABOVE CEILING	STUD & GYP. BD. TO 6" ABOVE CEILING	STUD & GYP. BD. TO BOTTOM OF CEILING	METAL STUD SIZE	3-1/2"	2-1/2"	3-5/8"	3-5/8"	6"	6"	5/8"	5/8"	5/8"	5/8"	5/8"	5/8"	5/8"	5/8"
ACOUSTICAL INSULATION	NO	YES	NO	YES	NO	ACOUSTICAL INSULATION	NO	YES	NO	YES	NO	YES	NO	YES	NO	YES	NO	YES	NO	YES
BASE PARTITION THICKNESS	3-5/8"	3-3/4"	4-7/8"	4-7/8"	7-1/4"	BASE PARTITION THICKNESS	3-1/8"	3-1/8"	4-1/4"	4-1/4"	6-5/8"	6-5/8"	3-1/8"	3-1/8"	4-1/4"	4-1/4"	6-5/8"	6-5/8"	6-5/8"	6-5/8"
UL #						UL #														
REMARKS						REMARKS														

CONSTRUCTION PLAN NOTES

- G1. BRACE PARTITIONS TO STRUCTURE IN ACCORDANCE WITH MOST UP-TO-DATE INTERNATIONAL BUILDING CODE SECTION AND ASCE FOR SEISMIC SUPPORT. COORDINATE WITH LOCAL JURISDICTION FOR RELEVANT ISSUE OF LISTED CODE REFERENCES AND FOR ANY LOCAL OR STATE CODE AMENDMENTS.
- G2. PARTITION COMPONENTS SHALL PROVIDE A FIRE RESISTIVE ASSEMBLY WITH FIRE RATINGS AS NOTED FOR EACH TYPE. MATERIALS AND COMPONENTS OF PARTITION ASSEMBLY AND MATERIAL WITHIN WALL SHOULD BE NON-COMBUSTIBLE OR FIRE RESISTIVE TREATED MATERIAL.
- G3. DOOR HARDWARE FUNCTION SHALL PROVIDE MECHANICAL FREE EGRESS TO EGRESS SIDE OF DOOR.
- G4. REFERENCE CONSTRUCTION PLAN SHEETS FOR PARTITION TYPES.
- G5. PROVIDE FIRE EXTINGUISHERS PER INTERNATIONAL BUILDING CODE. COORDINATE WITH LOCAL JURISDICTION FOR RELEVANT ISSUE OF LISTED CODE REFERENCES AND FOR ANY LOCAL OR STATE CODE AMENDMENTS. G.C. TO COORDINATE FINAL PLACEMENT AND QUANTITIES OF FIRE EXTINGUISHERS WITH FIRE MARSHAL ON SITE. EXTINGUISHERS COMMONLY SUPPLIED BY CUSTOMER AREAS SHALL BE IN SEMI-RECESSED CABINETS, UNLESS NOTED OTHERWISE.
- G6. ALL ANGLES ARE PARALLEL, PERPENDICULAR, OR 45 DEGREE UNLESS NOTED OTHERWISE.
- G7. BUILDING ELEMENTS / MATERIALS TO BE IN CONSTRUCTION, UNO.
- G8. ALIGNMENT DIMENSIONS SHALL BE FINISHED TO FINISH SURFACE.
- G9. DIMENSIONS ARE FROM FACE OF FINISHED SURFACE ON NEW PARTITION SURFACE, UNO. CENTERLINE DIMENSIONS SHALL BE MEASURED FROM CENTERLINE OF ASSEMBLY, FIXTURE, OR CASE.
- G11. ALL TRADES AND GENERAL CONTRACTOR(S) SHALL REFERENCE ALL ASSOCIATED DRAWINGS (ENGINEERING, VENDOR SHOP DRAWINGS PROVIDED BY OWNER, ETC.) AND COORDINATE REQUIREMENTS FOR INSTALLATION OF ALL SPECIFIED SYSTEMS.
- PROVIDE SECURE CONSTRUCTION SITE PERIMETER DURING CONSTRUCTION. REQUIRED MEANS OF EGRESS & EXITS SHALL BE MAINTAINED AT ALL TIMES DURING CONSTRUCTION.

CONSTRUCTION PLAN KEYNOTES

- ITEMS LABELLED WITH KEYED NOTE INDICATOR ARE FOR SPECIFIC LOCATIONS ON PLANS
- 1120 SOFFIT/HEADER ABOVE SHOWN DASHED, TYP.
- 1121 COUNTER AND/OR CABINET MILLWORK BY GENERAL CONTRACTOR, UNO.
- 1122 MOP SINK, REFER TO PLUMBING DRAWINGS.
- 1123 PROVIDE 1/4" COPPER WATER LINE WITH EMERGENCY SHUT-OFF VALVE FOR REFRIGERATOR WITH CUMMACKER BY GC. REF. PLUMBING DOCUMENTS AND EQUIPMENT PLAN.
- 1124 GC TO PROVIDE 4' X 8' FIRE RESISTIVE TREATED PLYWOOD PANEL. PAINT TO MATCH ADJACENT WALL.
- 1126 SPLIT PHASE A/C UNIT PROVIDED ABOVE DOOR. REFER TO ENG. DRAWINGS FOR ADDITIONAL INFORMATION.
- 1127 ELECTRICAL PANEL. SEE ELEC. DRAWINGS.
- 1128 PROVIDE HOT/ COLD WATER SUPPLY WITH EMERGENCY SHUT-OFF VALVE. VENT AND DRAIN AT SPECIFIED SINK ASSEMBLY.
- 1129 PROVIDE FIRE RESISTIVE TREATED WOOD BLOCKING WITHIN WALL CAVITY FOR MONITOR AND MOUNT. COORDINATE EXACT LOCATION WITH OWNER. PRIORITY TO CONSTRUCTION.
- 1130 VERIFY EXTENT OF OWNER PROVIDED EQUIPMENT FOR DATA/ELECTRICAL ROOM PRIOR TO CONSTRUCTION.
- 1132 PROVIDE 1/4" COPPER WATER LINE WITH EMERGENCY SHUT-OFF VALVE FOR COFFEE/MAKER BY GC. REF. PLUMBING DOCUMENTS AND EQUIPMENT PLAN.
- 1134 ALIGN HEADER WITH EDGE OF WALL FACE.
- 1135 TERMINATE FURRING PARTITION AT MULLION ABOVE SPANDREL. REFER TO STOREFRONT ELEVATION, WALL SECTIONS & DETAILS FOR MORE INFO.
- 1136 4" ROOF AND OVERFLOW DRAIN PIPES. REF. PLUMBING DWGS.
- 1139 CANVAS AWNING ABOVE. REF. MATERIALS KEY ON SHEET A-201 FOR SPECS, TYP.

CONSTRUCTION PLAN LEGEND

	NEW PARTITIONS		PARTITION CONSTRUCTION TYPE
	SMOKE BARRIER		SCHEDULED DOOR NUMBER
	FIRE EXTINGUISHER CABINET - FULLY RECESSED		KEYNOTE INDICATOR
	FIRE EXTINGUISHER CABINET - SEMI RECESSED		WINDOW TYPE
	FIRE EXTINGUISHER CABINET - SURFACE MOUNTED		REVISION INDICATOR
	FIRE HOSE CABINET		ROOM NAME
	TYPICAL DOOR INSTALLATION CLEARANCES		ROOM NUMBER AND ROOM NAME
			NEW GRID LINE & INDICATOR

	ELEVATIONS		SECTIONS
	BUILDING INTERIOR		WALL SECTION DETAIL
	MILLWORK		MILLWORK DETAIL

	CALLOUT INDICATOR		BUILDING
--	-------------------	--	----------

THE AUTO CLUB GROUP
AAA - CAR CARE CENTER
TAMPA, FL 33607
 1701 NORTH WESTSHORE BLVD.




ISSUANCE

REVISIONS

NO.	DATE	DESCRIPTION

FILE NUMBER: 79890009
 PROJECT MANAGER: PROFESSIONAL
 DRAWN BY: Author
 CHECKED BY: Checker

ENLARGED CONSTRUCTION PLAN
A-111A

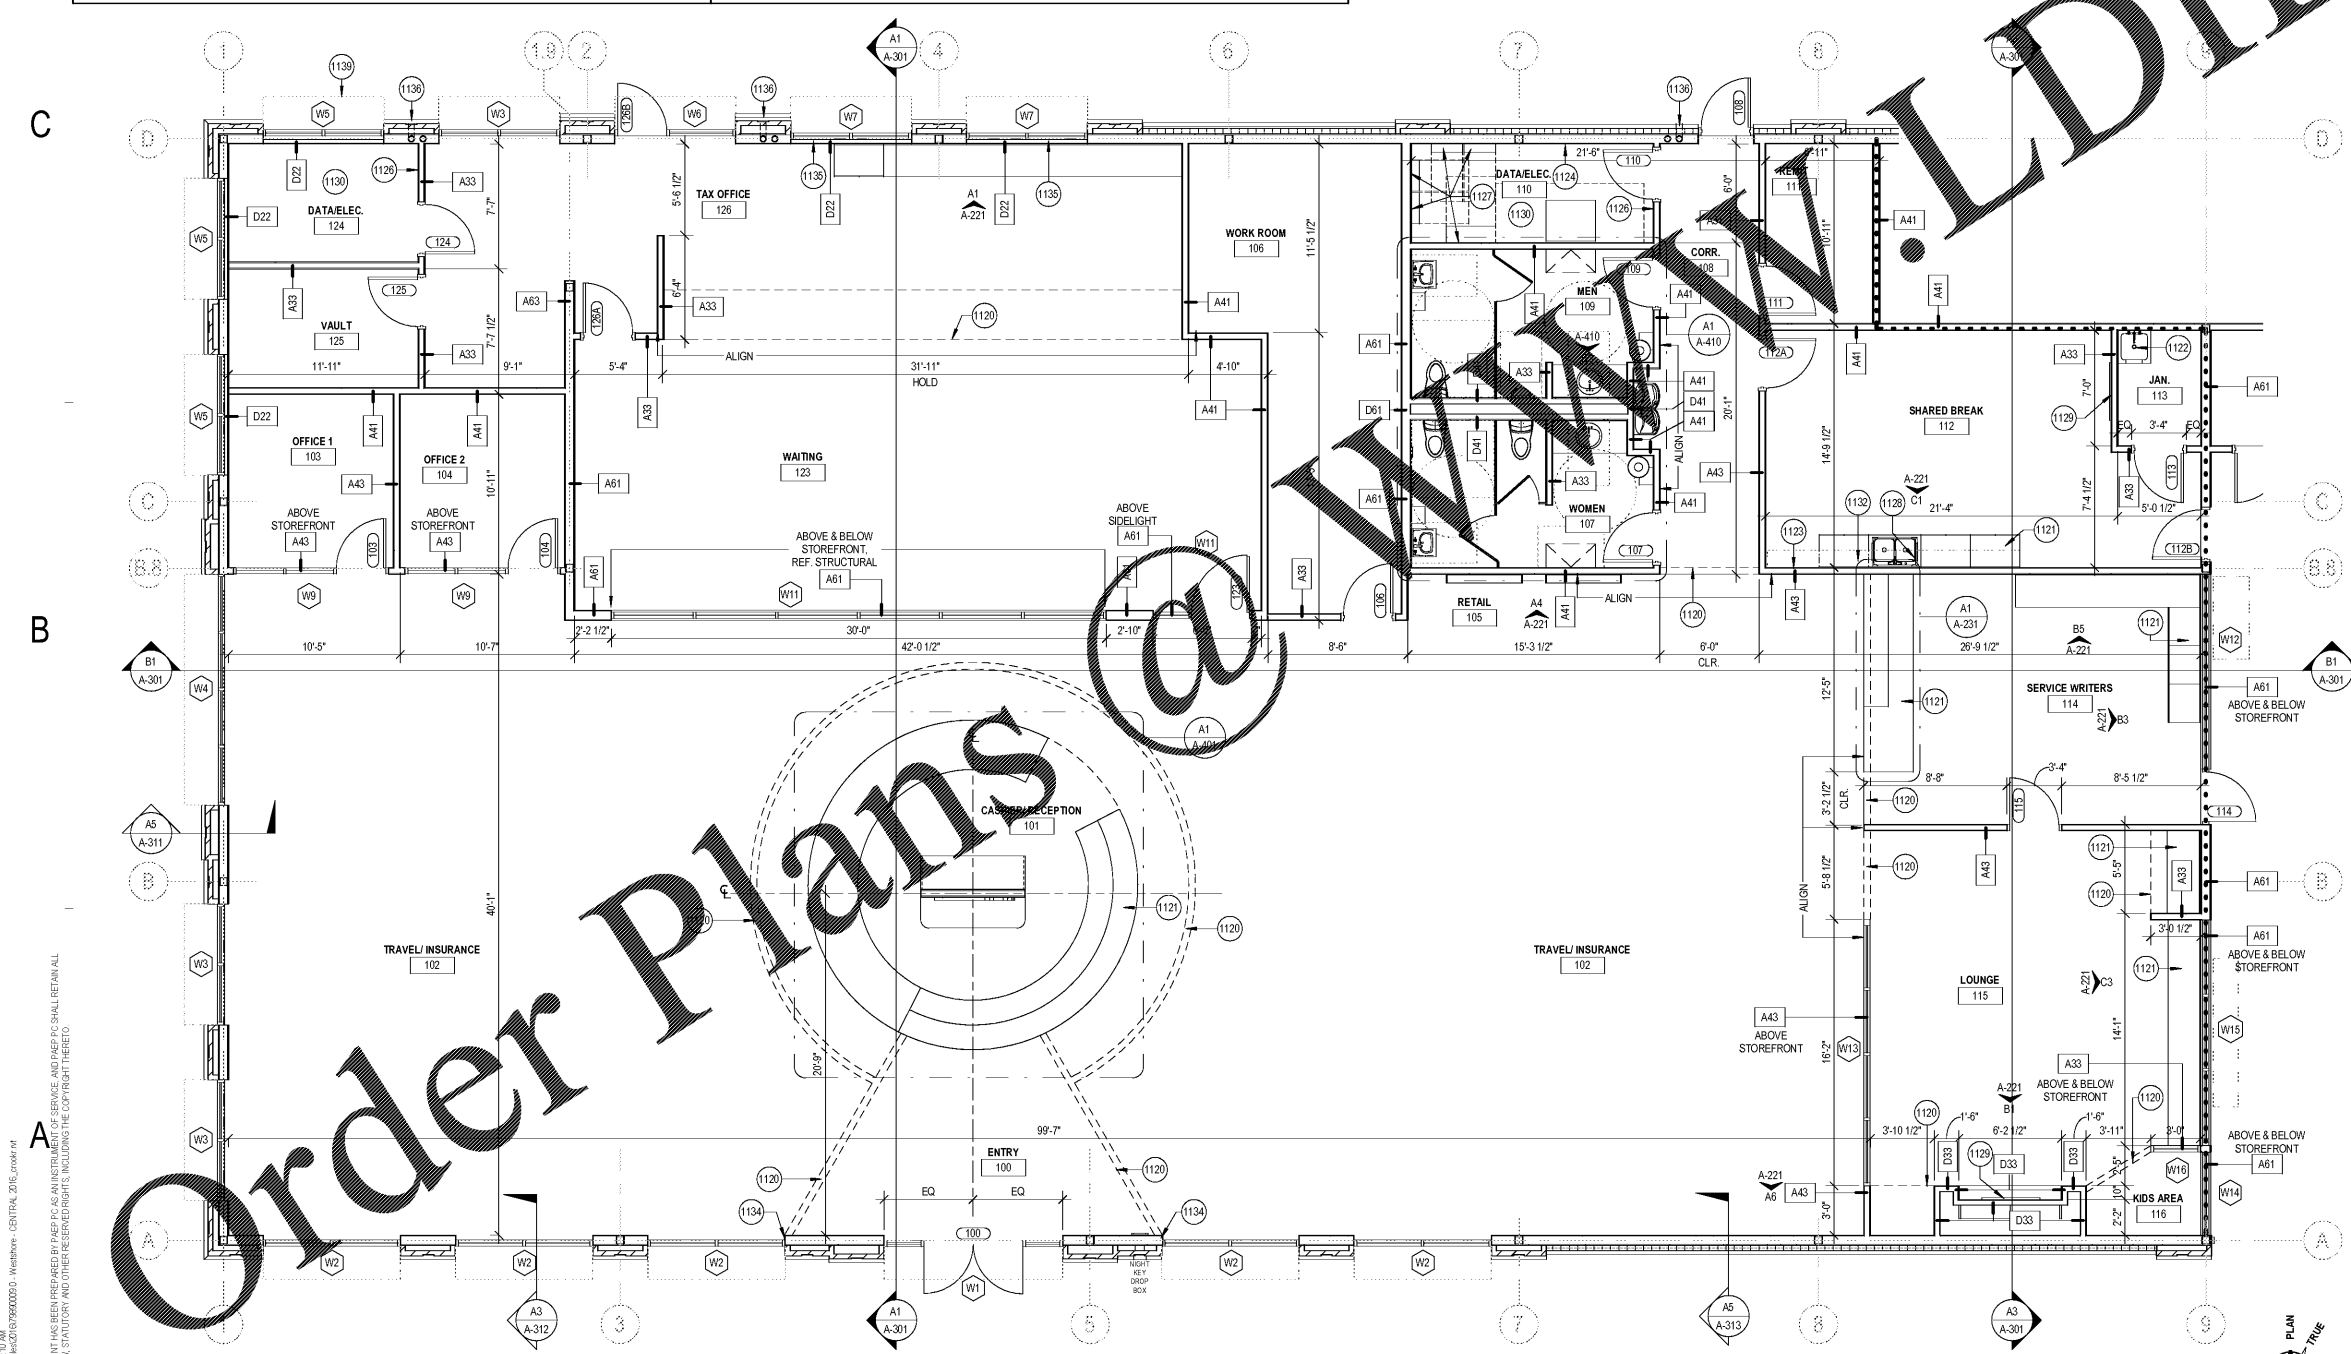

(A1) ENLARGED CONSTRUCTION PLAN
 SCALE: 3/16" = 1'-0"

6/22/2018 10:31 AM
 D:\P\Local\Plan\2018\99000000 - Westshore - CENTRAL - 2018 - 2018.rvt
 THIS DOCUMENT HAS BEEN PREPARED BY AIA/CES AS AN INSTRUMENT OF SERVICE AND AIA/CES SHALL RETAIN ALL COMMON LAW, STATUTORY AND OTHER RESERVED RIGHTS, INCLUDING THE COPYRIGHT THEREIN.