


BARTELL & ASSOCIATES, INC.
 Structural Engineers
 1614 GOVERNMENT ST.
 MOBILE, AL 36604-1102
 PH. 251-473-8354
 FAX 251-473-8356
 © Copyright 2017, Barrell & Associates, Inc.

GMC


2701 1st Avenue S
 Birmingham, AL 35233
 T 205.879.4462
 GMCNETWORK.COM

ALABAMA
 REGISTERED
 PROFESSIONAL
 ENGINEER
 JAMES R. BARRELL
 05/24/2018

TYPICAL LANDING FRAMING SHOWN (EA. FLOOR)
 3 1/2" CLEAR NORMAL WT. CONCRETE OVER 1
 1/2" 20 GAGE GALV. COMPOSITE METAL DECK.
 REINFORCE SLAB WITH 4x4-W4.0xW4.0 FLAT
 SHEETS SET 1" CLEAR FROM TOP OF SLAB.

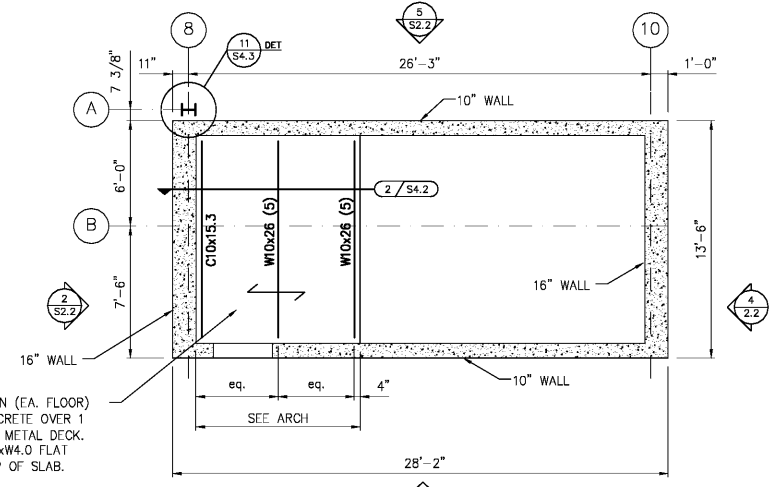


PLAN AT STAIR
DETAIL 1
 SCALE: 1/4"=1'-0" S2.2

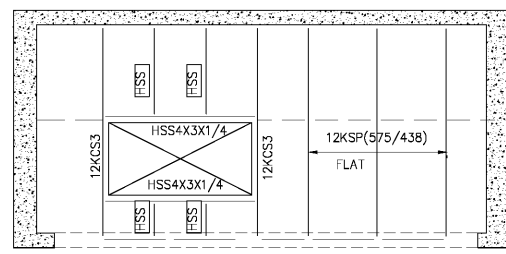

ENLARGED FRAMING PLAN
 ELEVATOR ROOF
DETAIL 6
 SCALE: 1/4"=1'-0" S2.2

[HSS] DENOTES HSS 3x2 3/4x1/4 PLATWSE

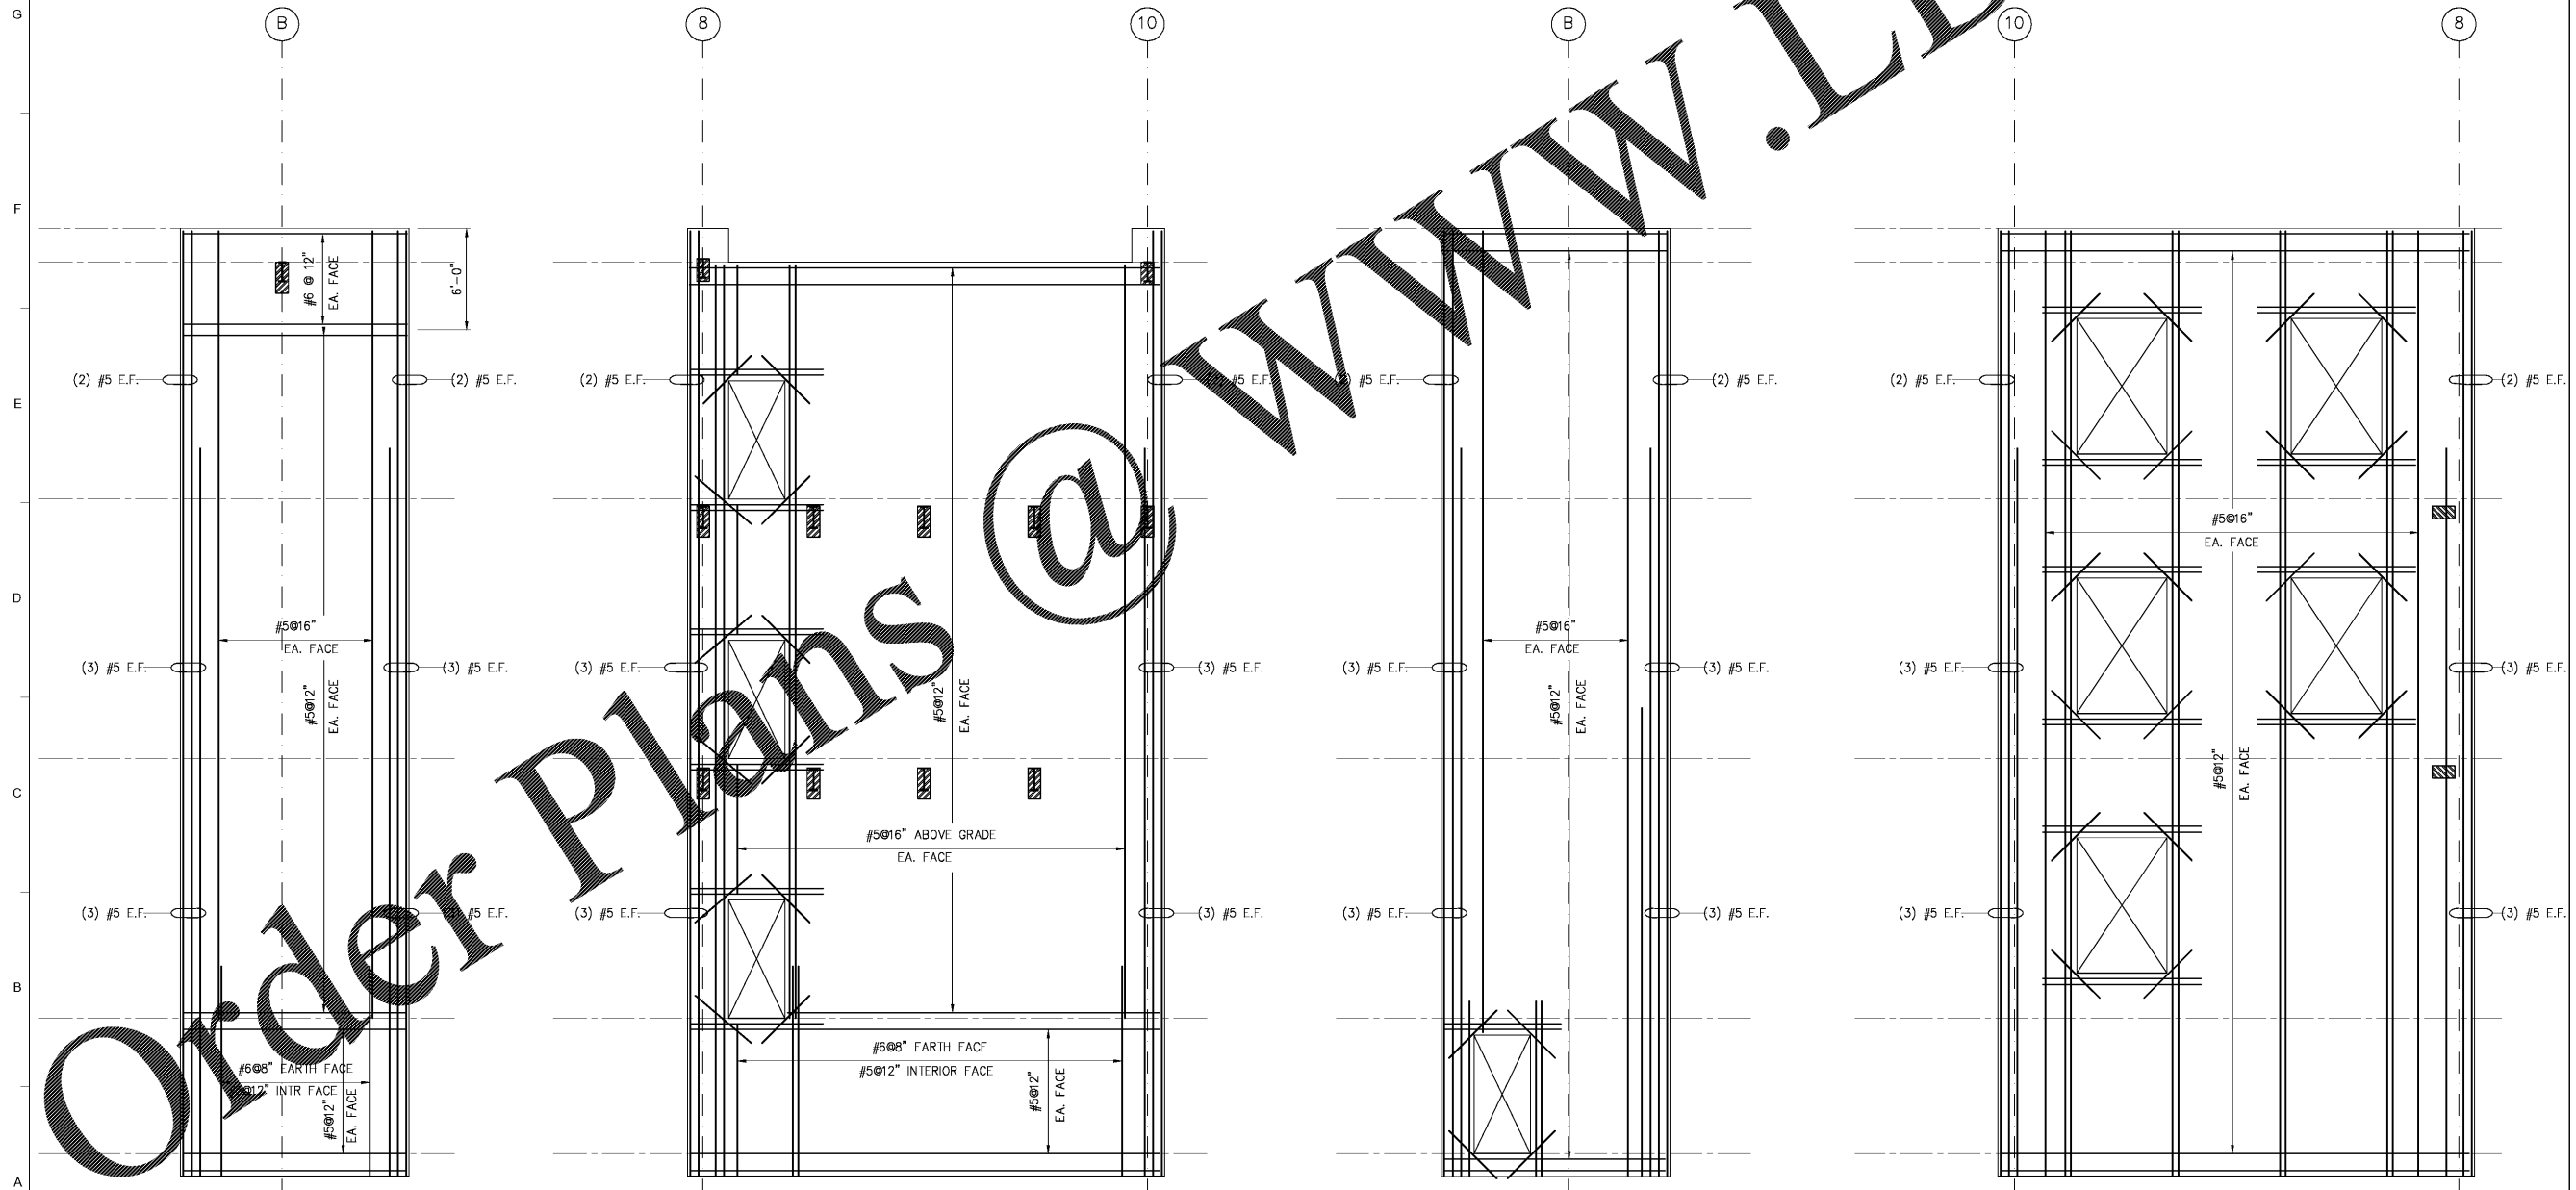

ELEVATION 2
 SCALE: 1/4"=1'-0" S2.2

ELEVATION 3
 SCALE: 1/4"=1'-0" S2.2

ELEVATION 4
 SCALE: 1/4"=1'-0" S2.2

ELEVATION 5
 SCALE: 1/4"=1'-0" S2.2

USA SIMULATION LAB
 MOBILE, ALABAMA
 ABC # 2017372
 GMC # AMOB160019

CONCRETE WALL - ENLARGED
 PLANS AND ELEVATIONS

S2.2
 SHEET OF

ISSUE	DATE
100% 2018.04.18	
Issue for Bid 2018.05.25	

DRAWN BY: ISJM
 CHECKED BY: IJAR

Order Plans @ WWW.LDILine.com